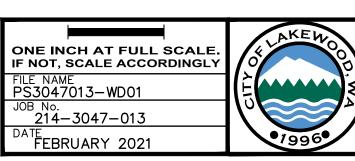


#### GRAVITY BLOCK WALL - FILL WALL (4≤H≤6')

DETAIL 2

NOT TO SCALE

<u> </u>						
PAT	Δ	REVISIONS	DATE	BY	DESIGNED  M. TSUN	
					DRAWN	
WD1					B. PURGANAN	
≥					CHECKED	
::					D. PROCTOR	
١٧٥٧					APPROVED	









PROJECT NAME

JBLM NORTH ACCESS ROAD IMPROVEMENTS - PHASE 1

**NOTES:** 

ELEVATIONS.

SPECIFIC REQUIREMENTS.

1. RESTORE DISTURBED EXISTING GROUND WITH NATIVE SOIL

BACKFILL AND SEEDING, ANY LANDSCAPING SHALL BE

2. FOR FILL WALLS, OFFSET DISTANCE SHOWN ON THE WALL

CUT WALLS, OFFSET DISTANCE SHOWN ON THE WALL

LAYOUT PLAN IS AT OUTSIDE EDGE OF THE TOP BLOCK. FOR

LAYOUT PLAN IS AT THE BOTTOM OF EXPOSED WALL FACE.

SPECIAL PROVISIONS FOR WALL DESIGN REQUIREMENTS.

ALL CONSTRUCTION MUST CONFORM TO MANUFACTURER'S

DESIGN LOAD FOR FILL WALLS

LIVELOAD FOR SIDEWALK

DEADLOAD

100 PSF

NONE

OFFSET 2 FEET MIN FROM FACE OF WALL.

3. SEE WA SHEETS FOR TOP AND BOTTOM OF WALL


4. FILL BLOCK UNITS HOLLOW CORES WITH GROUT. SEE


LAKEWOOD, WASHINGTON


**WALL DETAILS** 

DRAWING NO. 136 OF 153

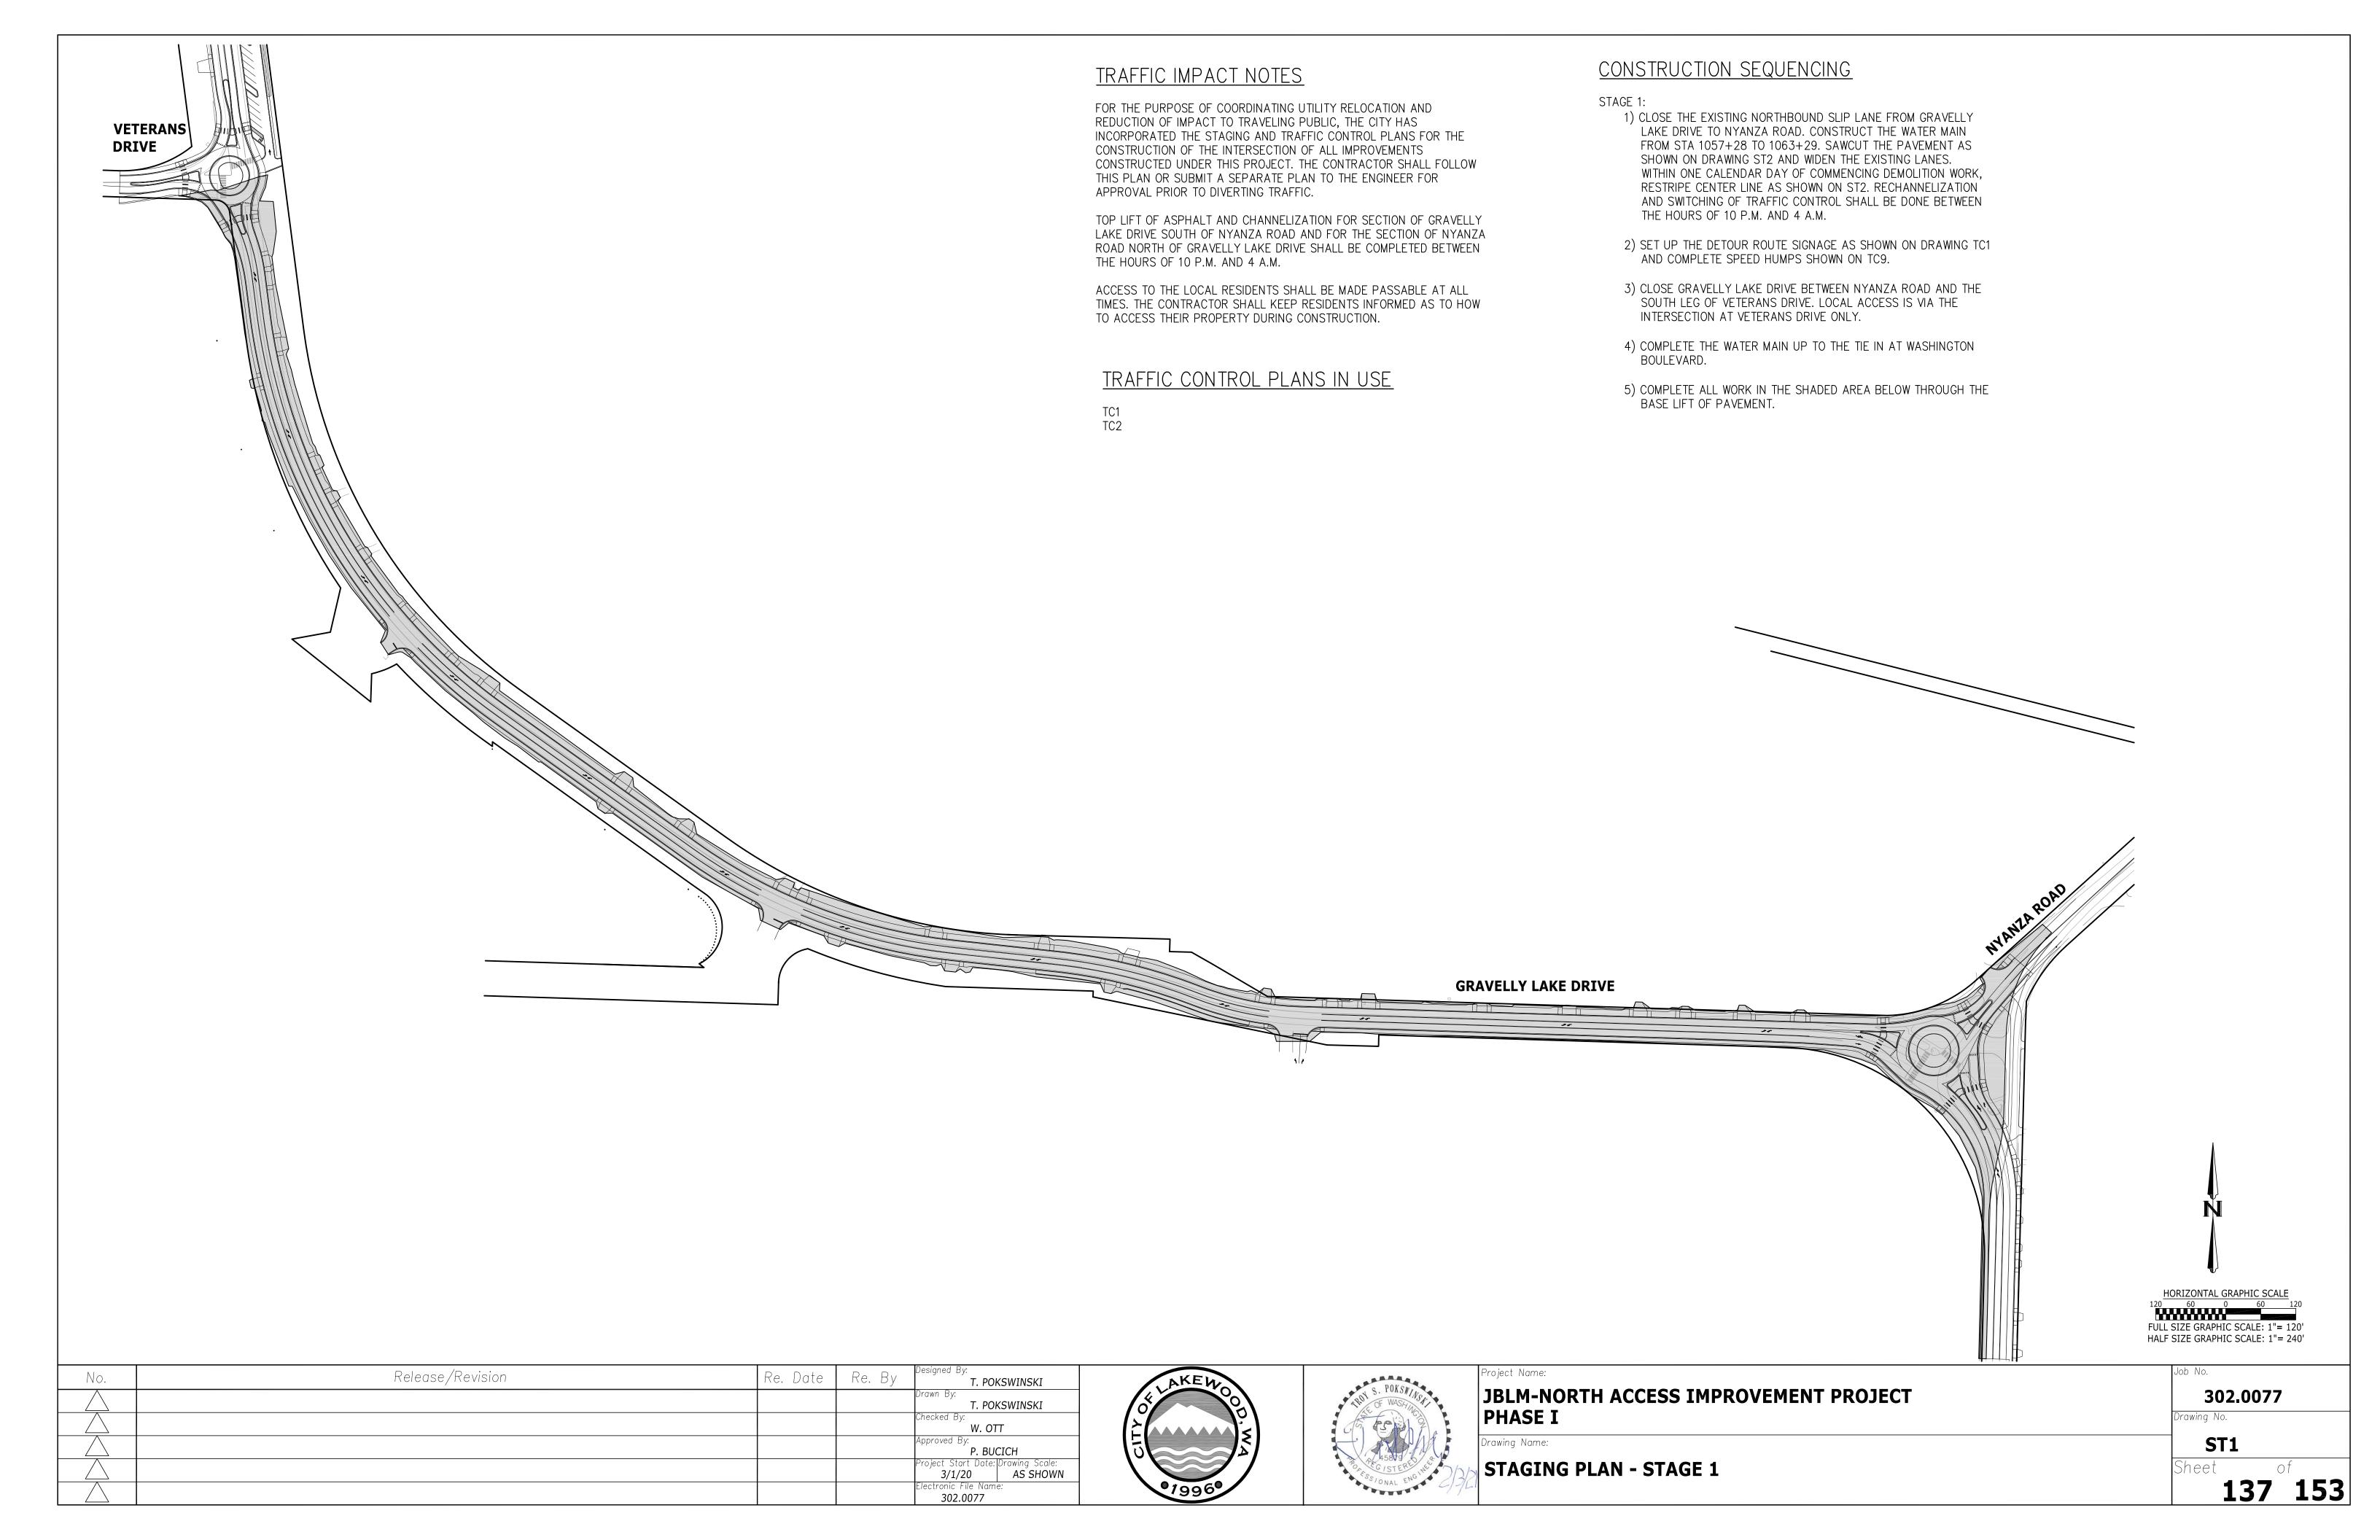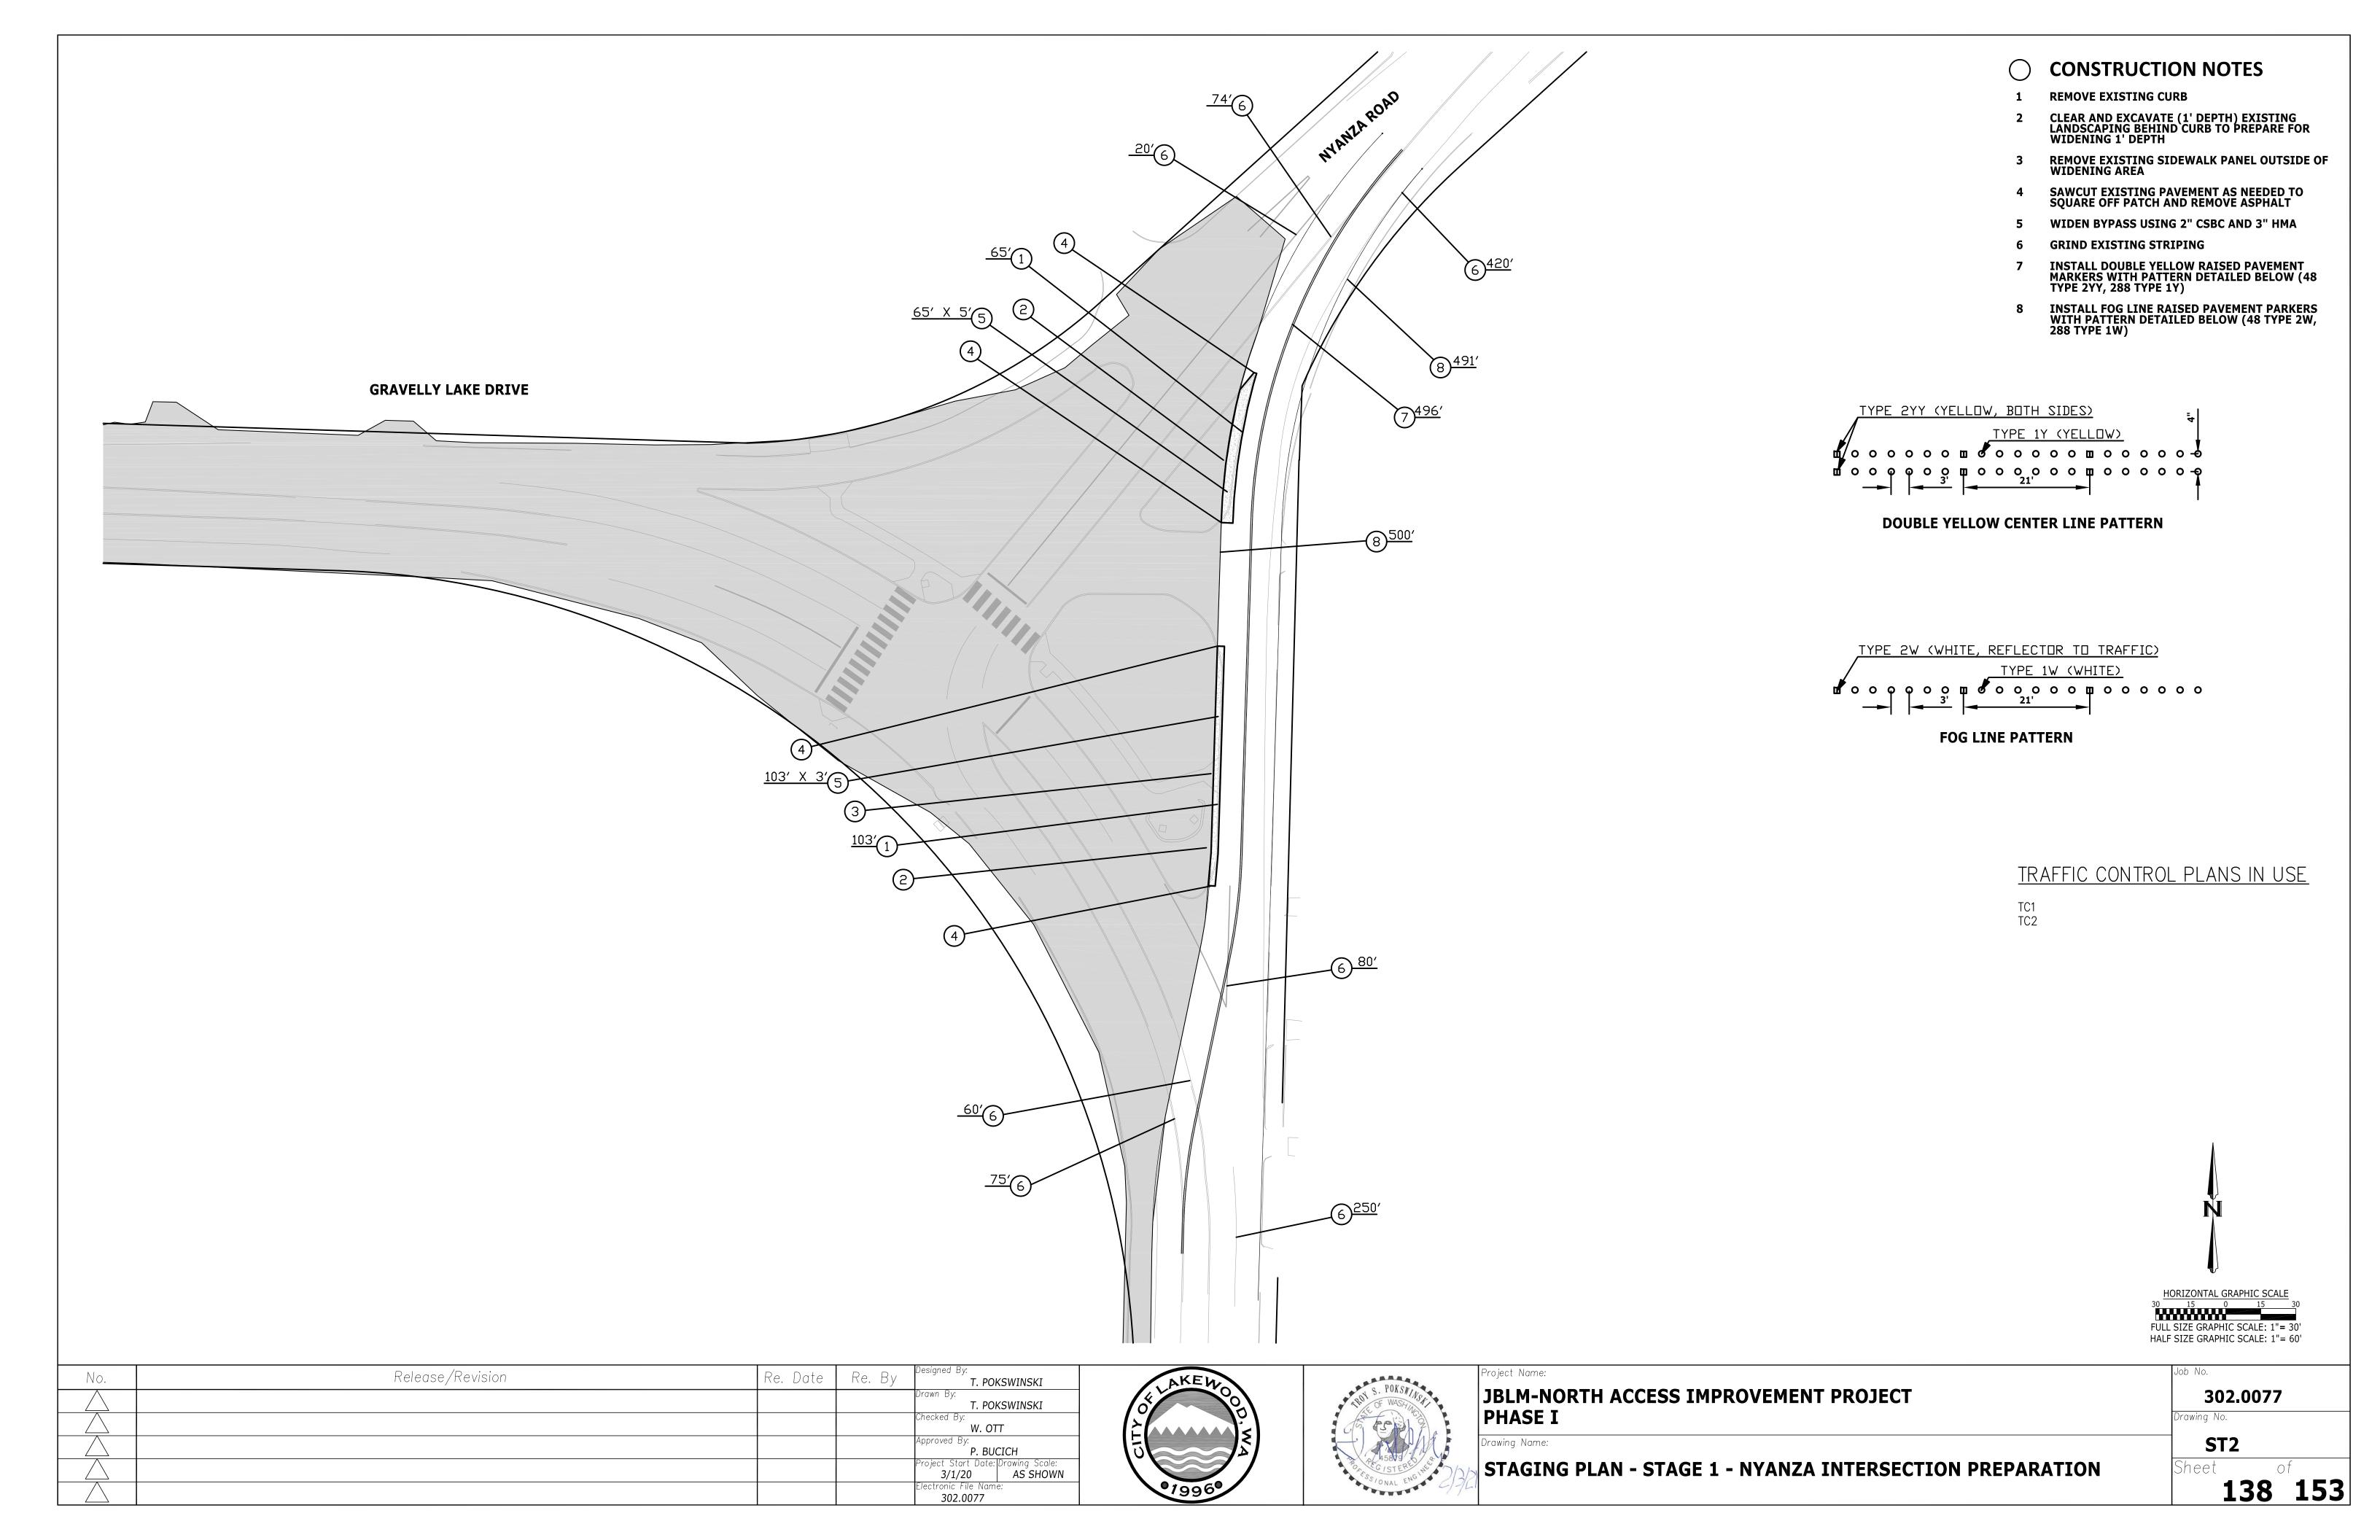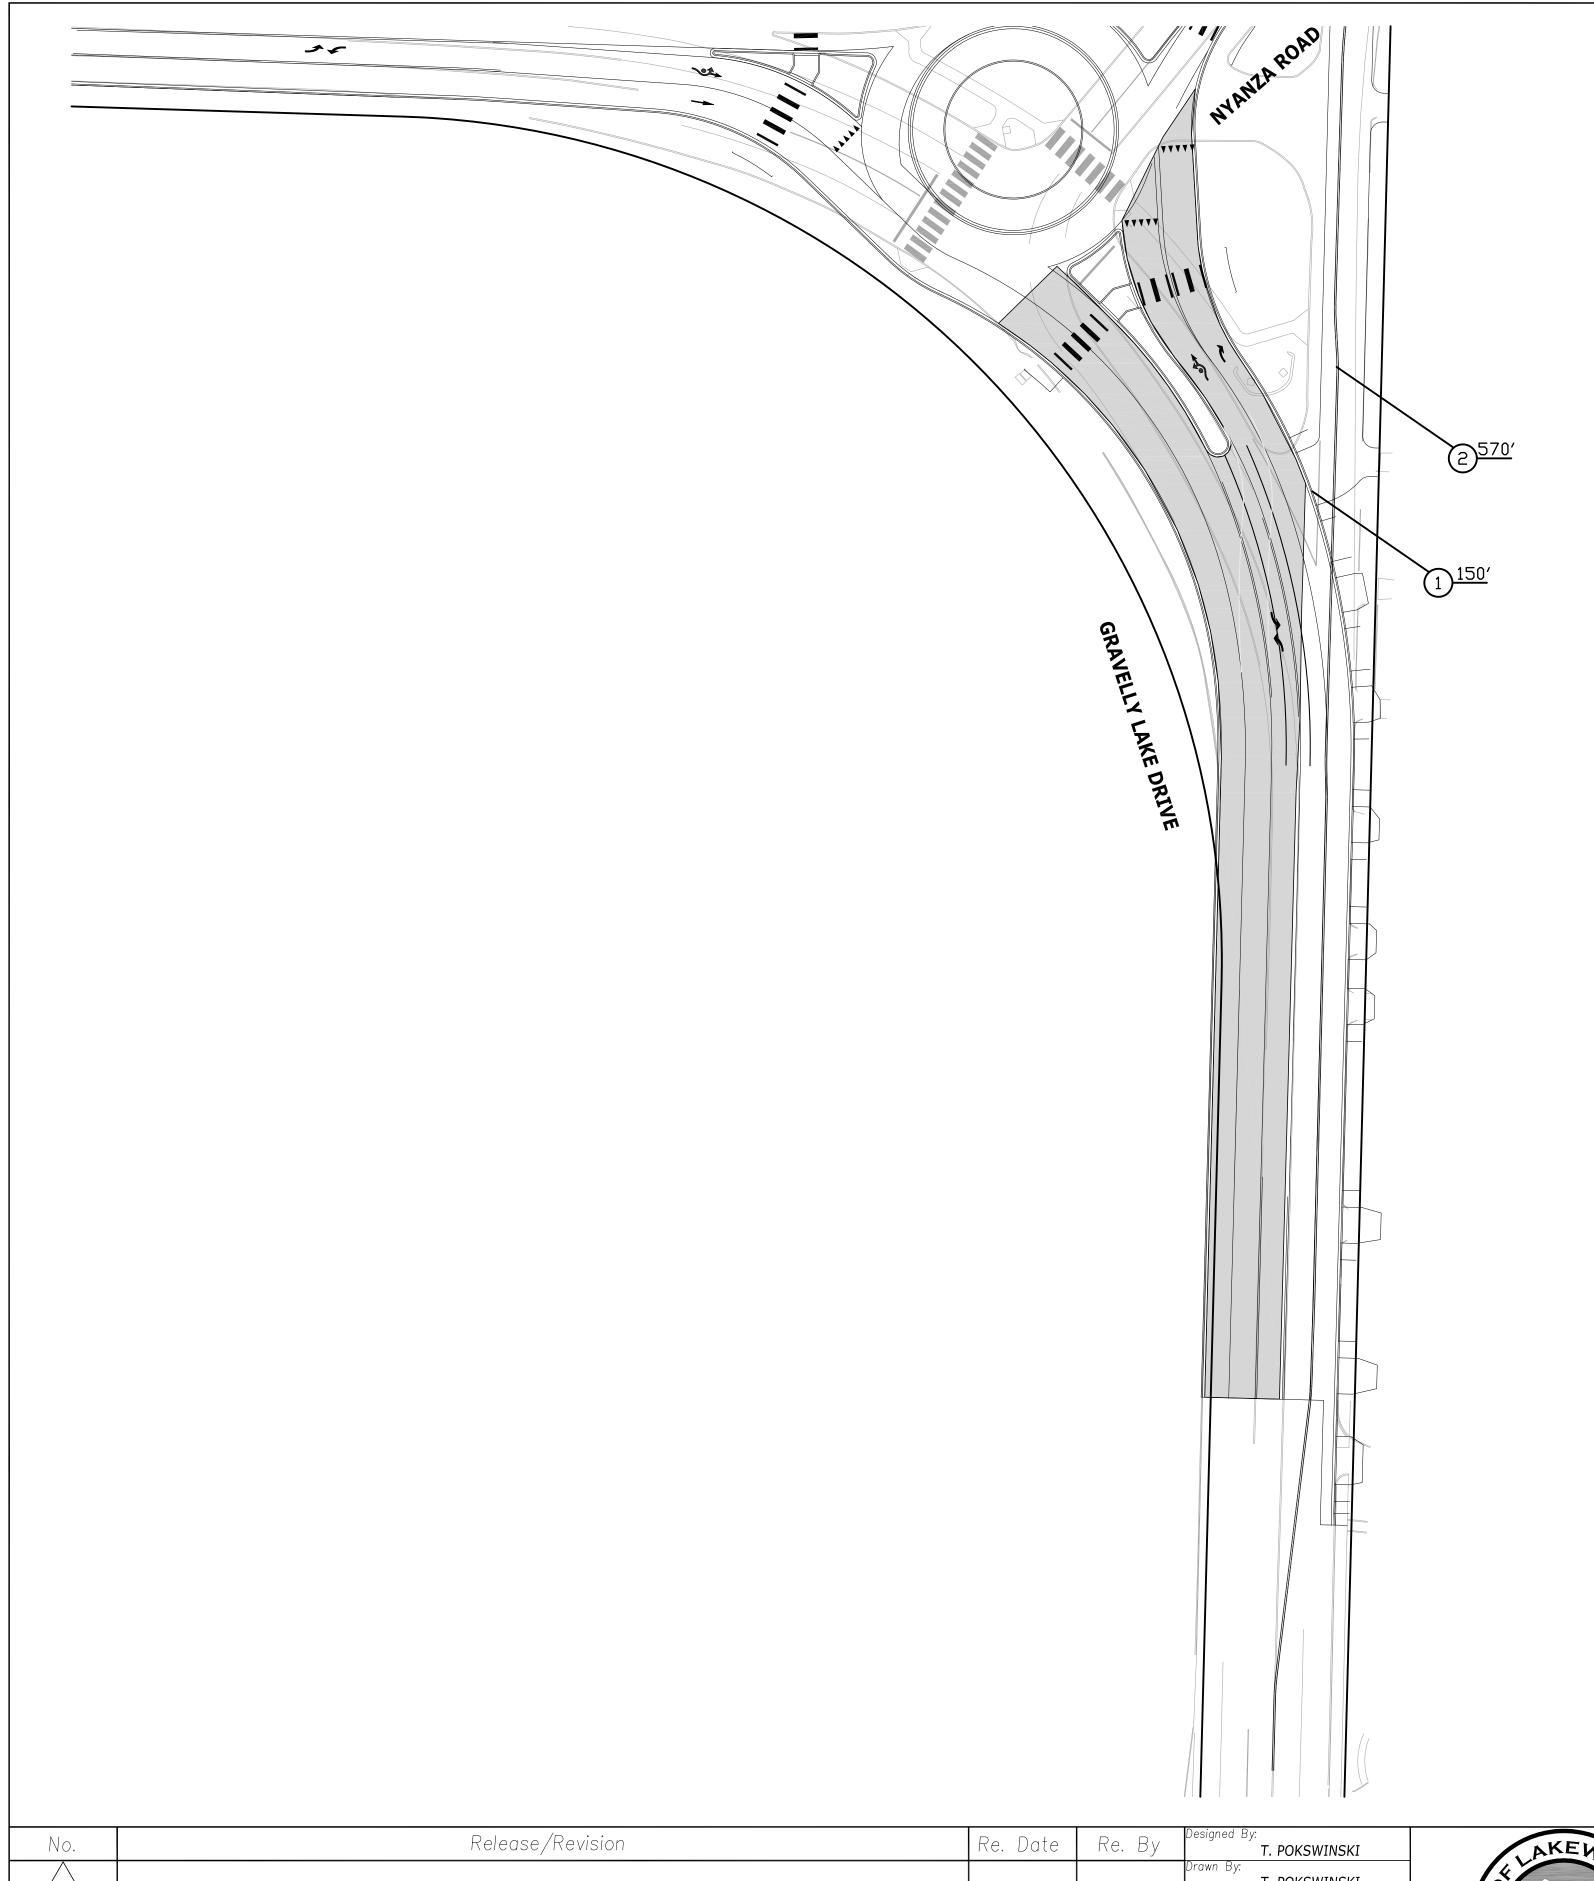WD1







# **CONSTRUCTION NOTES**

- REMOVE RAISED PAVEMENT MARKERS
- 2 INSTALL DOUBLE YELLOW TEMPORARY TRAFFIC STRIPING TAPE

# CONSTRUCTION SEQUENCING


STAGE 2:

1) ONCE COMPLETION OF THE IMPROVEMENTS OF PHASE 1 ARE NEARING COMPLETION (BASE LIFT WITHIN ONE WEEK OF BEING PLACED), MODIFY THE TRAFFIC CONTROL ALONG GRAVELLY LAKE DRIVE SOUTH OF NYANZA AS SHOWN ON THIS SHEET. RECHANNELIZATION AND SWITCHING OF TRAFFIC CONTROL SHALL BE DONE BETWEEN THE HOURS OF 10 P.M. AND 4 A.M.

- 2) REMOVE EXISTING PAVEMENT AND GRADE FOR BASE COURSE IN SHADED AREA ON THIS SHEET.
- 3) INSTALL BASE LIFT OF PAVING.

# TRAFFIC CONTROL PLANS IN USE

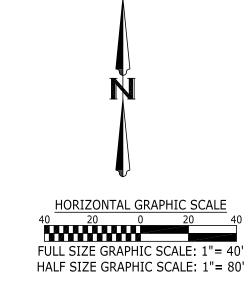TC1 TC2 TC3



No.	Release/Revision	Re. Date	Re. By	Designed By:  T. POKSWINSKI
				Drawn By:  T. POKSWINSKI
				Checked By: W. OTT
				Approved By: P. BUCICH
				Project Start Date: Drawing Scale:  3/1/20 AS SHOWN
				Electronic File Name:






roject Nume.	
JBLM-NORTH ACCESS IMPROVEMENT PROJECT PHASE I	
Drawing Names	

STAGING PLAN - STAGE 2 - ROAD REBUILD SOUTH OF NYANZA WEST SIDE Sheet

ST3

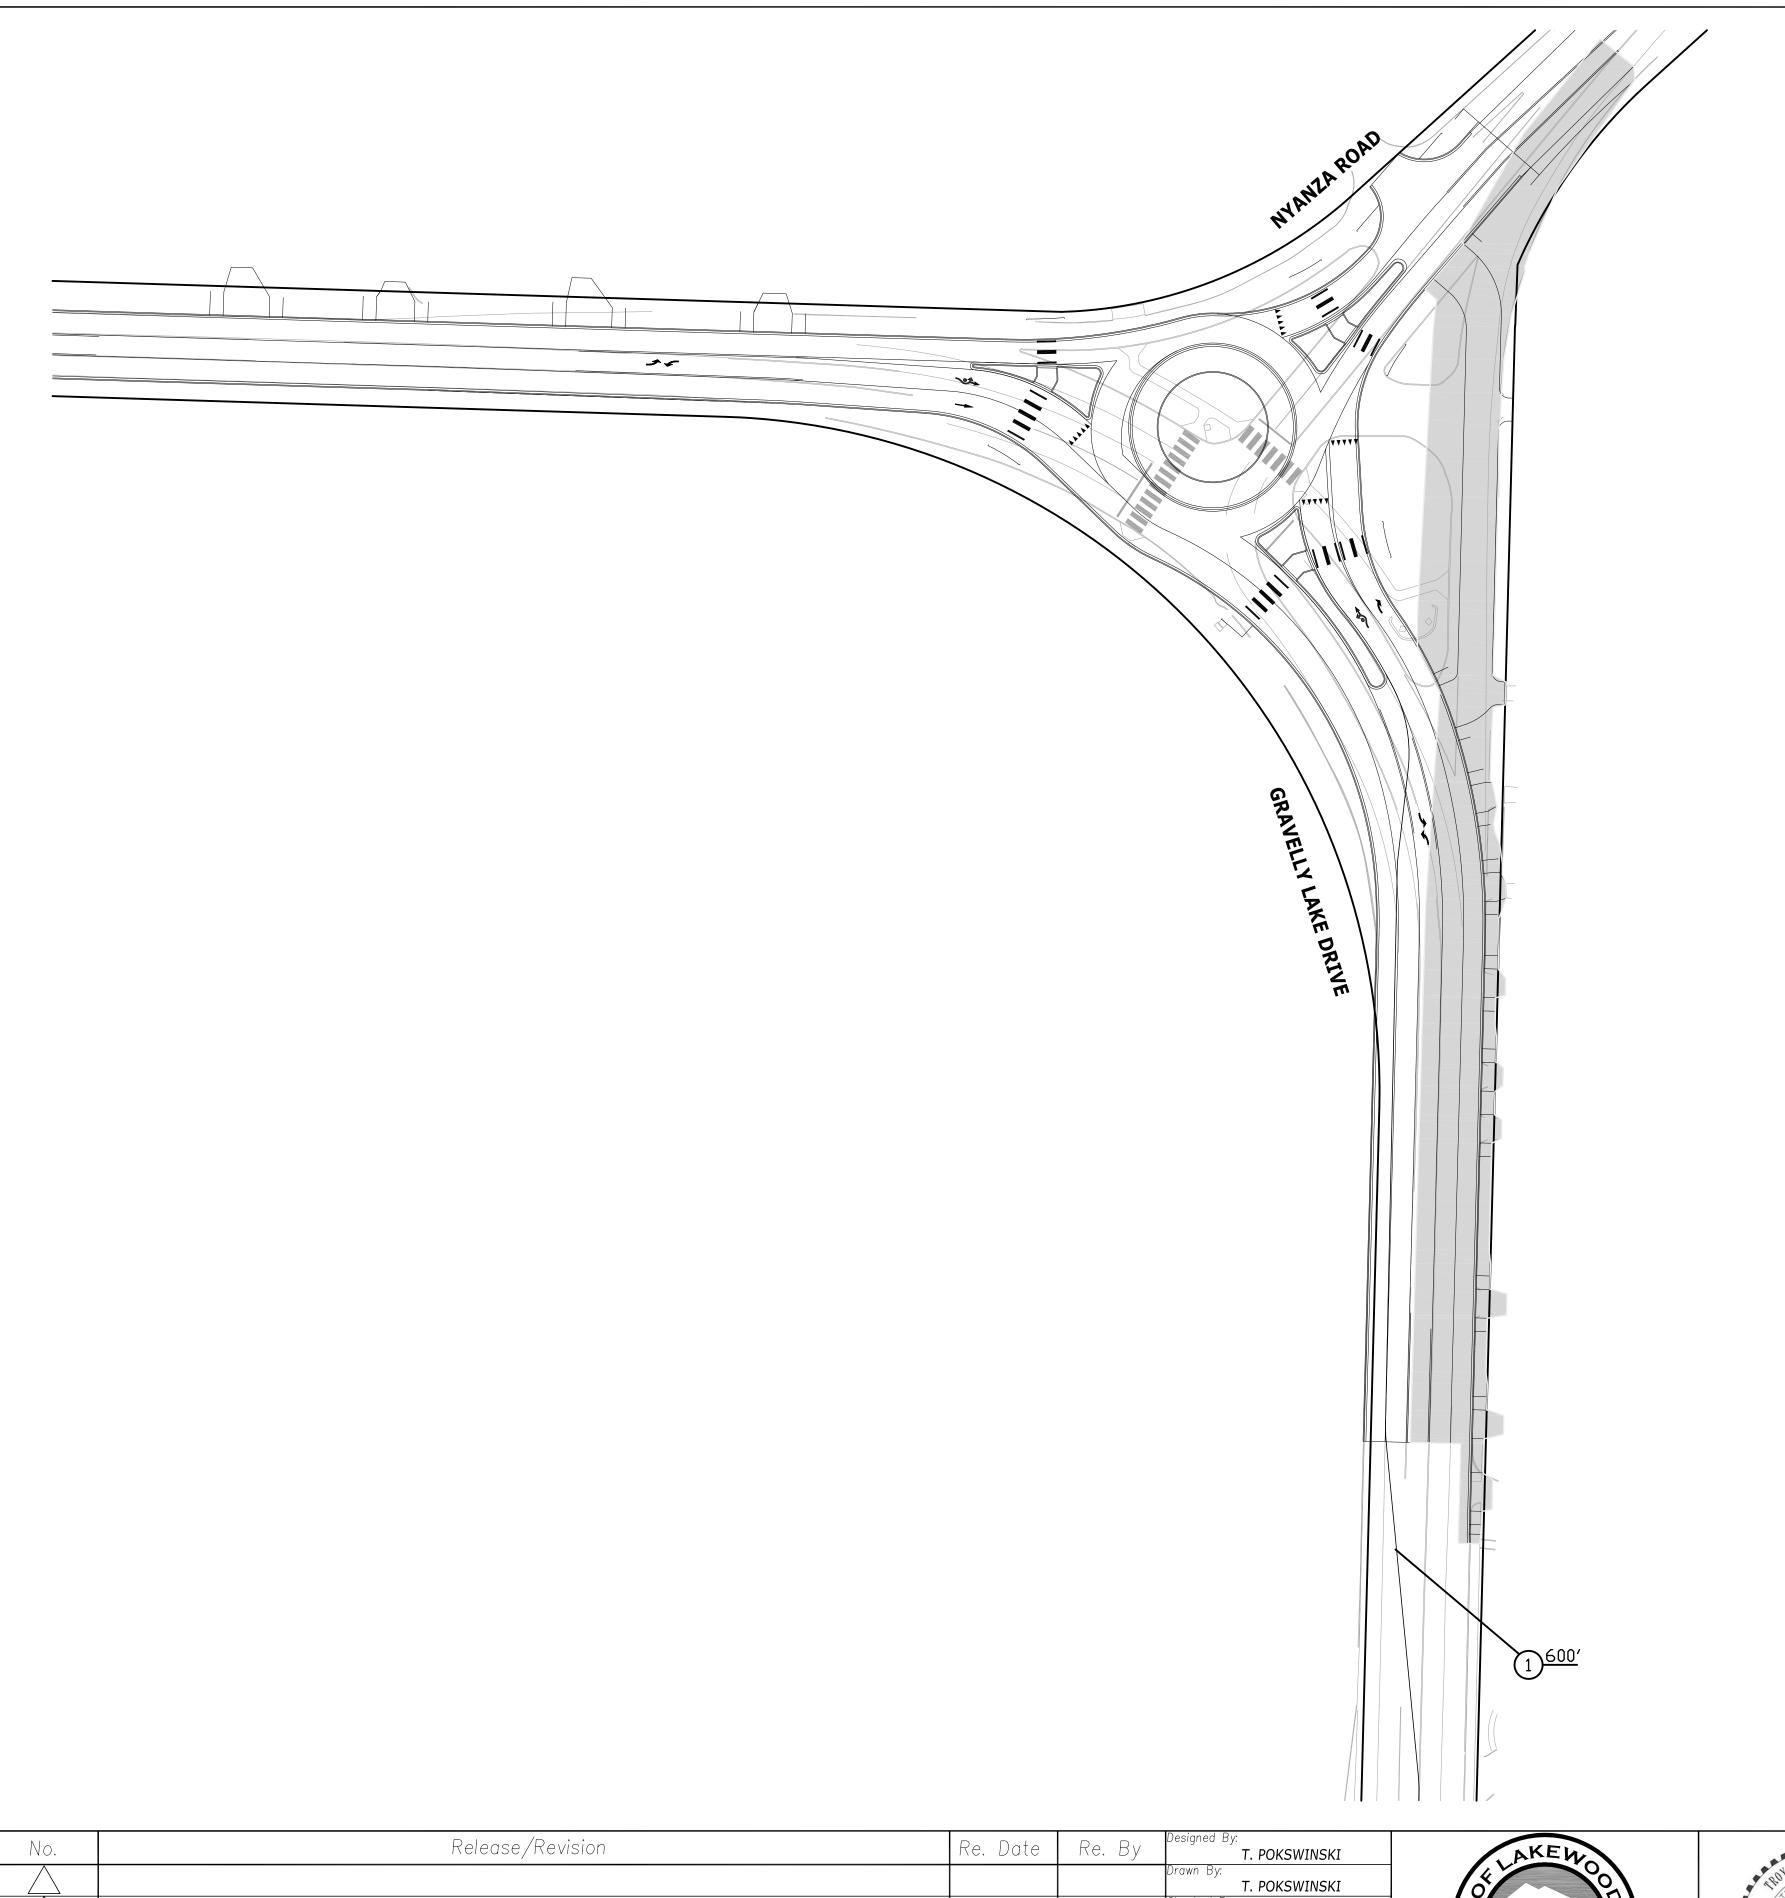302.0077



# **CONSTRUCTION NOTES**

INSTALL DOUBLE YELLOW TEMPORARY TRAFFIC STRIPING TAPE

# CONSTRUCTION SEQUENCING

STAGE 3:

- 1) ONCE COMPLETION OF THE IMPROVEMENTS OF STAGE 2 ARE COMPLETED (BASE LIFT COMPLETED), MODIFY THE TRAFFIC CONTROL ALONG GRAVELLY LAKE DRIVE SOUTH OF NYANZA AS SHOWN ON THIS SHEET. RECHANNELIZATION AND SWITCHING OF TRAFFIC CONTROL FOR THIS STAGE CAN BE DONE AT ANY TIME OF THE DAY.
- 2) COMPLETE WORK IN THE SHADED AREA THROUGH BASE LIFT OF PAVING. STAGE 3 AND STAGE 4 CAN BE DONE CONCURRENTLY FOLLOWING THE SHIFT IN TRAFFIC NOTED IN STEP 1 ABOVE.
- 3) ONCE STAGE 4 IS COMPLETED WITH THE TIE IN TO VETERANS, CLOSE THE ROUNDABOUT LEG TO NORTHBOUND NYANZA AT GRAVELLY AND COMPLETE ALL CURB, SIDEWALK AND HMA.

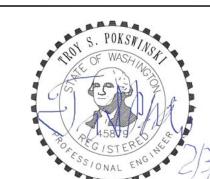
# TRAFFIC CONTROL PLANS IN USE

TC1 TC2 TC4

FULL SIZE GRAPHIC SCALE: 1"= 50'
HALF SIZE GRAPHIC SCALE: 1"= 100'

No.	Release/Revision	Re. Date	Re. By	T. POKSWINSKI
				Drawn By:  T. POKSWINSKI
				Checked By: W. OTT
				Approved By: P. BUCICH
				Project Start Date: Drawing Scale:  3/1/20 AS SHOWN
				Electronic File Name: 302.0077







Dject Name:	
BLM-NORTH ACCESS IMPROVEMENT PROJECT HASE I	
nwing Name:	

302.0077

ST4 140 153

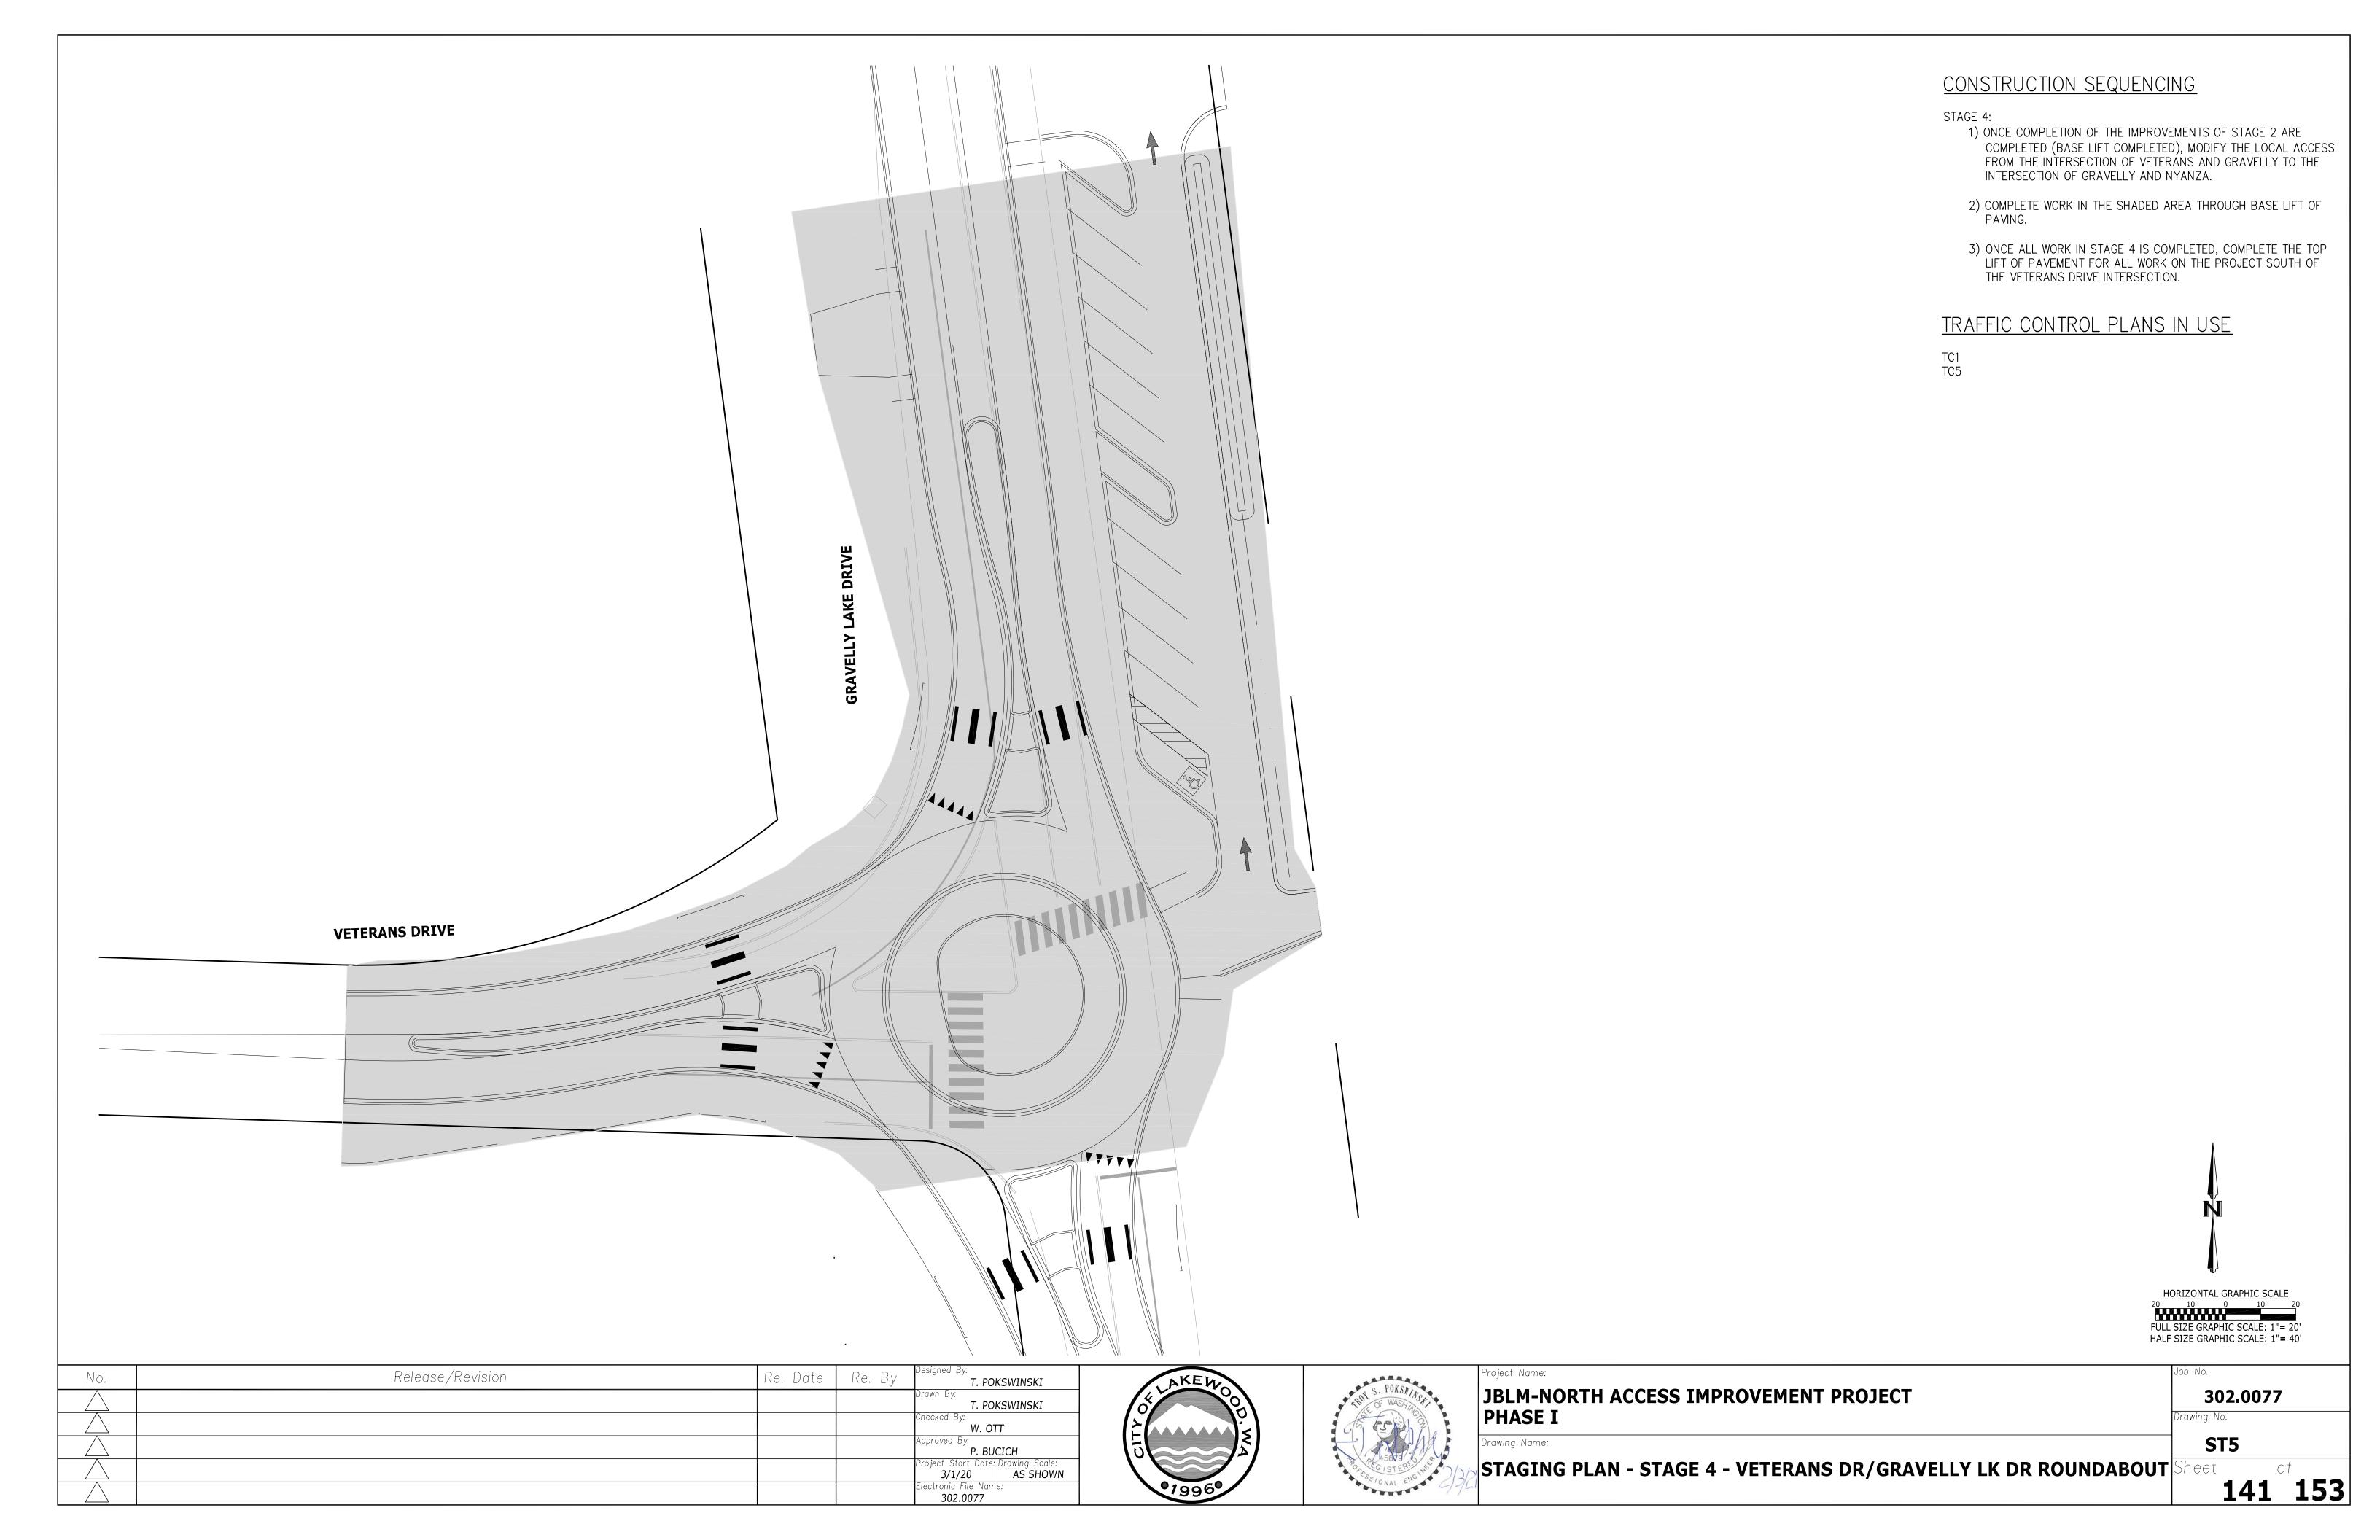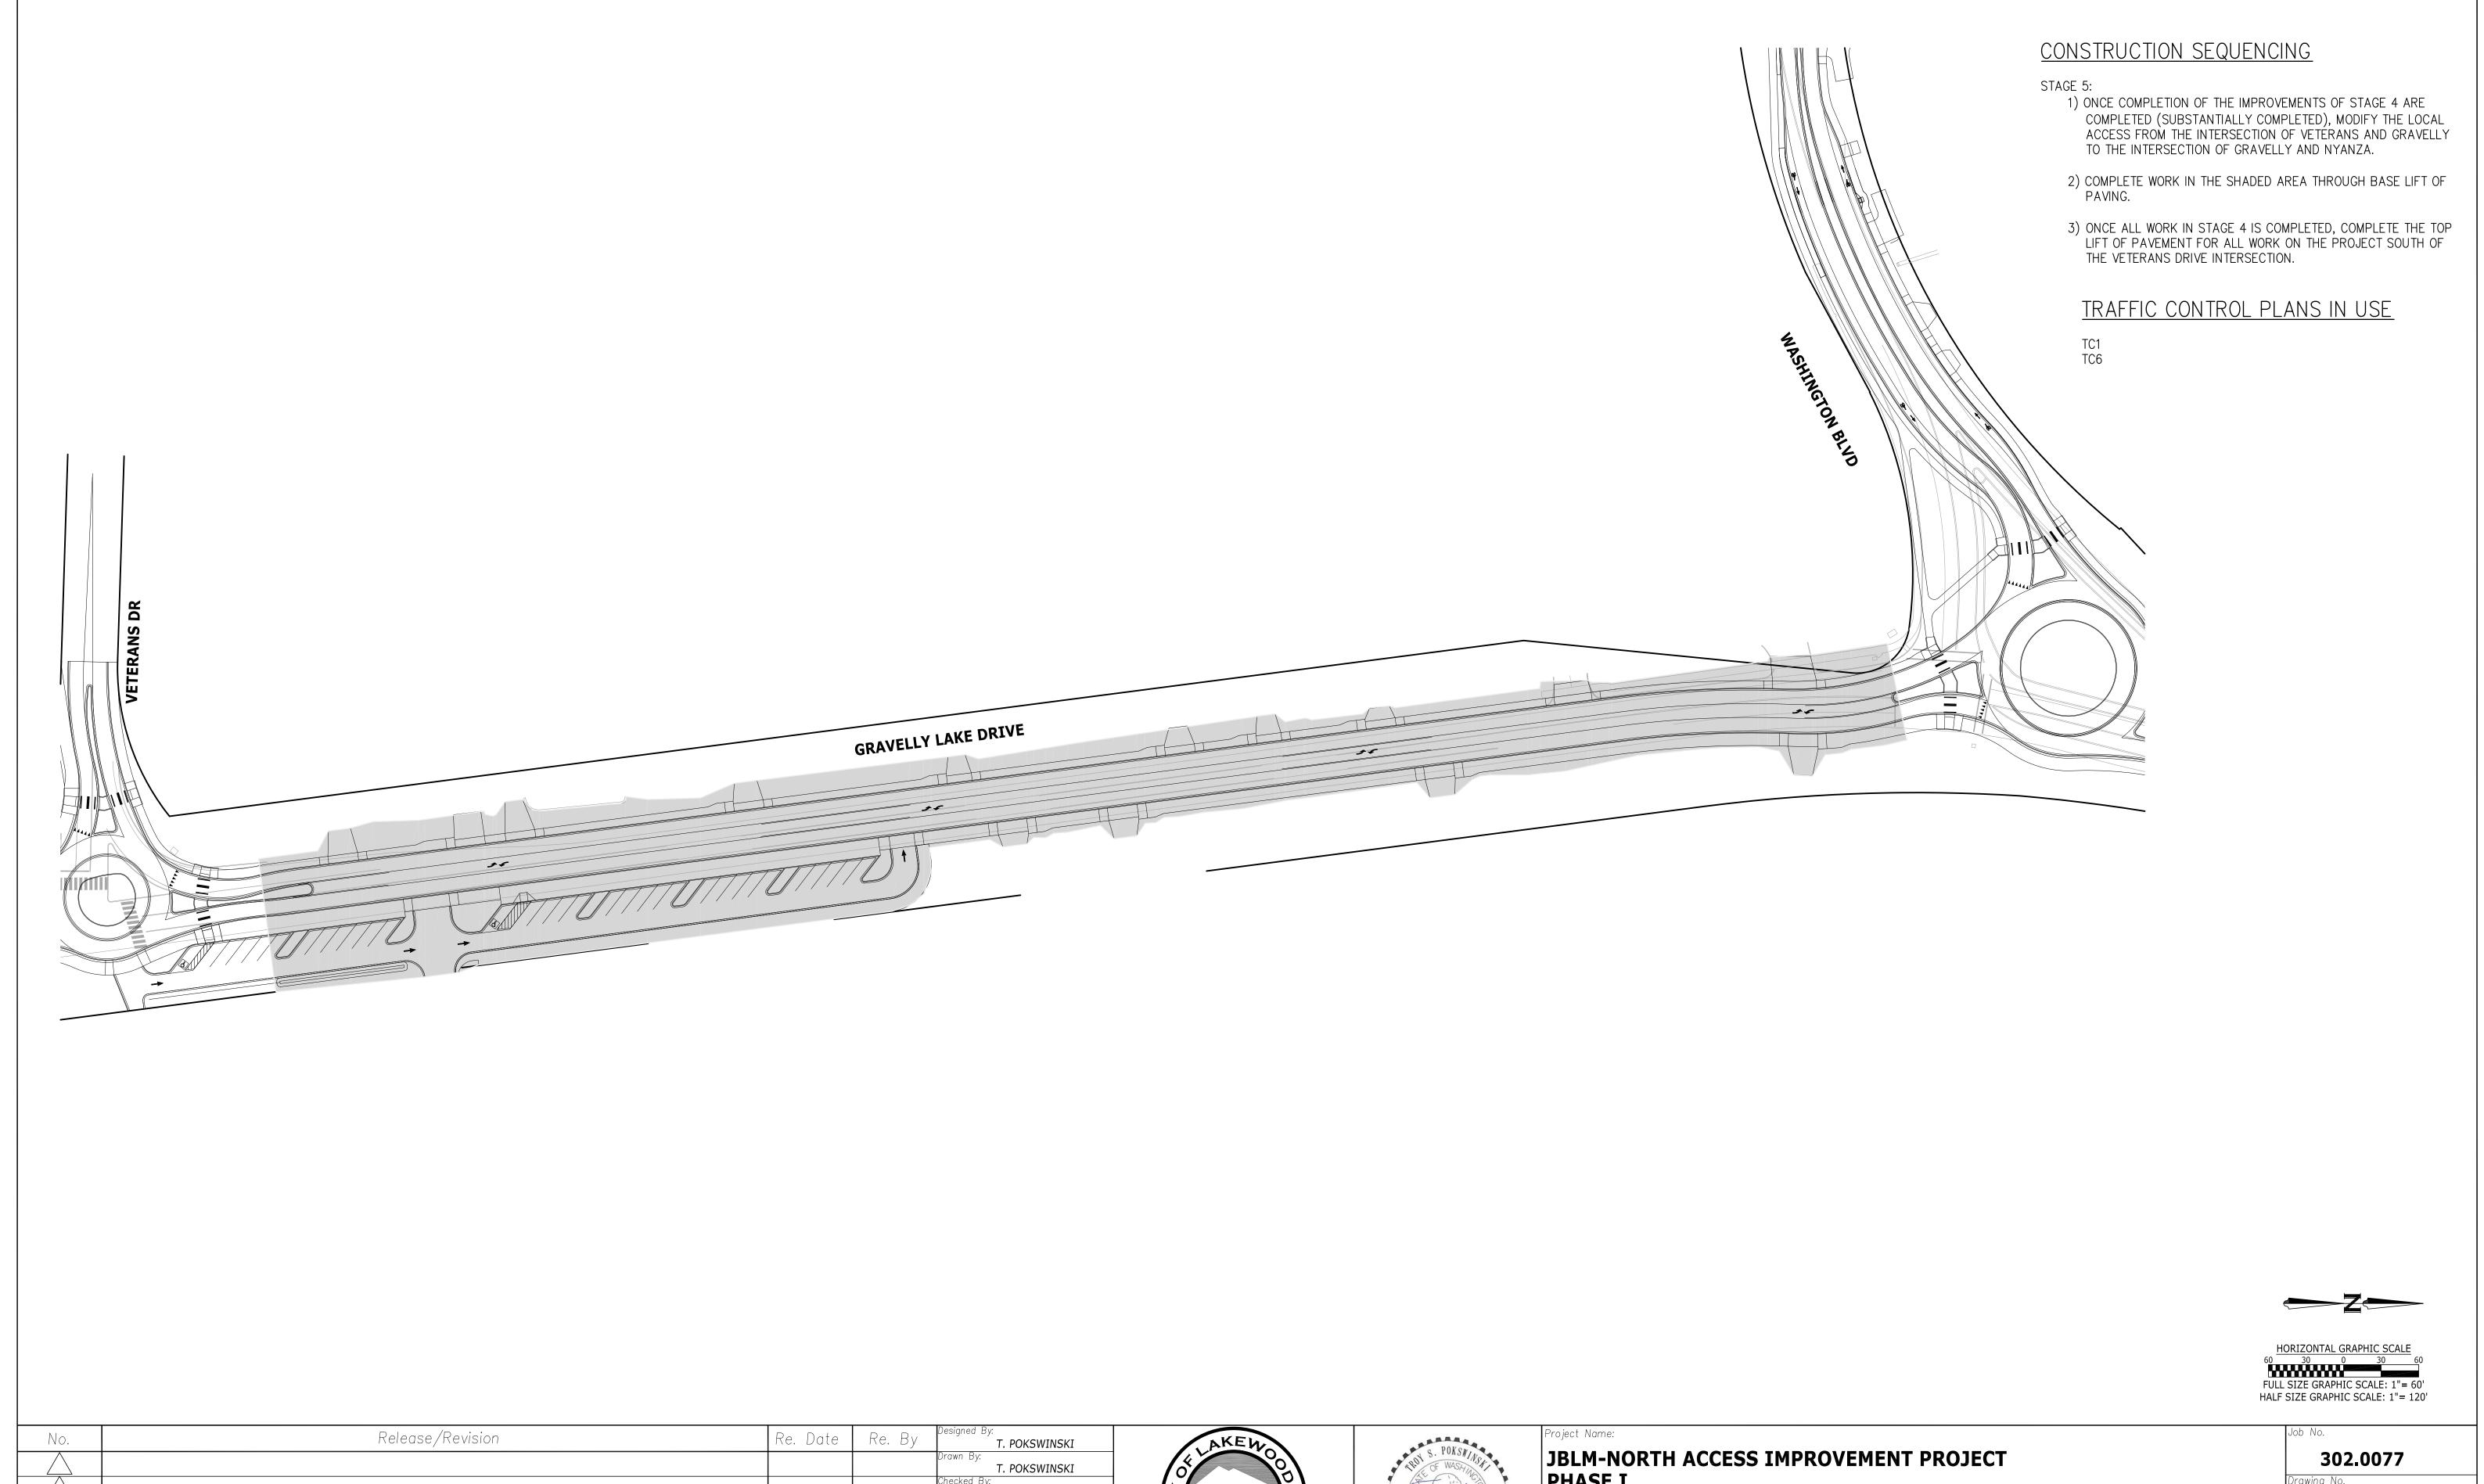STAGING PLAN - STAGE 3 - ROAD REBUILD SOUTH OF NYANZA EAST SIDE Sheet





INO.	Release/Revision	Re. Date	Re. By	T. POKSWINSKI
				Drawn By: <b>T. POKSWINSKI</b>
				Checked By:  W. OTT
				Approved By: P. BUCICH
				Project Start Date: Drawing Scale:  3/1/20 AS SHOWN
				Electronic File Name:





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35/ONAL ENG C) 3/L

JBLM-NORTH ACCESS IMPROVEMENT PROJECT PHASE I
Drawing Name:

STAGING PLAN - STAGE 5 - GRAVELLY LAKE - VETERANS TO WASHINGTON Sheet

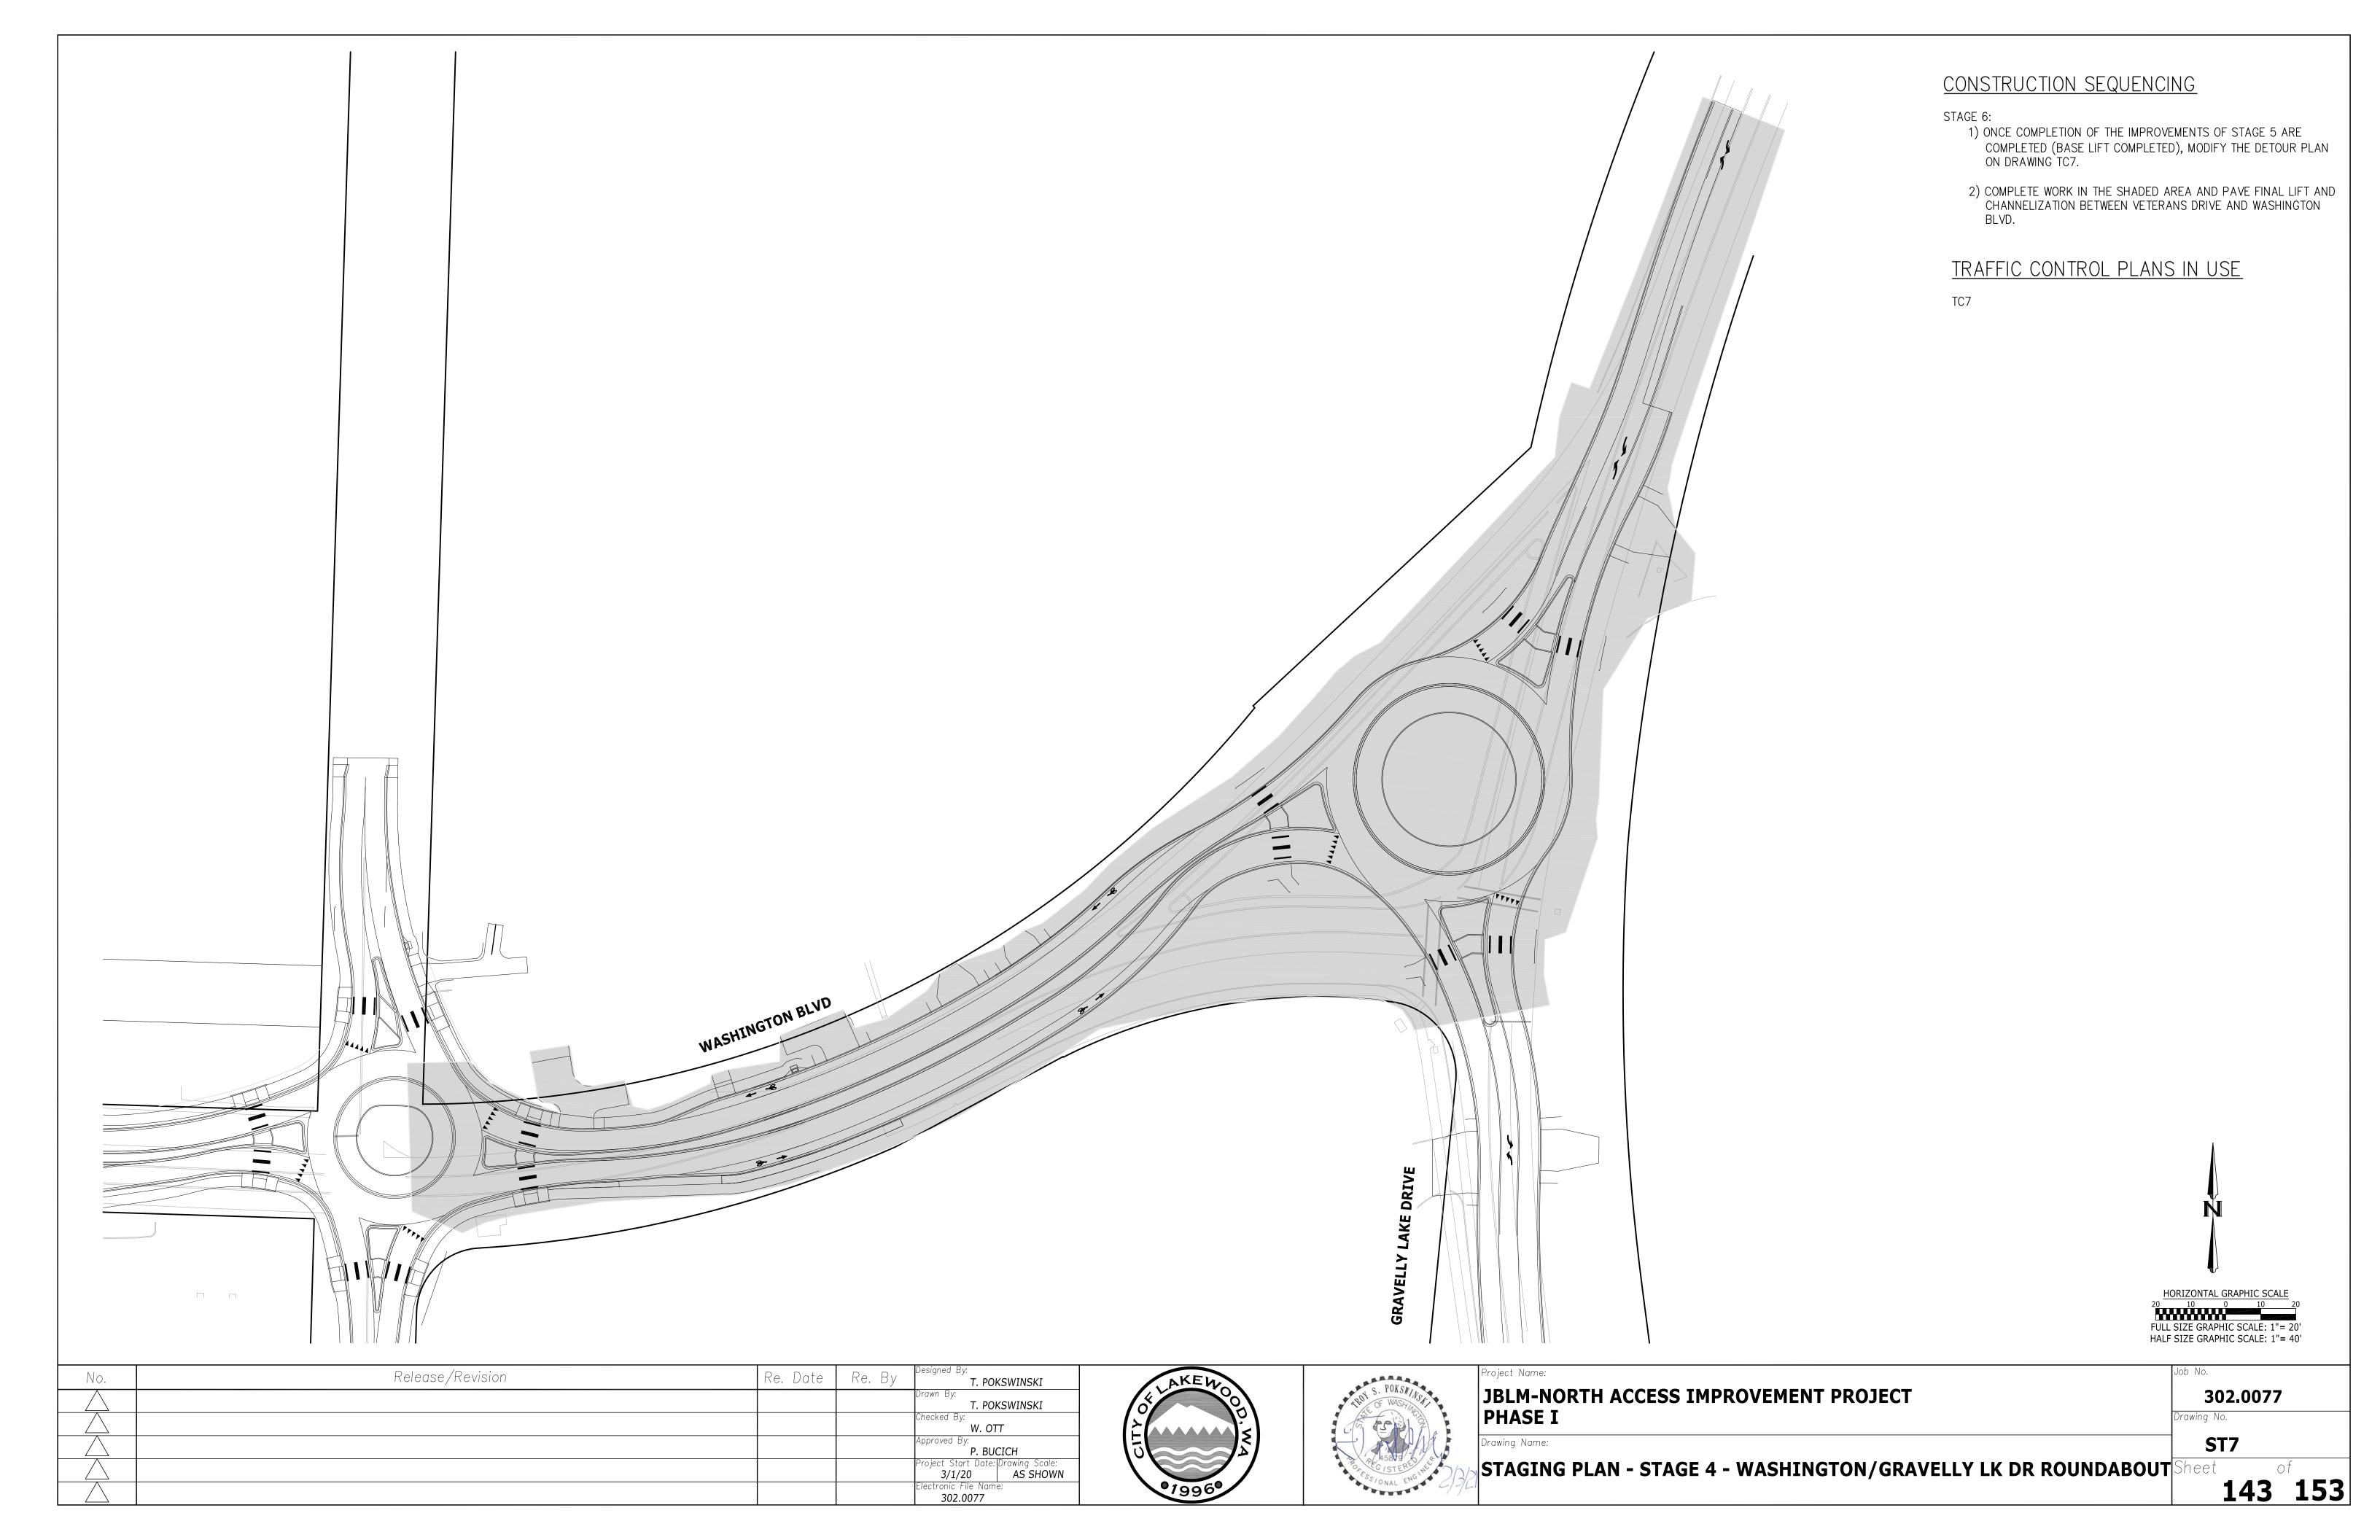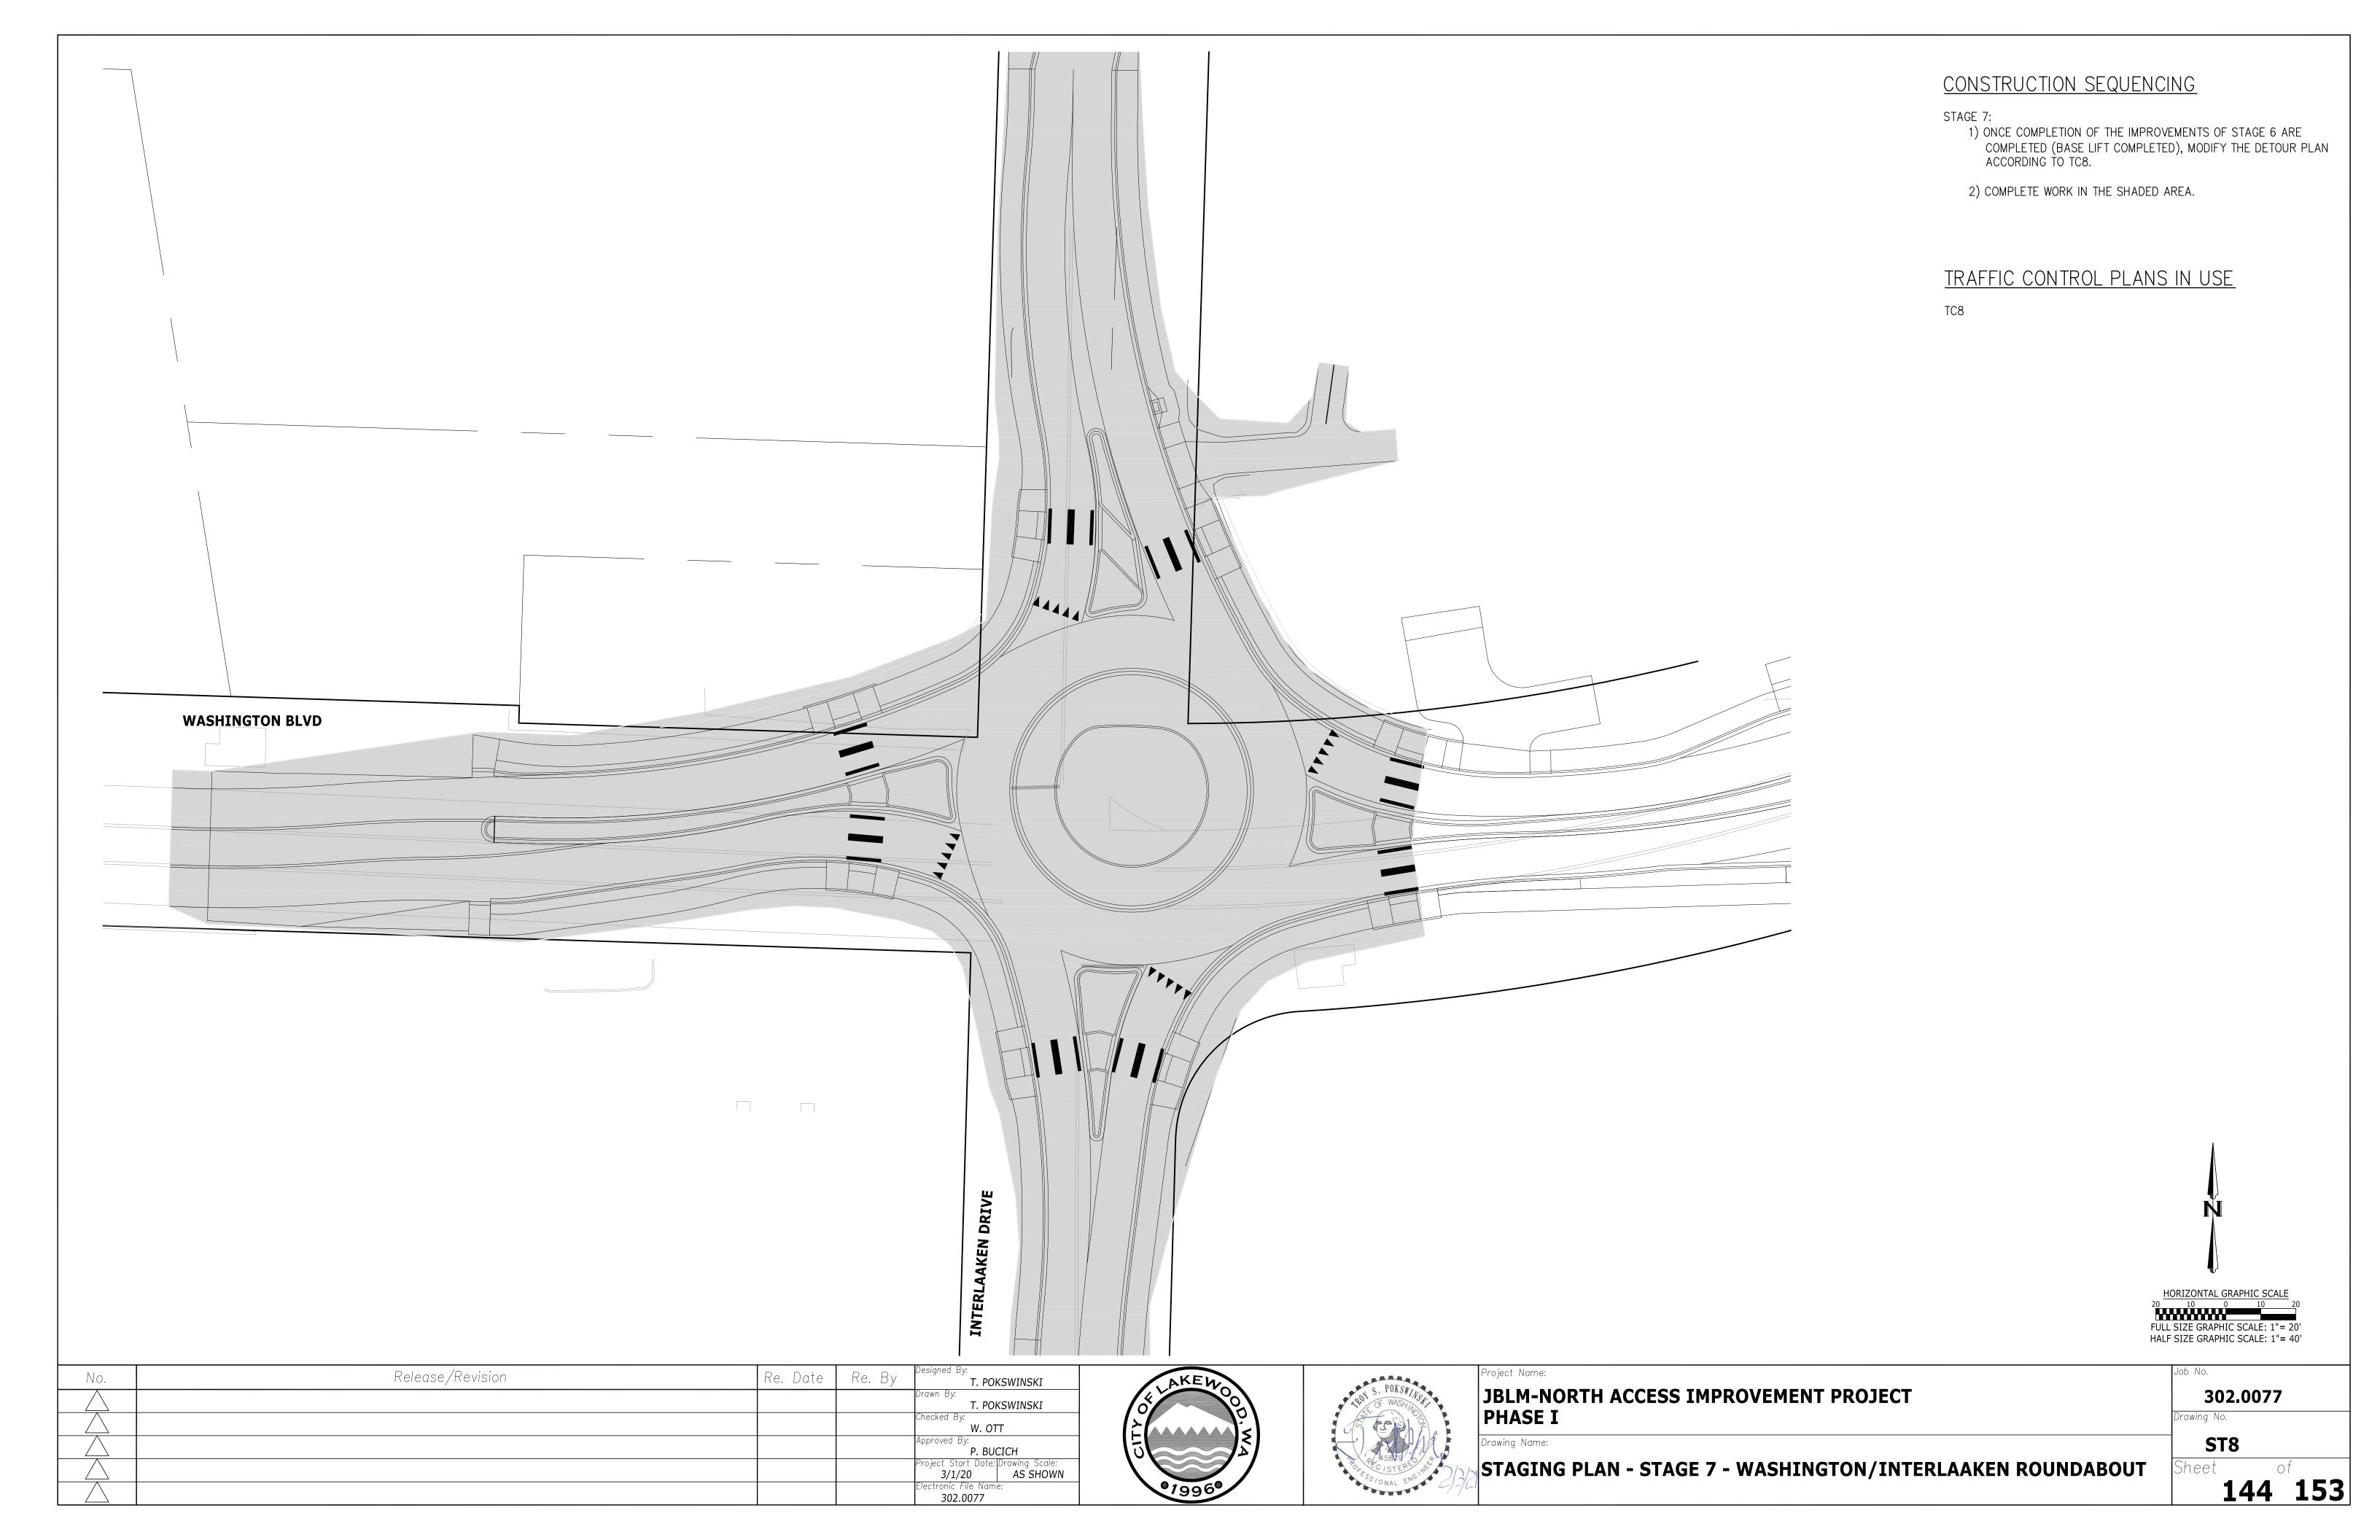ST6







No.	Release/Revision	Re. Date	Re. By	Designed By: T. POKSWINSKI
				Drawn By: T. POKSWINSKI
				Checked By: W. OTT
				Approved By: P. BUCICH
				Project Start Date: Drawing Scale: 3/1/20 AS SHOW
				Electronic File Name:





Project Name:
JBLM-NORTH ACCESS IMPROVEMENT PROJECT PHASE I

rawing Name:

TRAFFIC CONTROL PLAN - STAGE 1 THROUGH 5 DETOUR

LEGEND

DETOUR ROUTE

ROAD CLOSURE

POINT OF LOCAL ACCESS

••• CLOSE RIGHT TURN LANE OFF

WITH LIGHTED BARRELS

**DETOUR** 

**DETOUR** 

M4-9R

FULL SIZE GRAPHIC SCALE: 1"= 400' HALF SIZE GRAPHIC SCALE: 1"= 800'

**PCMS** 

**CLOSURE AND ONE WEEK** PRIOR TO STAGE CHANGE


**REQUIRING SHIFT IN** 


**DETOUR** 


**3 WEEKS PRIOR TO** 

302.0077 Drawing No.

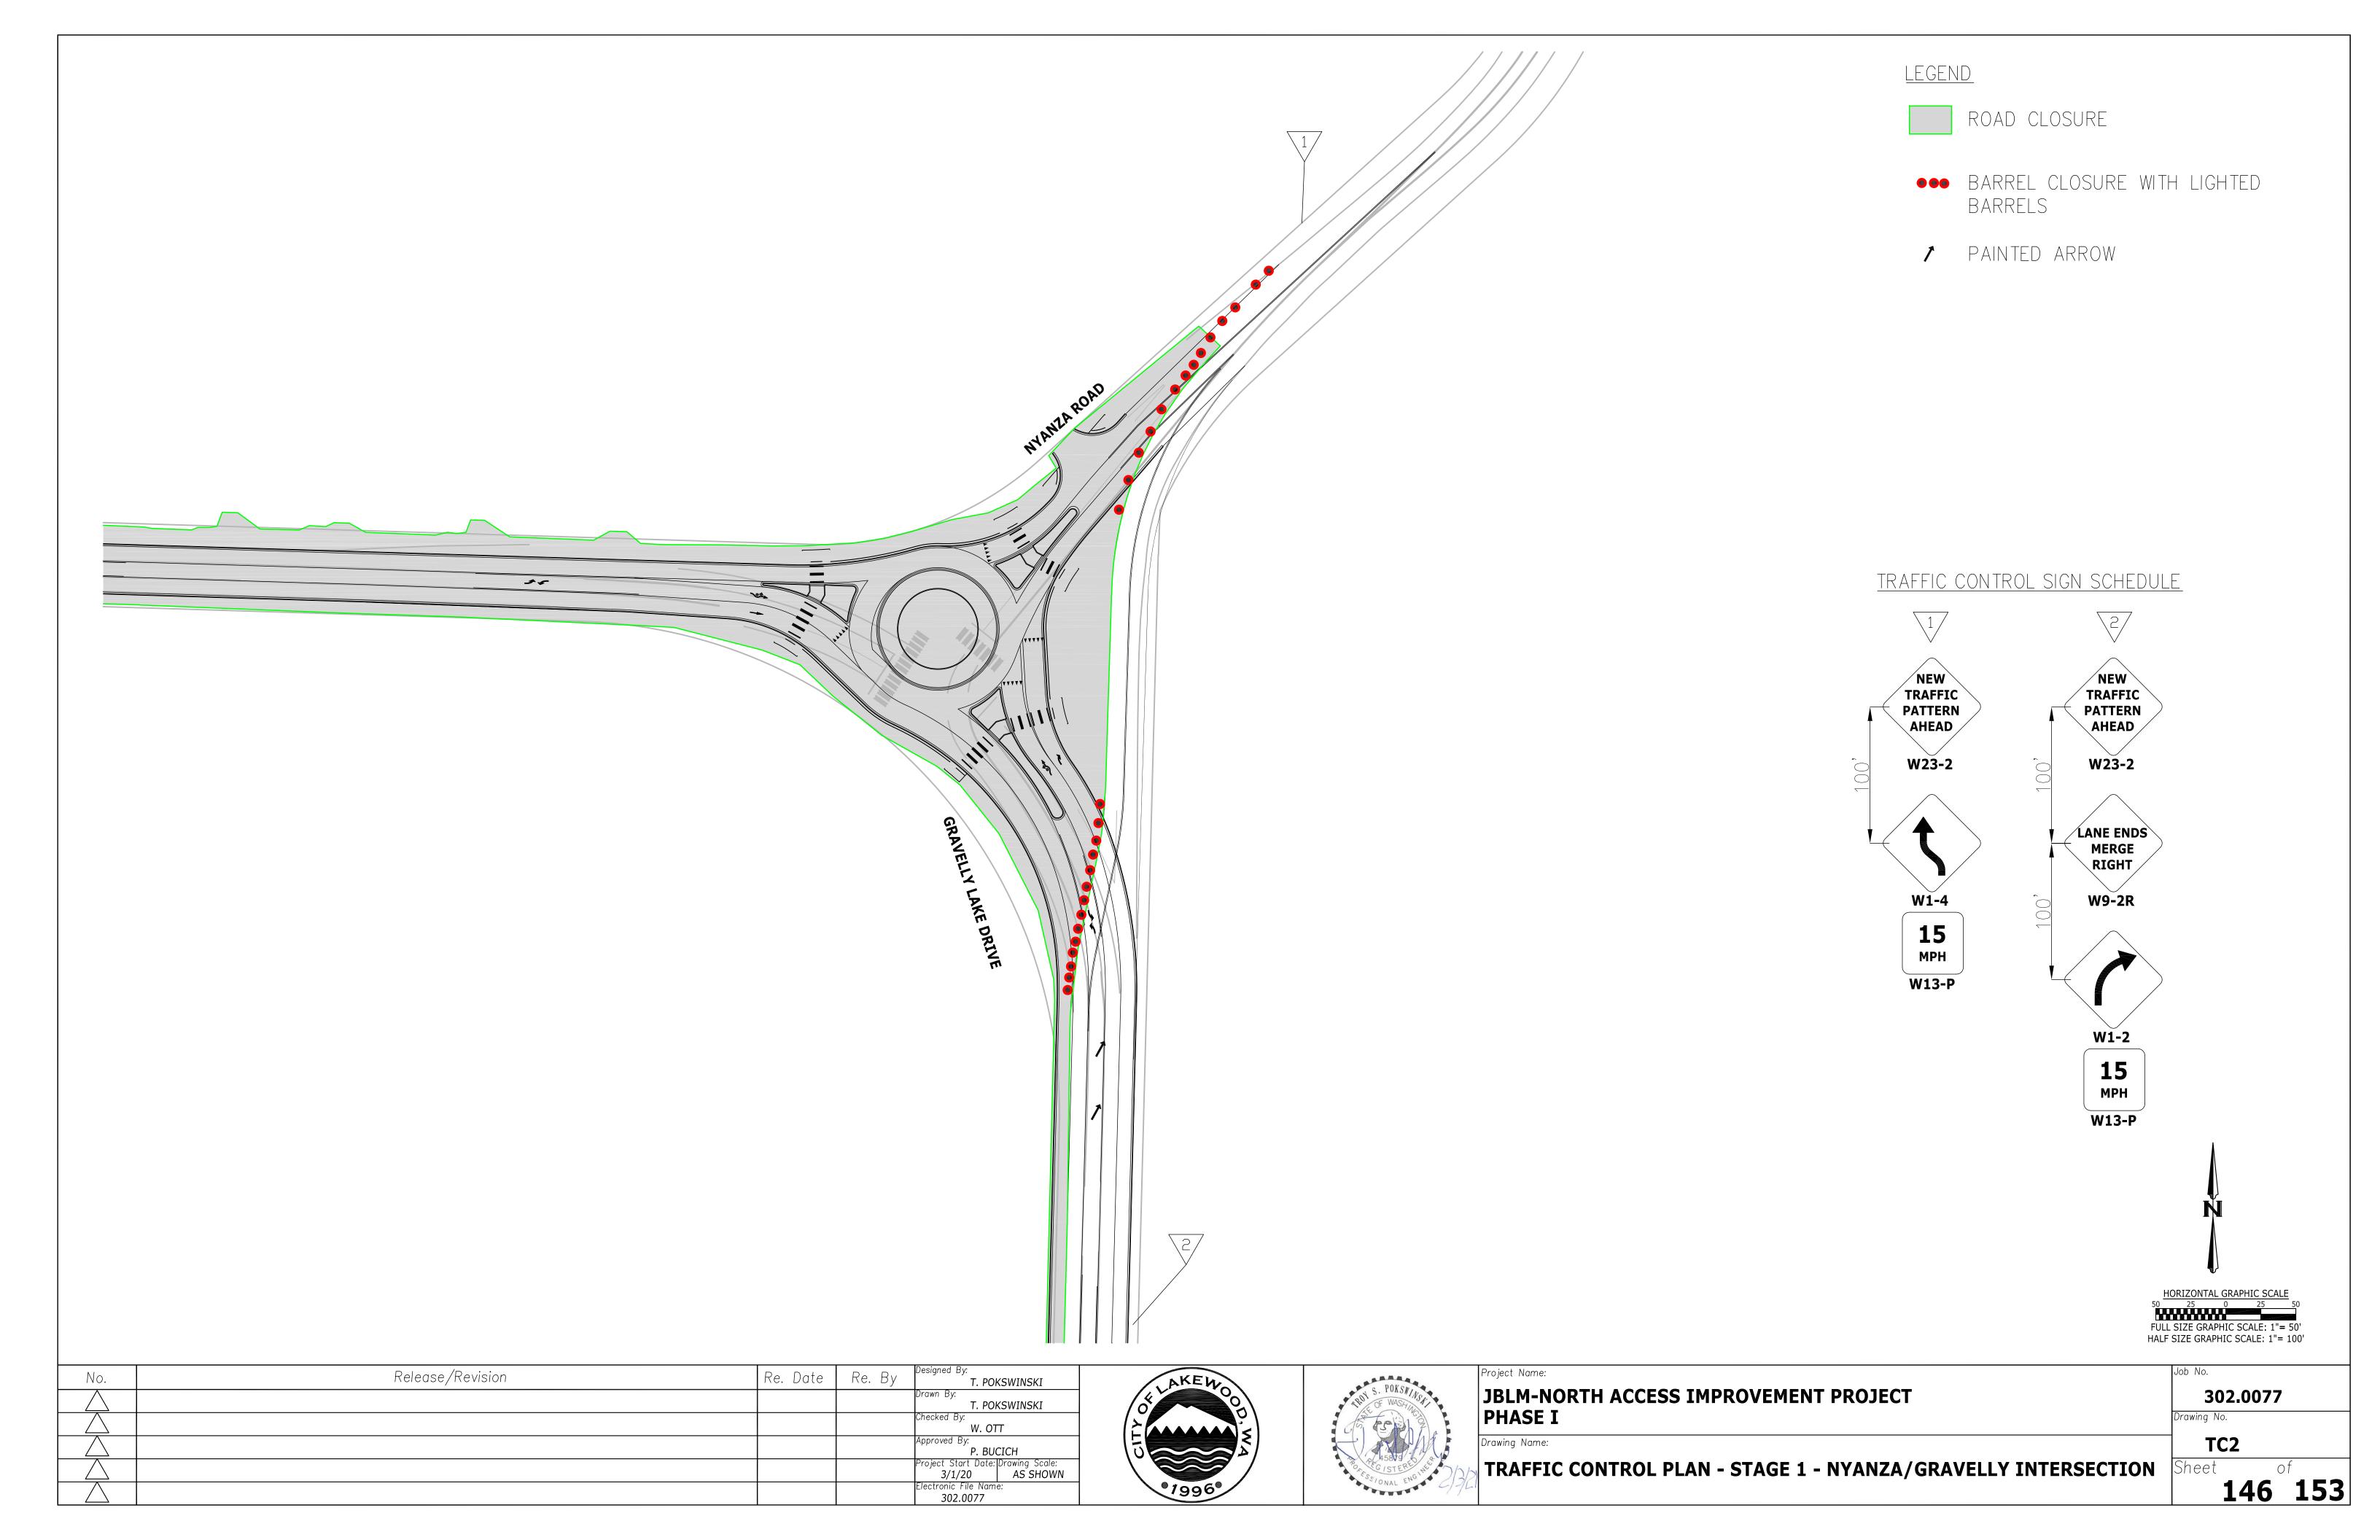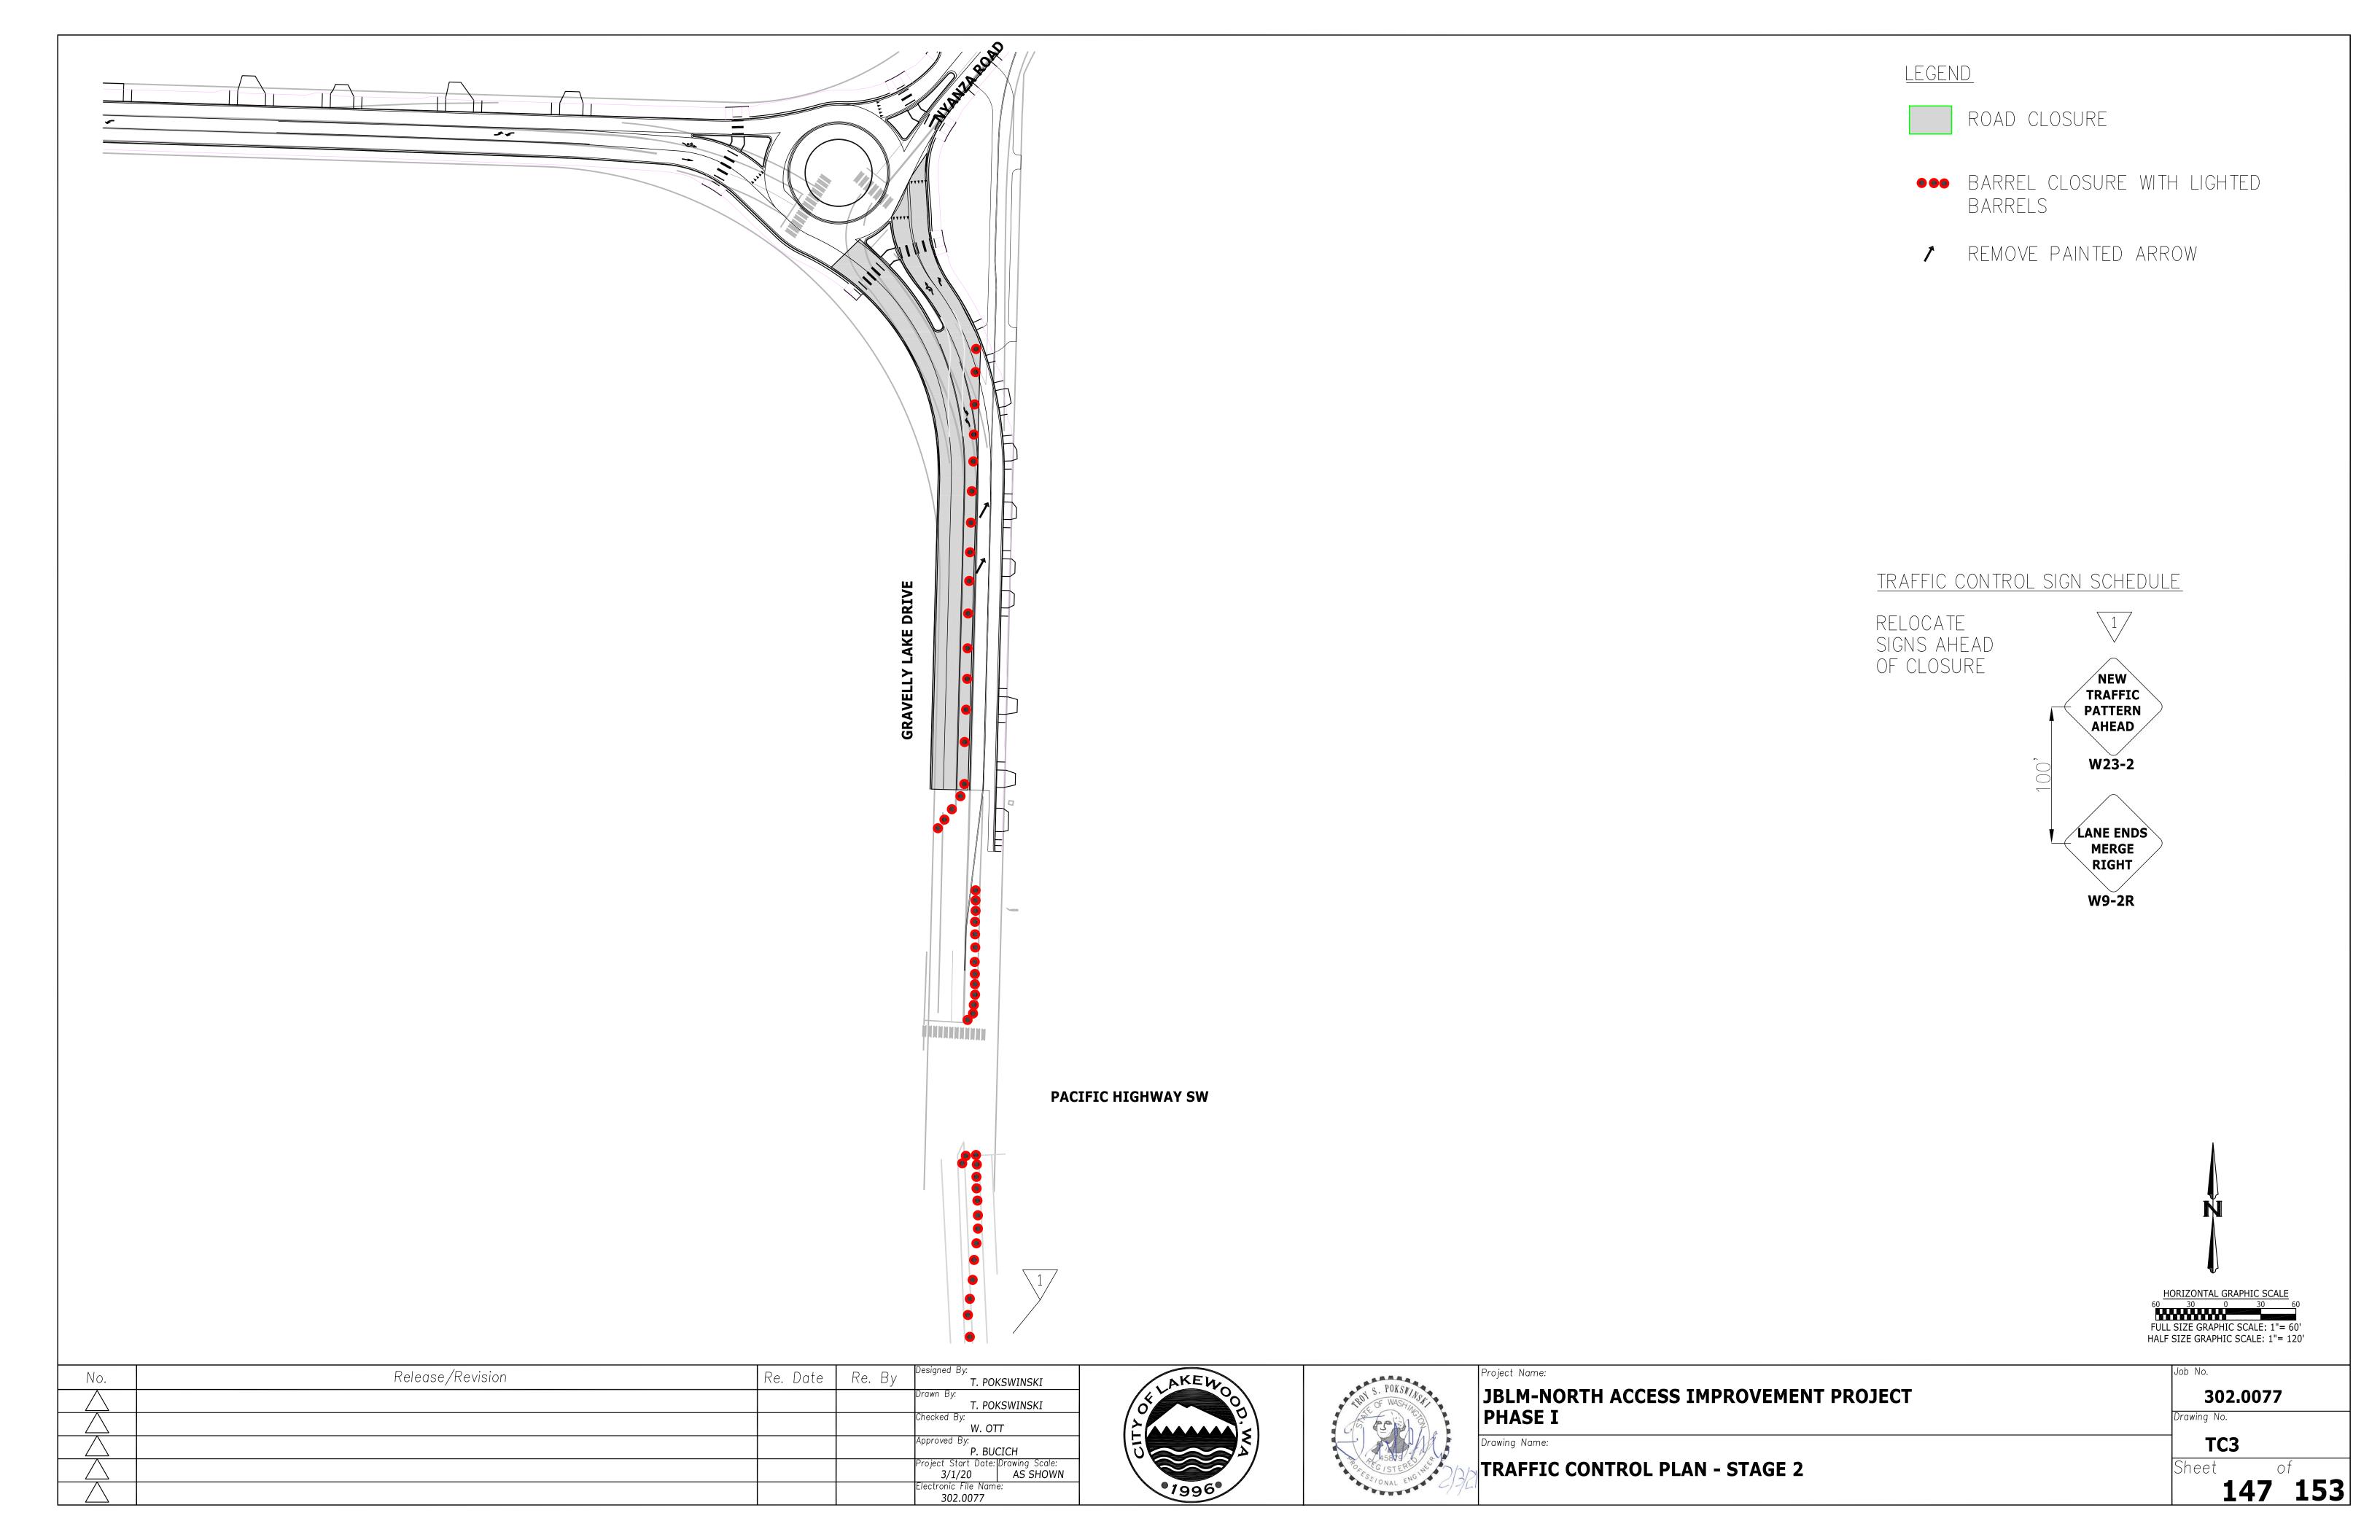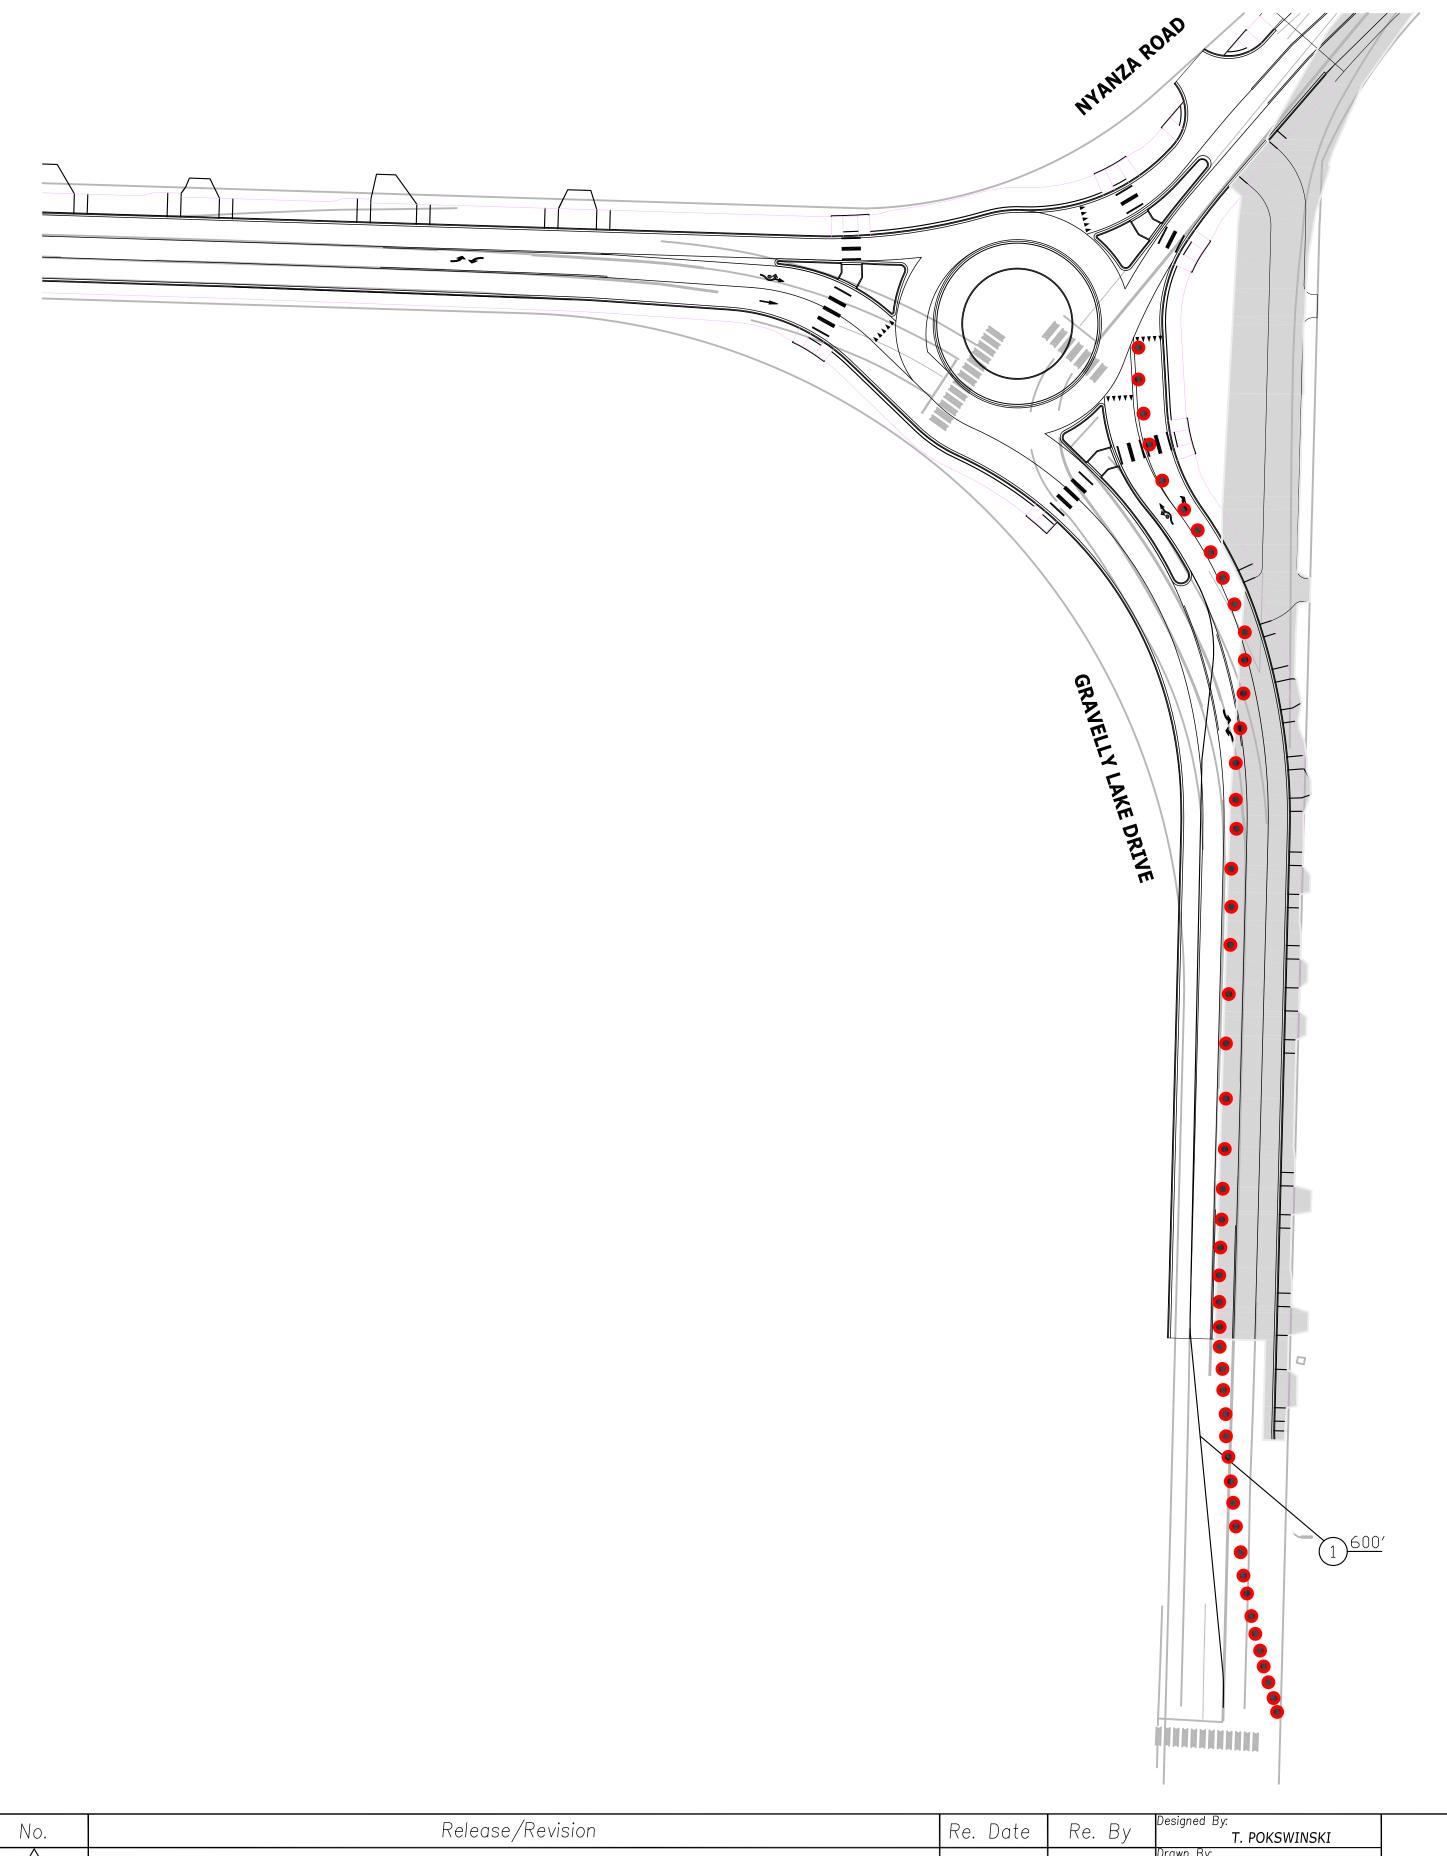TC1











ROAD CLOSURE

BARREL CLOSURE WITH LIGHTED BARRELS

### **CONSTRUCTION NOTES**

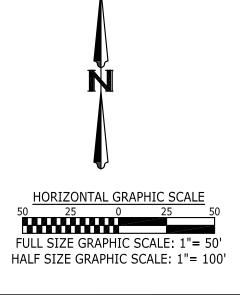
1 INSTALL DOUBLE YELLOW TEMPORARY TRAFFIC STRIPING TAPE

# TRAFFIC CONTROL NOTES

REMOVE ALL SIGNS SHOWN ON TC2. KEEP SIGNS AND BARRELS SOUTH OF PACIFIC HIGHWAY SHOWN ON TC3..

FOR WORK ON THE NYANZA NORTH LEG OF THE ROUNDABOUT, CLOSE THE NYANZA LEG OF THE ROUNDABOUT. SWITCH DETOUR SIGNS AT THE NORTH END OF THE NYANZA/GRAVELLY INTERSECTION AND DETOUR TRAFFIC ALONG GRAVELLY NORTH TO VETERANS. PROVIDE PCMS ONE WEEK PRIOR TO SHIFT TO LET PUBLIC KNOW OF THE DETOUR REVISION.

FINAL LIFT OF PAVEMENT AND STRIPING SHALL BE DONE UNDER FULL CLOSURE OF GRAVELLY AND NYANZA. PREPAVING MEETING IS REQUIRED WITH THE CITY TO DISCUSS WORK BEING DONE BETWEEN THE HOURS OF 10 P.M. AND 4 A.M. AND TRAFFIC CONTROL.



No.	Release/Revision	Re. Date	Re. By	Designed By:  T. POKSWINSKI
				Drawn By: T. POKSWINSKI
				Checked By: W. OTT
				Approved By: P. BUCICH
				Project Start Date: Drawing Scale:  3/1/20 AS SHOWN
				Electronic File Name:






Project Name:	
JBLM-NORTH ACCESS IMPROVEMENT PROJECT	
PHASE I	

Drawing Name:

TRAFFIC CONTROL PLAN - STAGE 3

Job No.
302.0077
Drawing No.

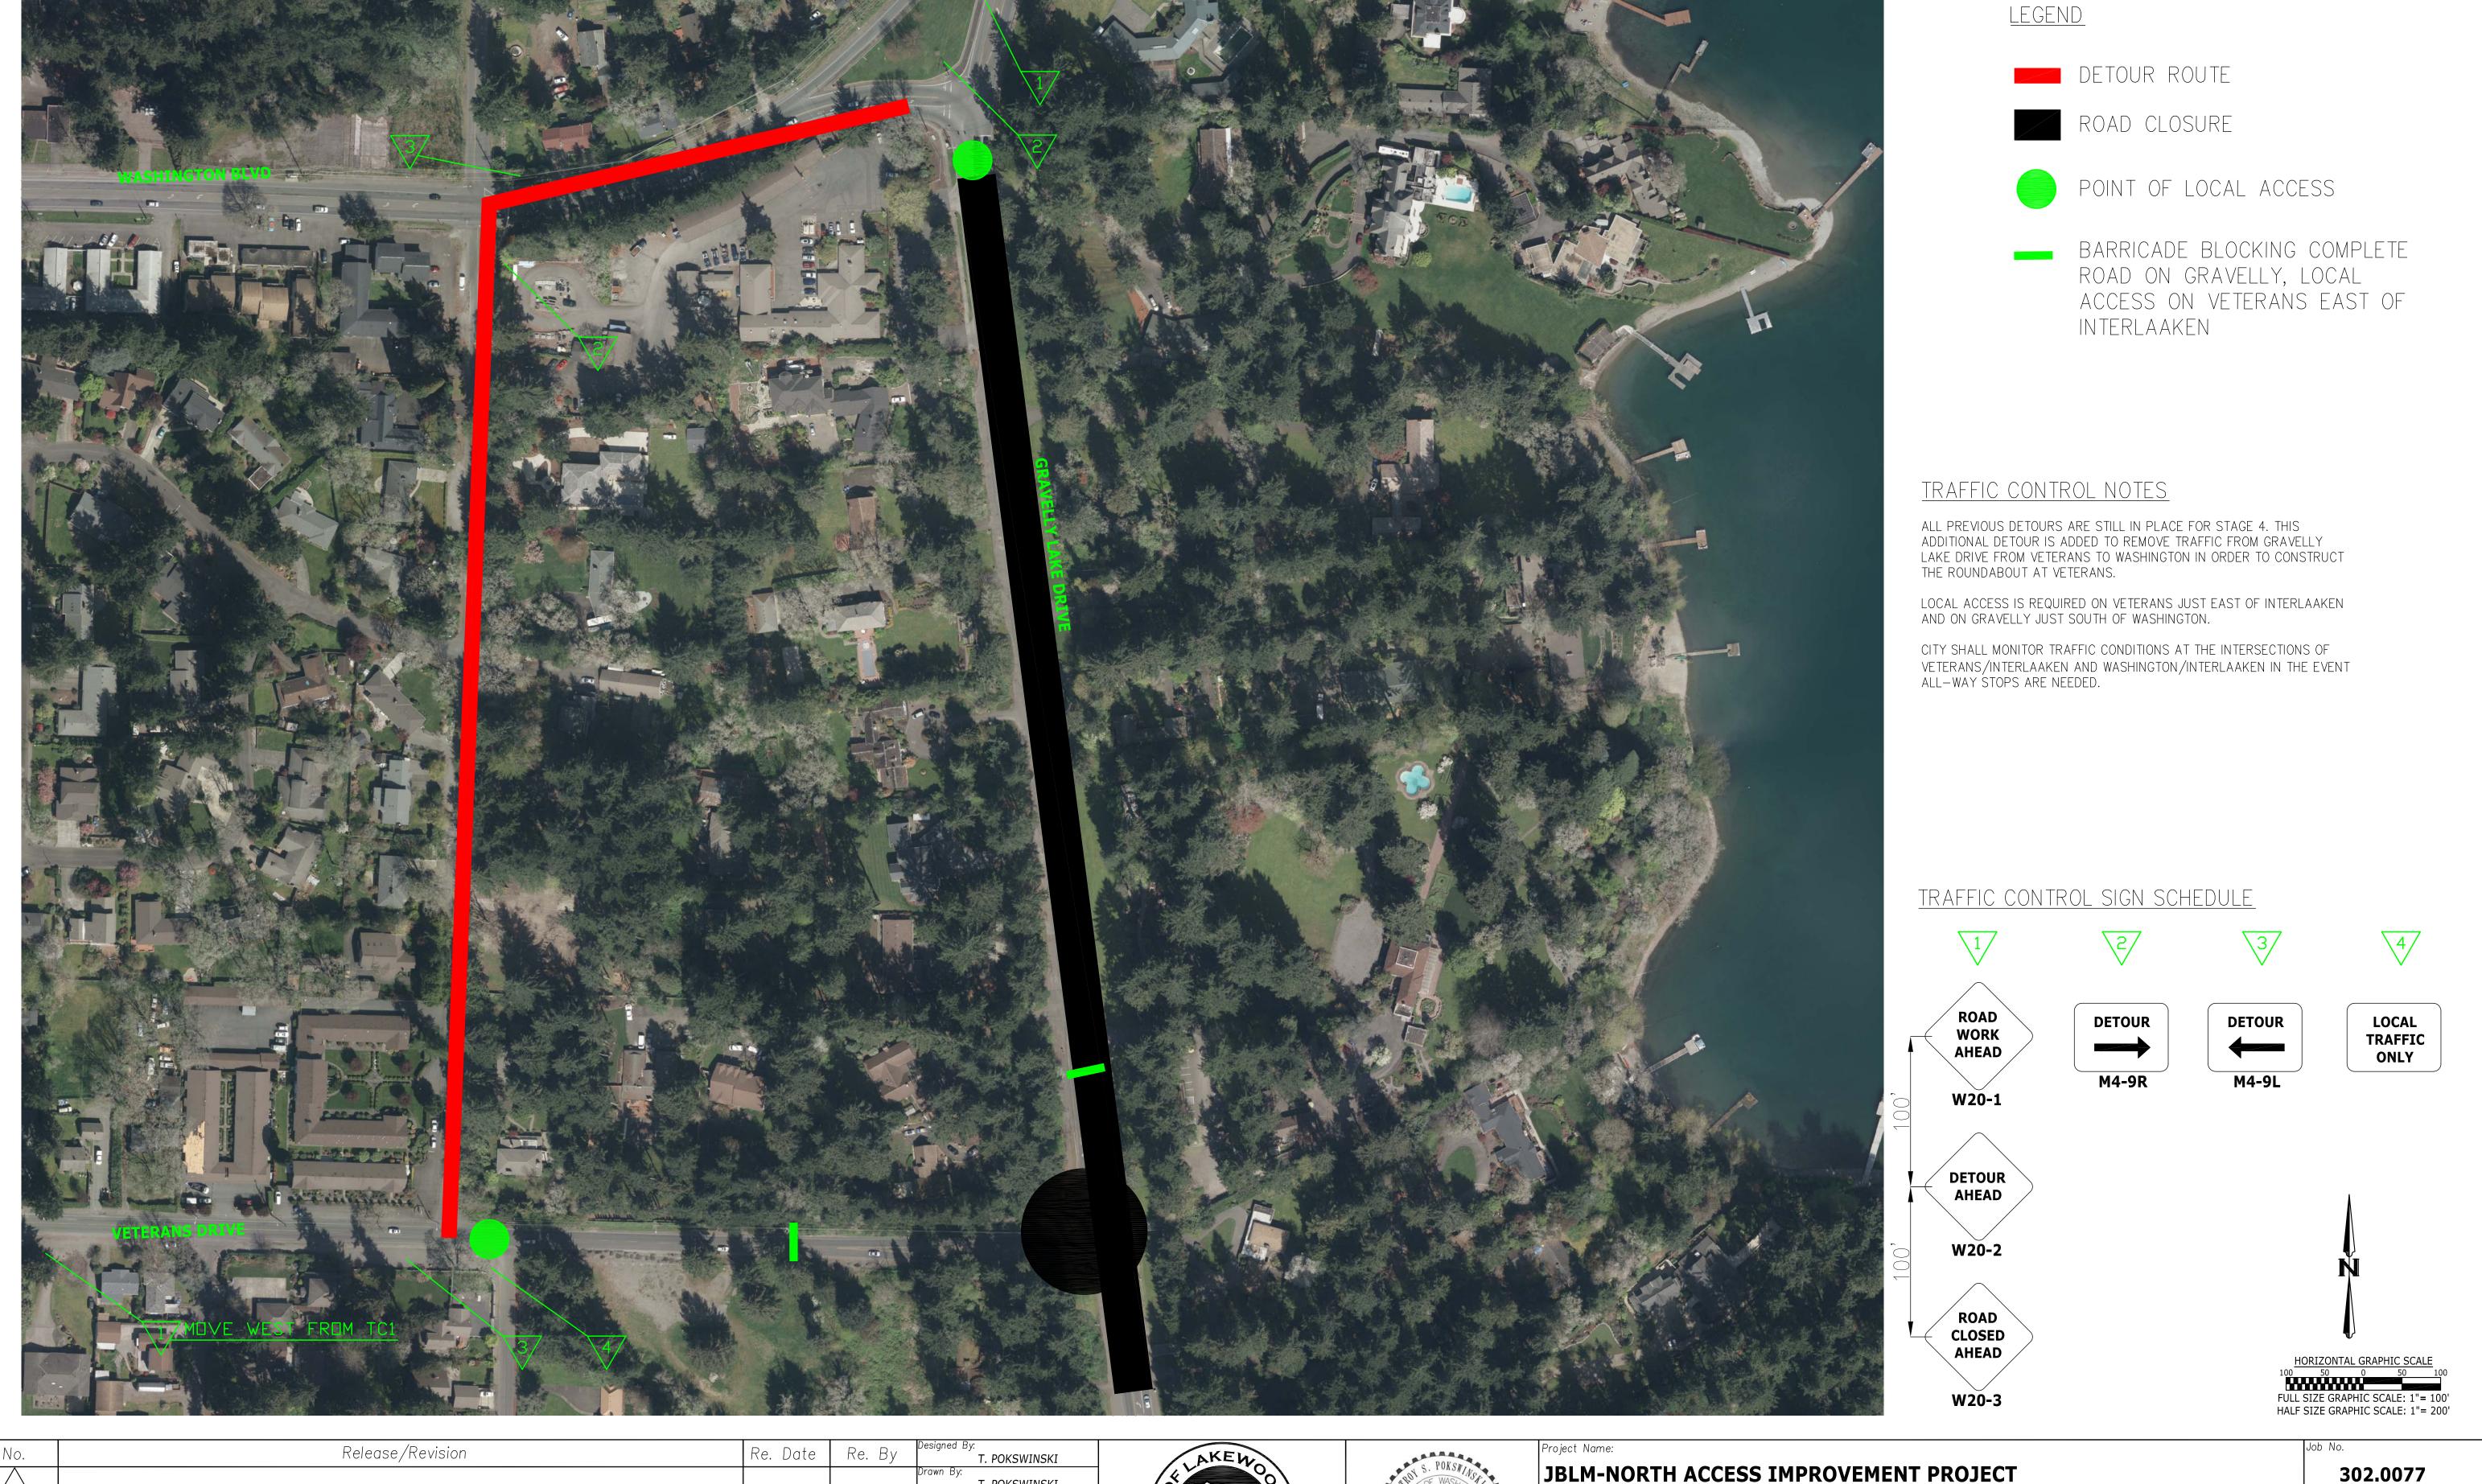TC4



IVO.	Neieuse/Nevision	re. Date	ке. Бу	T. POK	(SWINSKI
				Drawn By: T. POK:	(SWINSKI
				Checked By: W. OTT	 Г
				Approved By: P. BUC	
				Project Start Date: D 3/1/20	
				Electronic File Name:	:






JBLM-NORTH ACCESS IMPROVEMENT PROJECT	
PHASE I	

Drawing No. rawing Name:

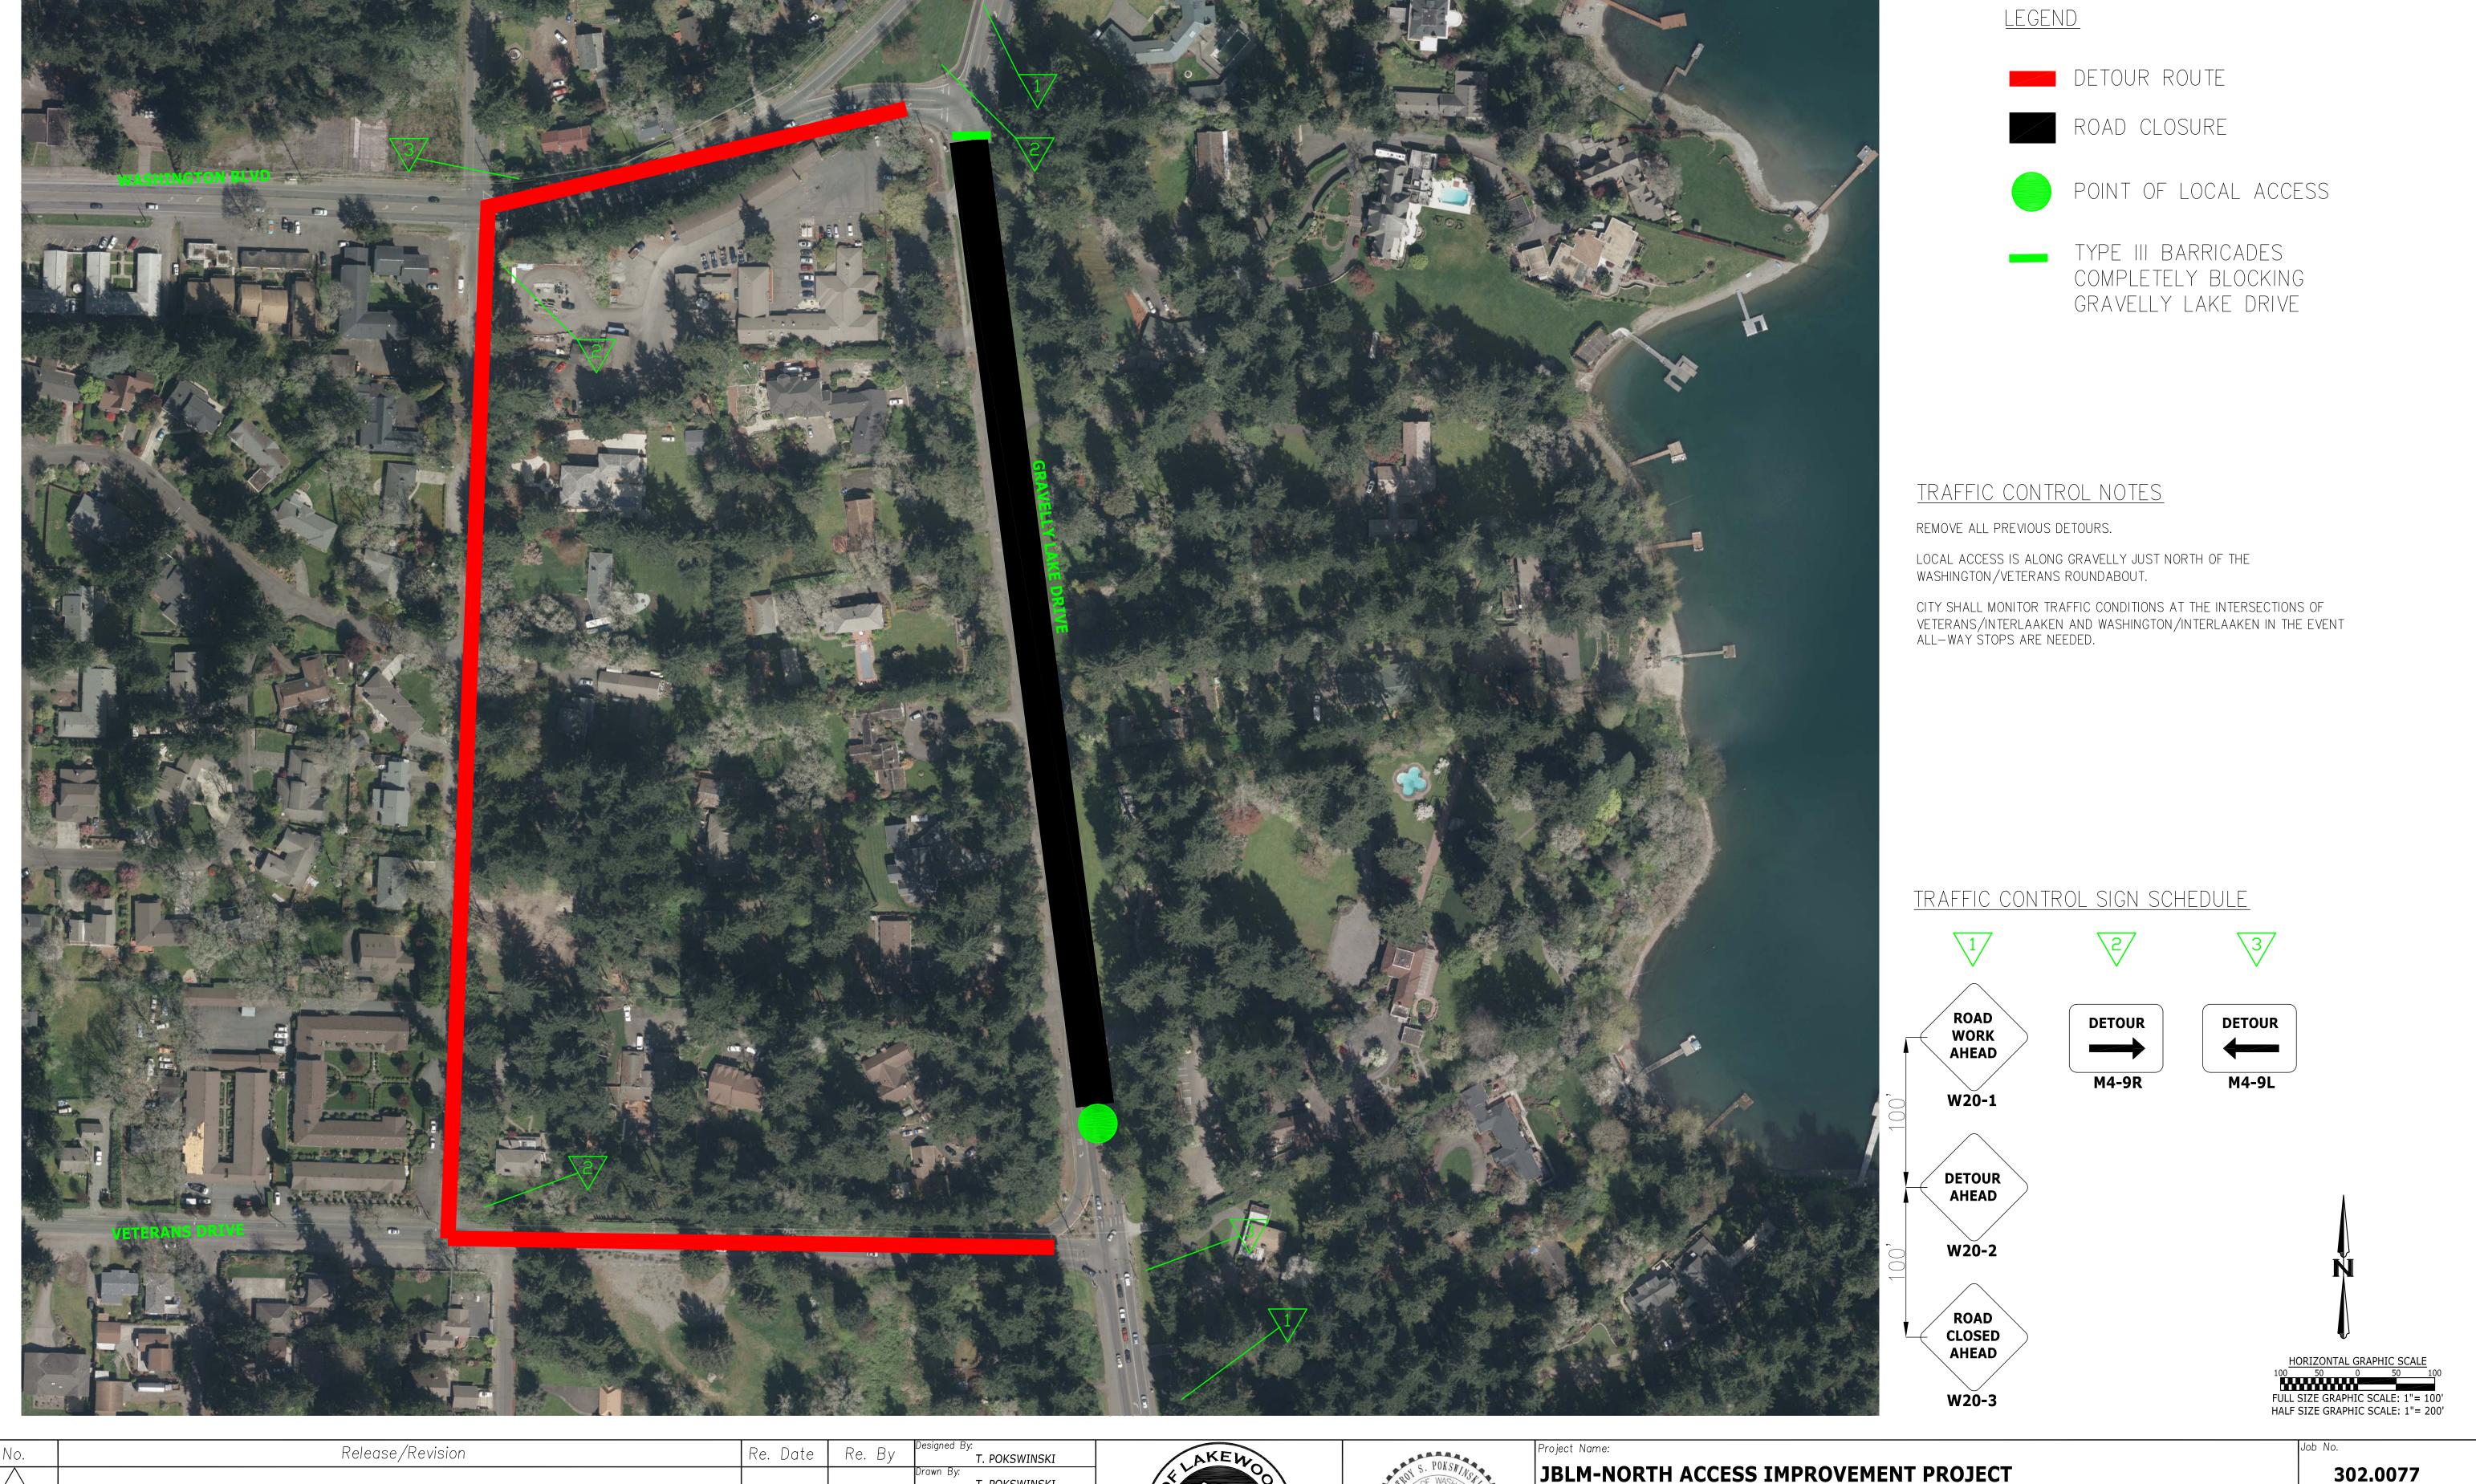TRAFFIC CONTROL PLAN - STAGE 4



NO.	Release/Revision	Re. Date	Re. By	T. POKSWINSKI
				Drawn By: T. POKSWINSKI
				Checked By: W. OTT
				Approved By: P. BUCICH
				Project Start Date: Drawing Scale:  3/1/20 AS SHOWN
				Electronic File Name:








To jour Trainio.	
JBLM-NORTH ACCESS II PHASE I	MPROVEMENT PRO
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ROJECT

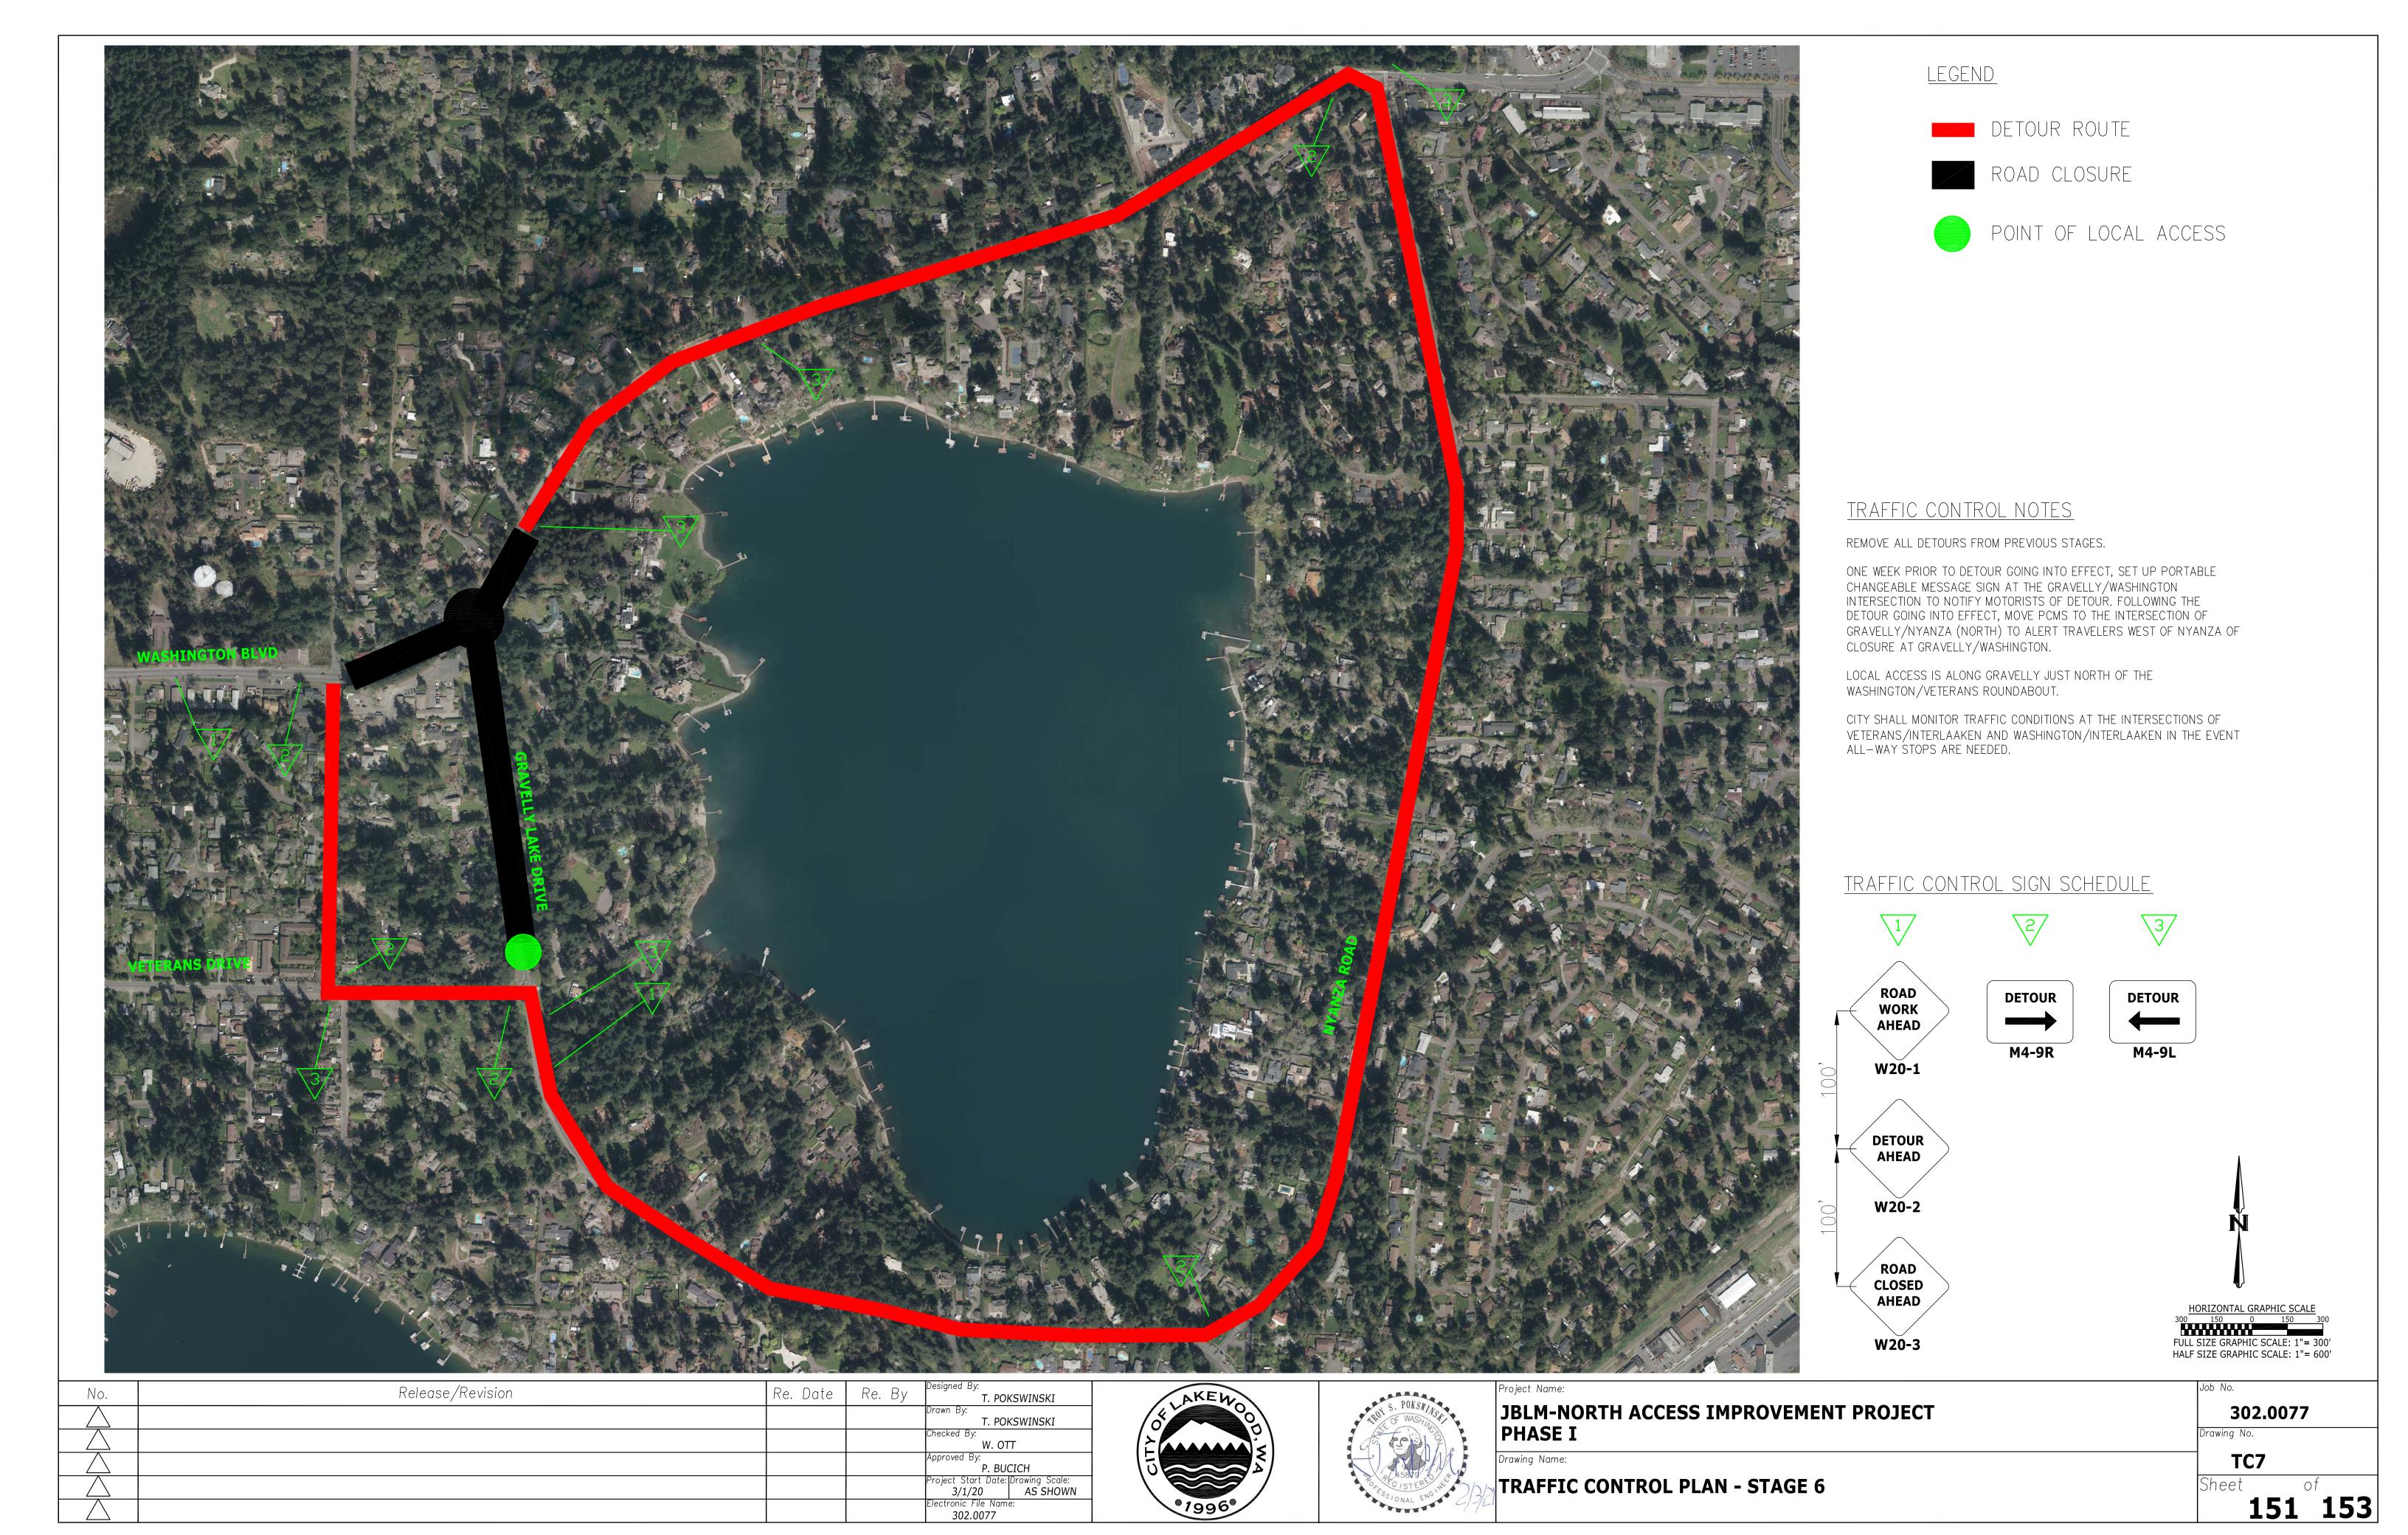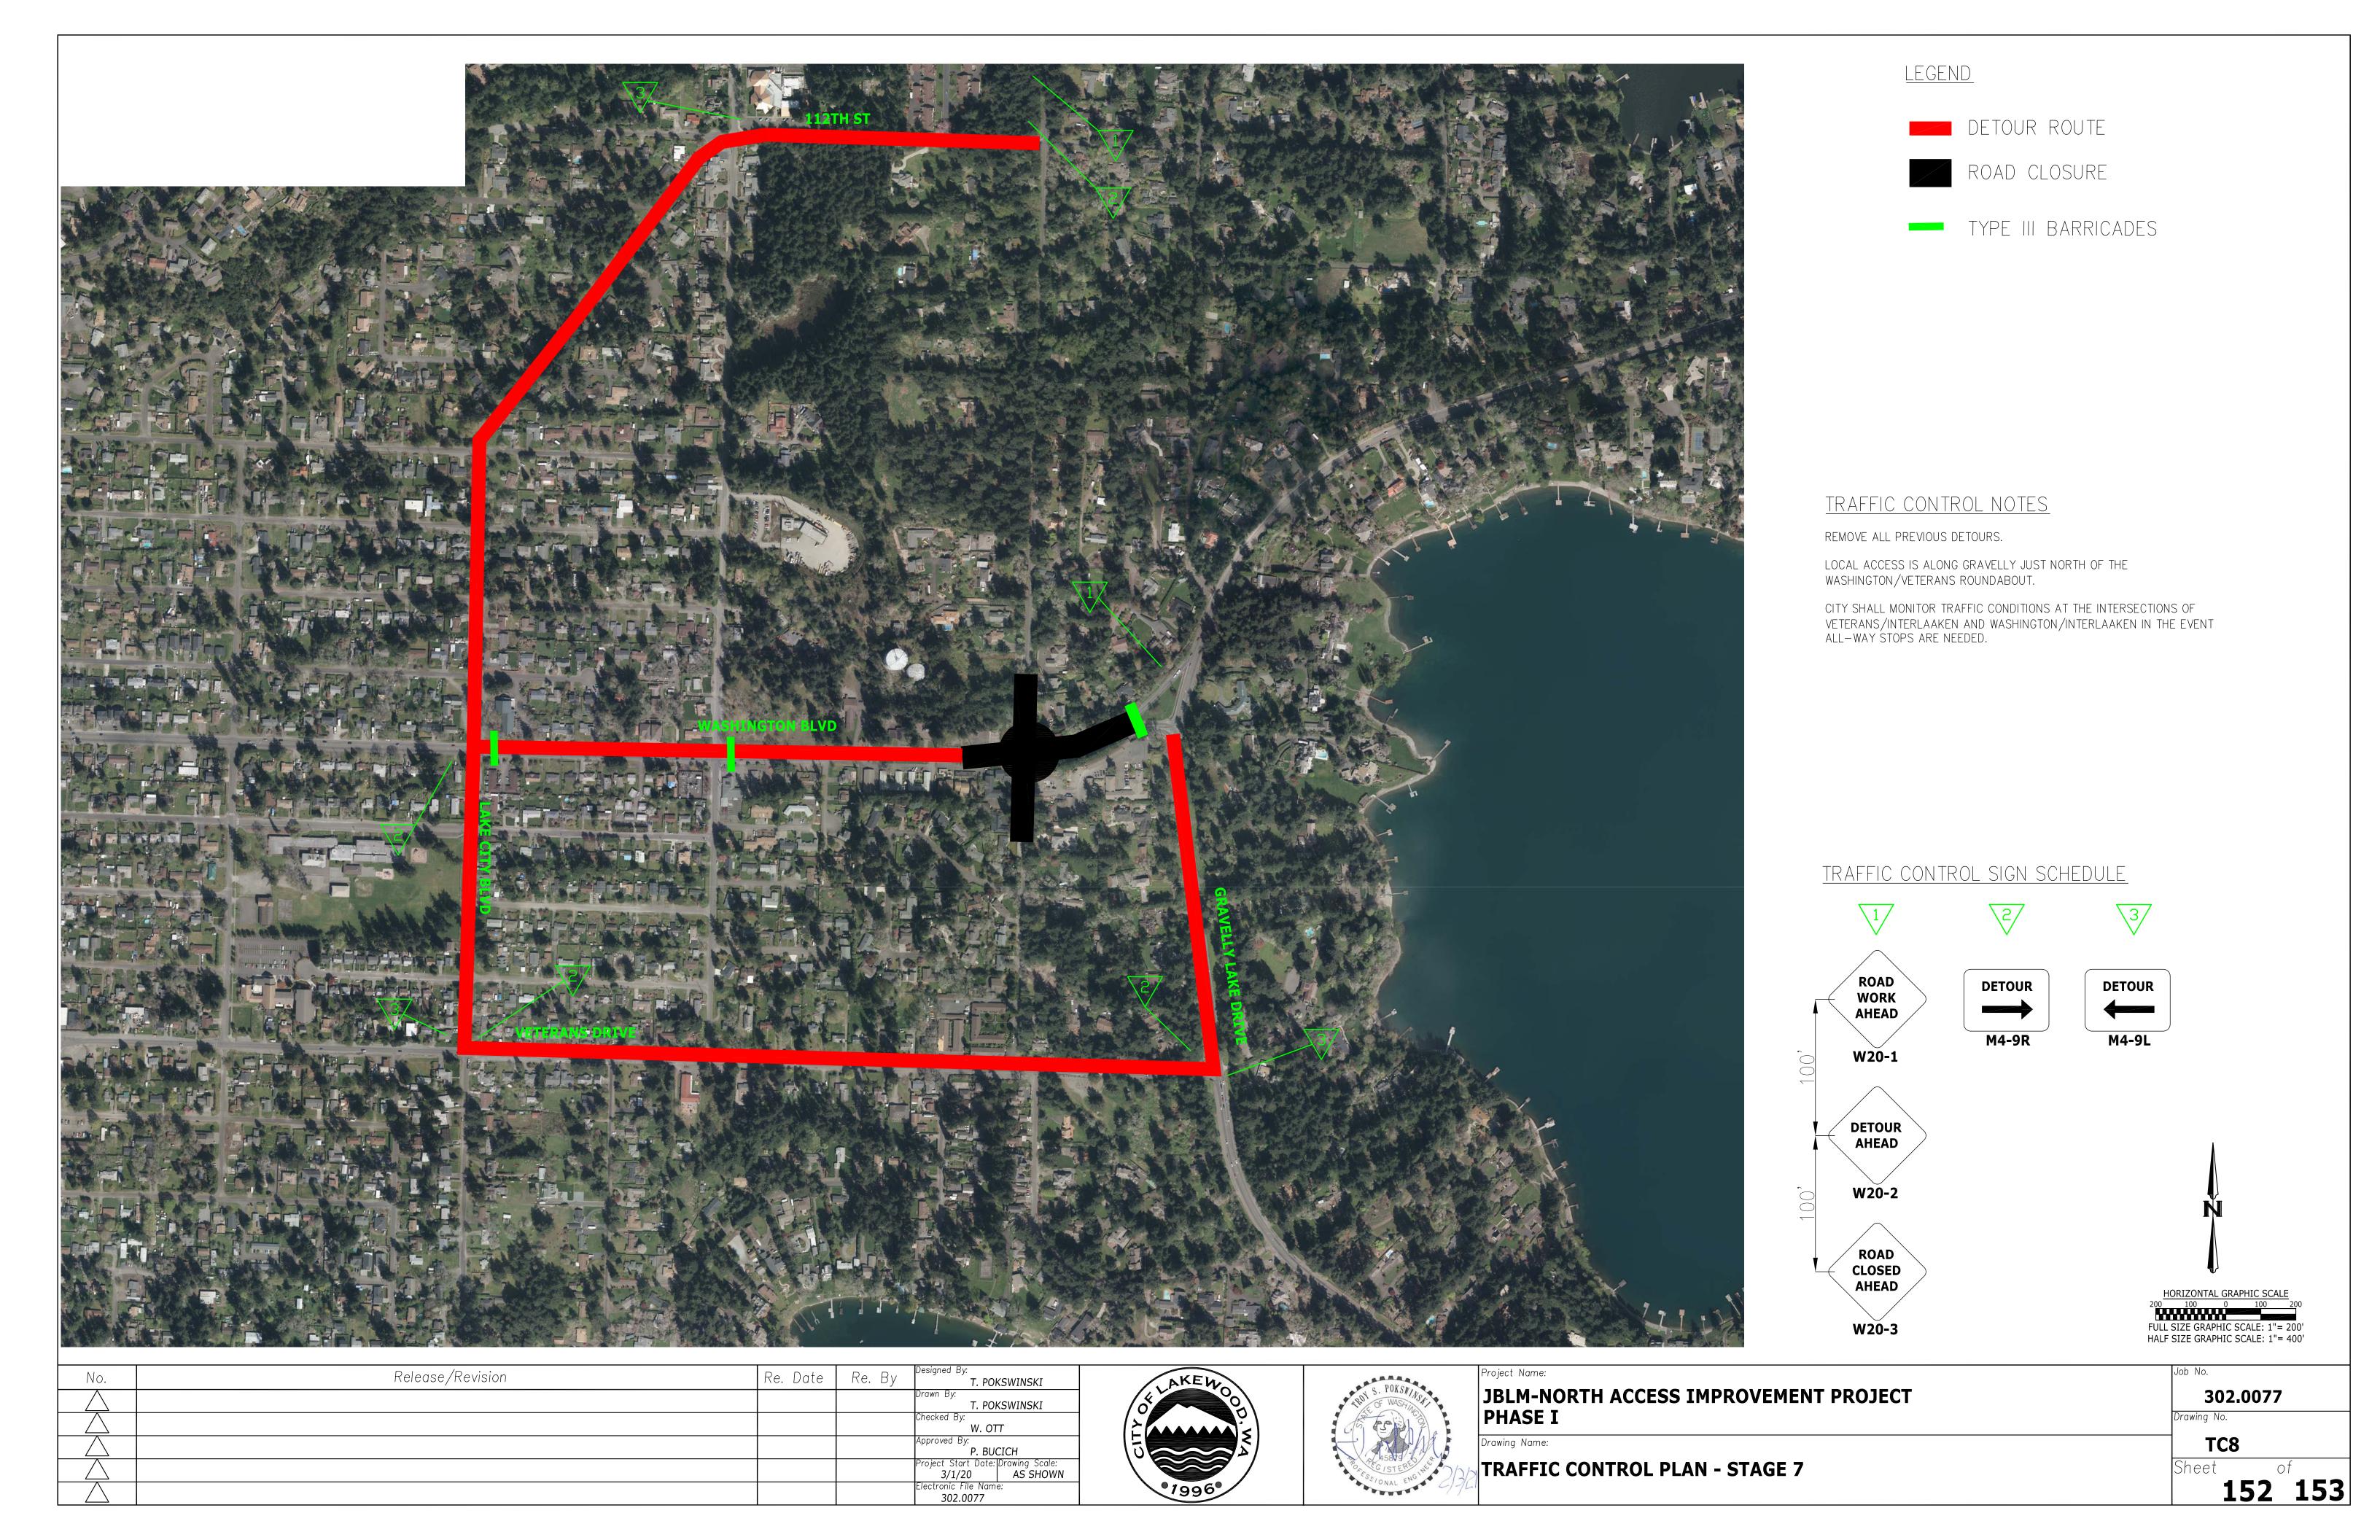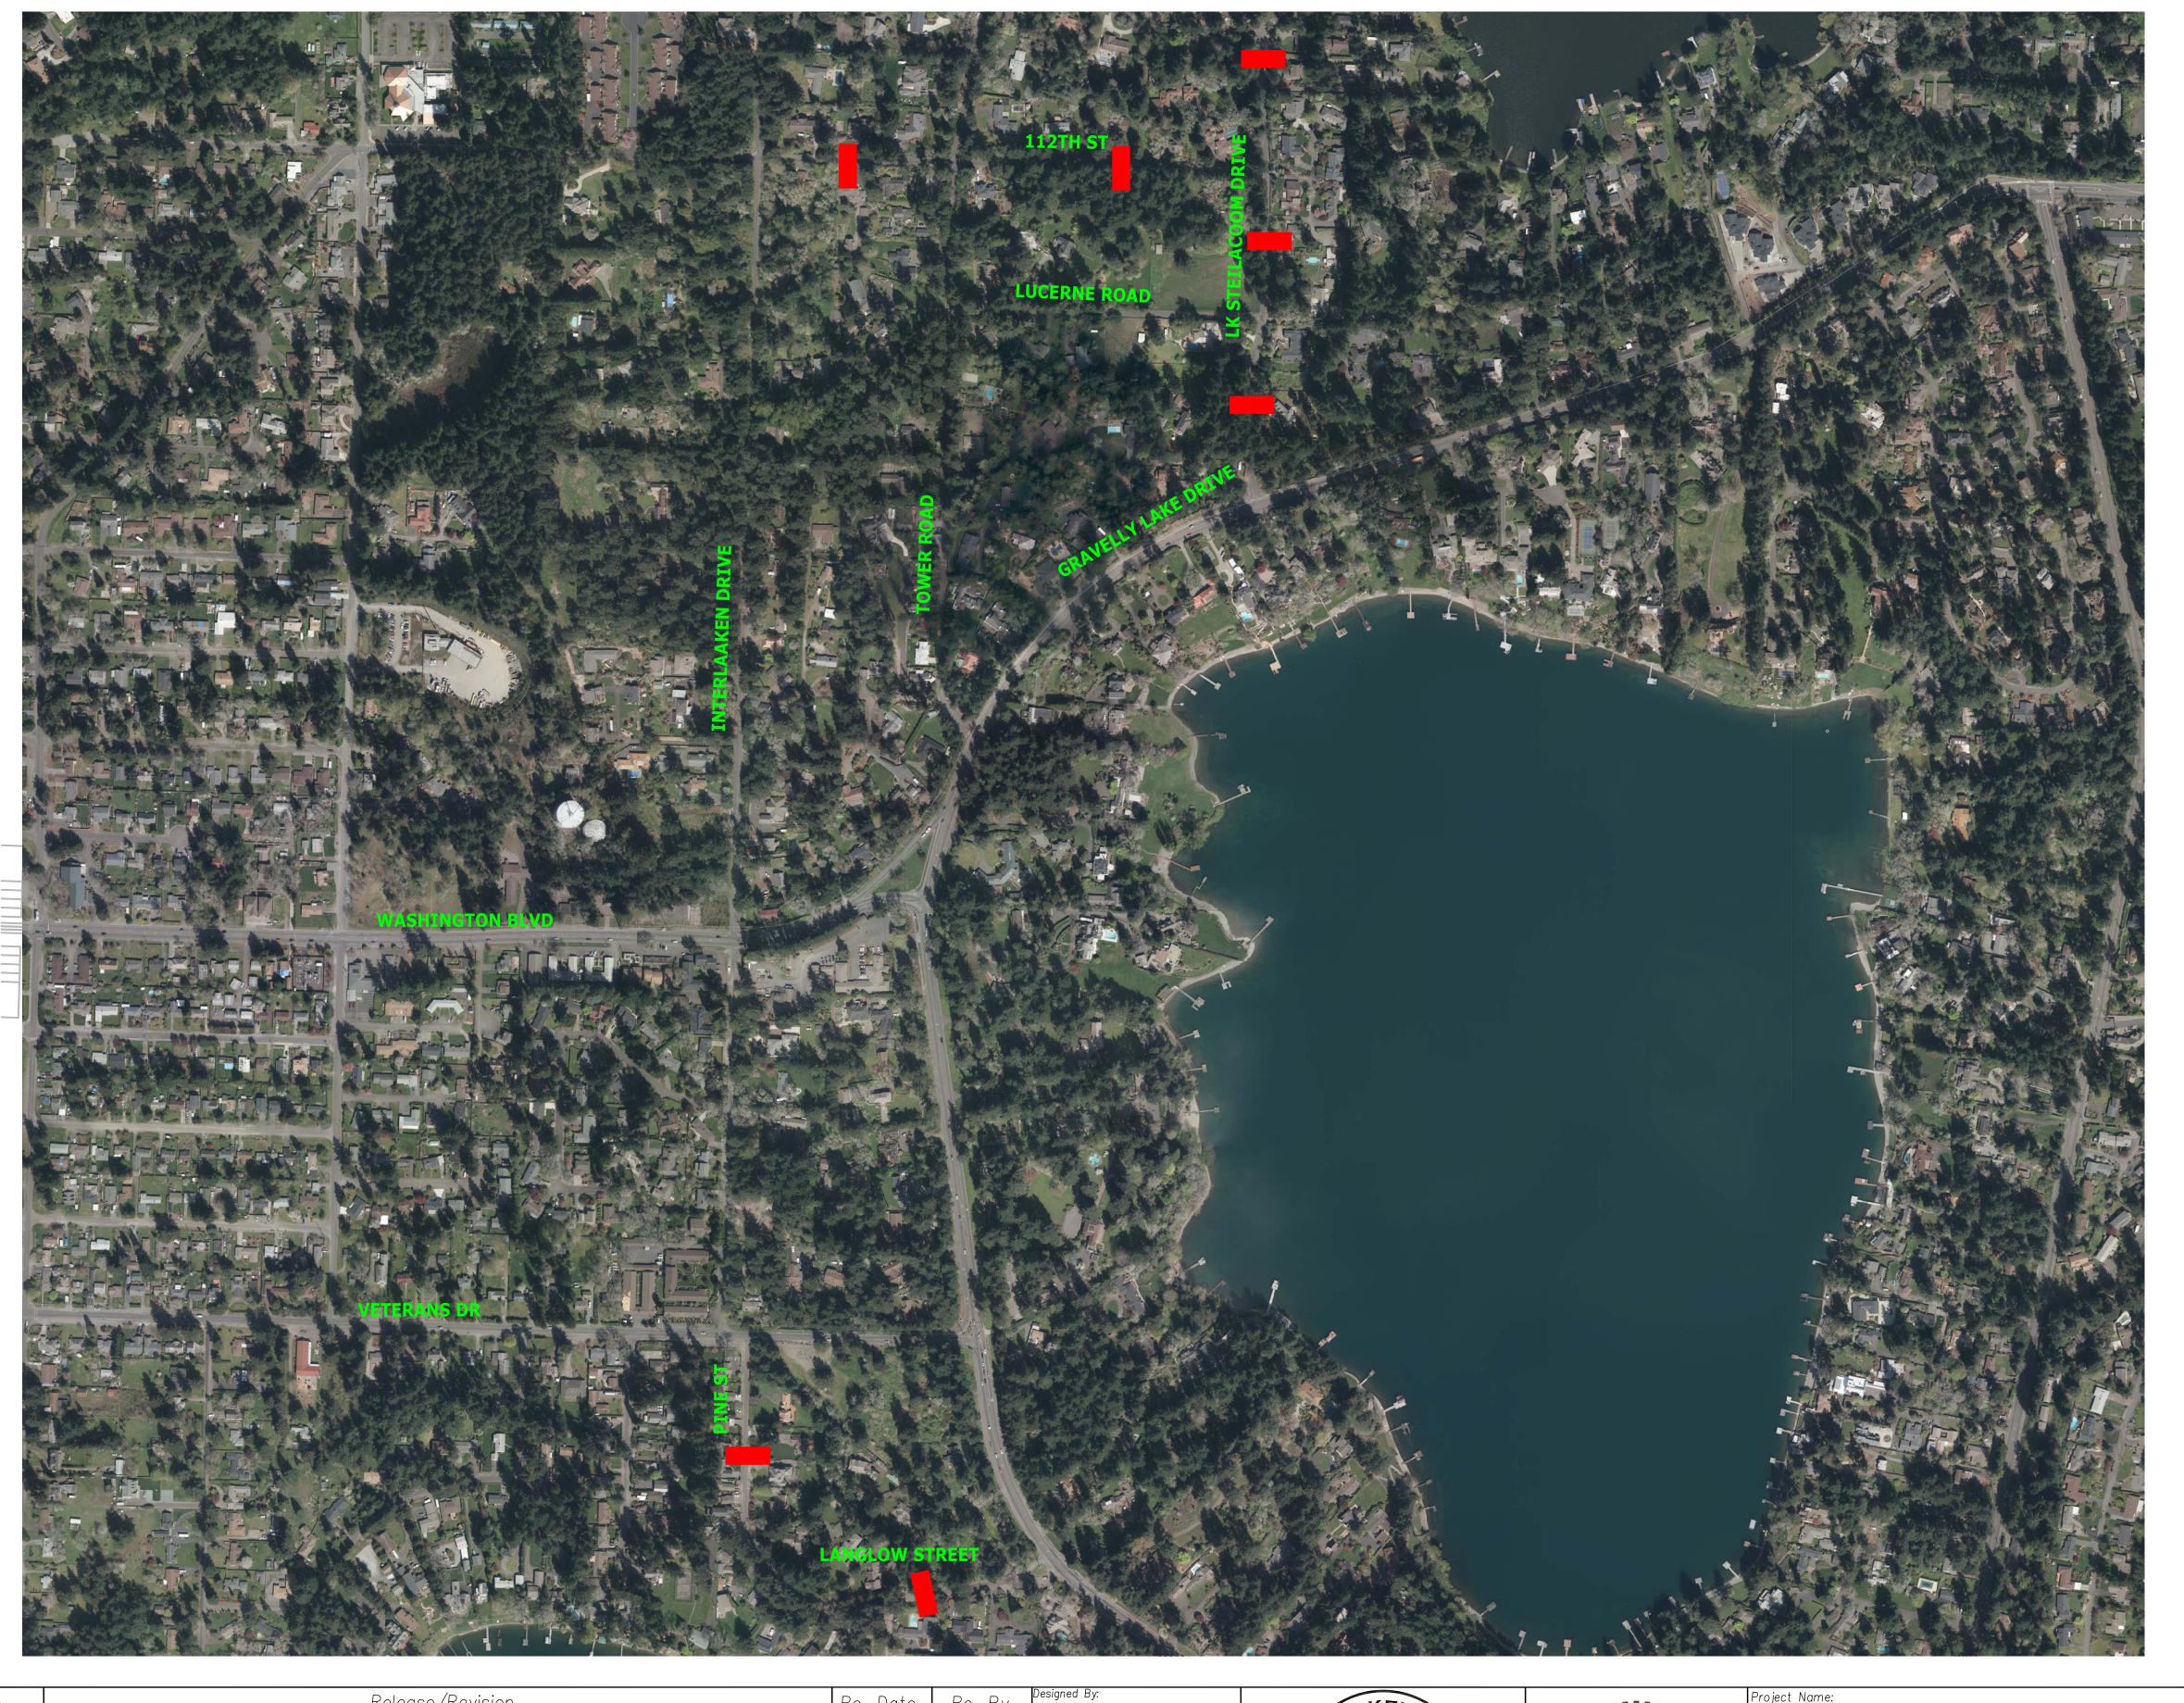Drawing No. TRAFFIC CONTROL PLAN - STAGE 5








# CONSTRUCTION NOTES


INSTALL SPEED HUMP PER DETAIL ON CITY OF LAKEWOOD STANDARD PLANS RW-07, RW-08, AND RW-09. SPEED HUMP SHALL INCLUDE SIGNING AND TRAFFIC MARKING.

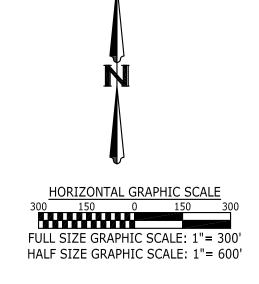LAYOUT SHALL BE COMPLETED IN THE FIELD BY THE ENGINEER.



No.	Release/Revision	Re. Date	Re. By	T. PO	KSWINSKI
				Drawn By: T. PO	KSWINSKI
				Checked By: W. O	П
				Approved By: P. BU	
				Project Start Date: 3/1/20	
				Electronic File Nam 302.0077	ne:




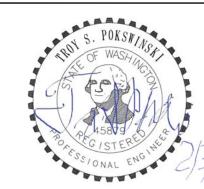

i Project Name:
JBLM-NORTH ACCESS IMPROVEMENT PROJECT
PHASE I
Drawing Name:

302.0077
Drawing No.
TCQ

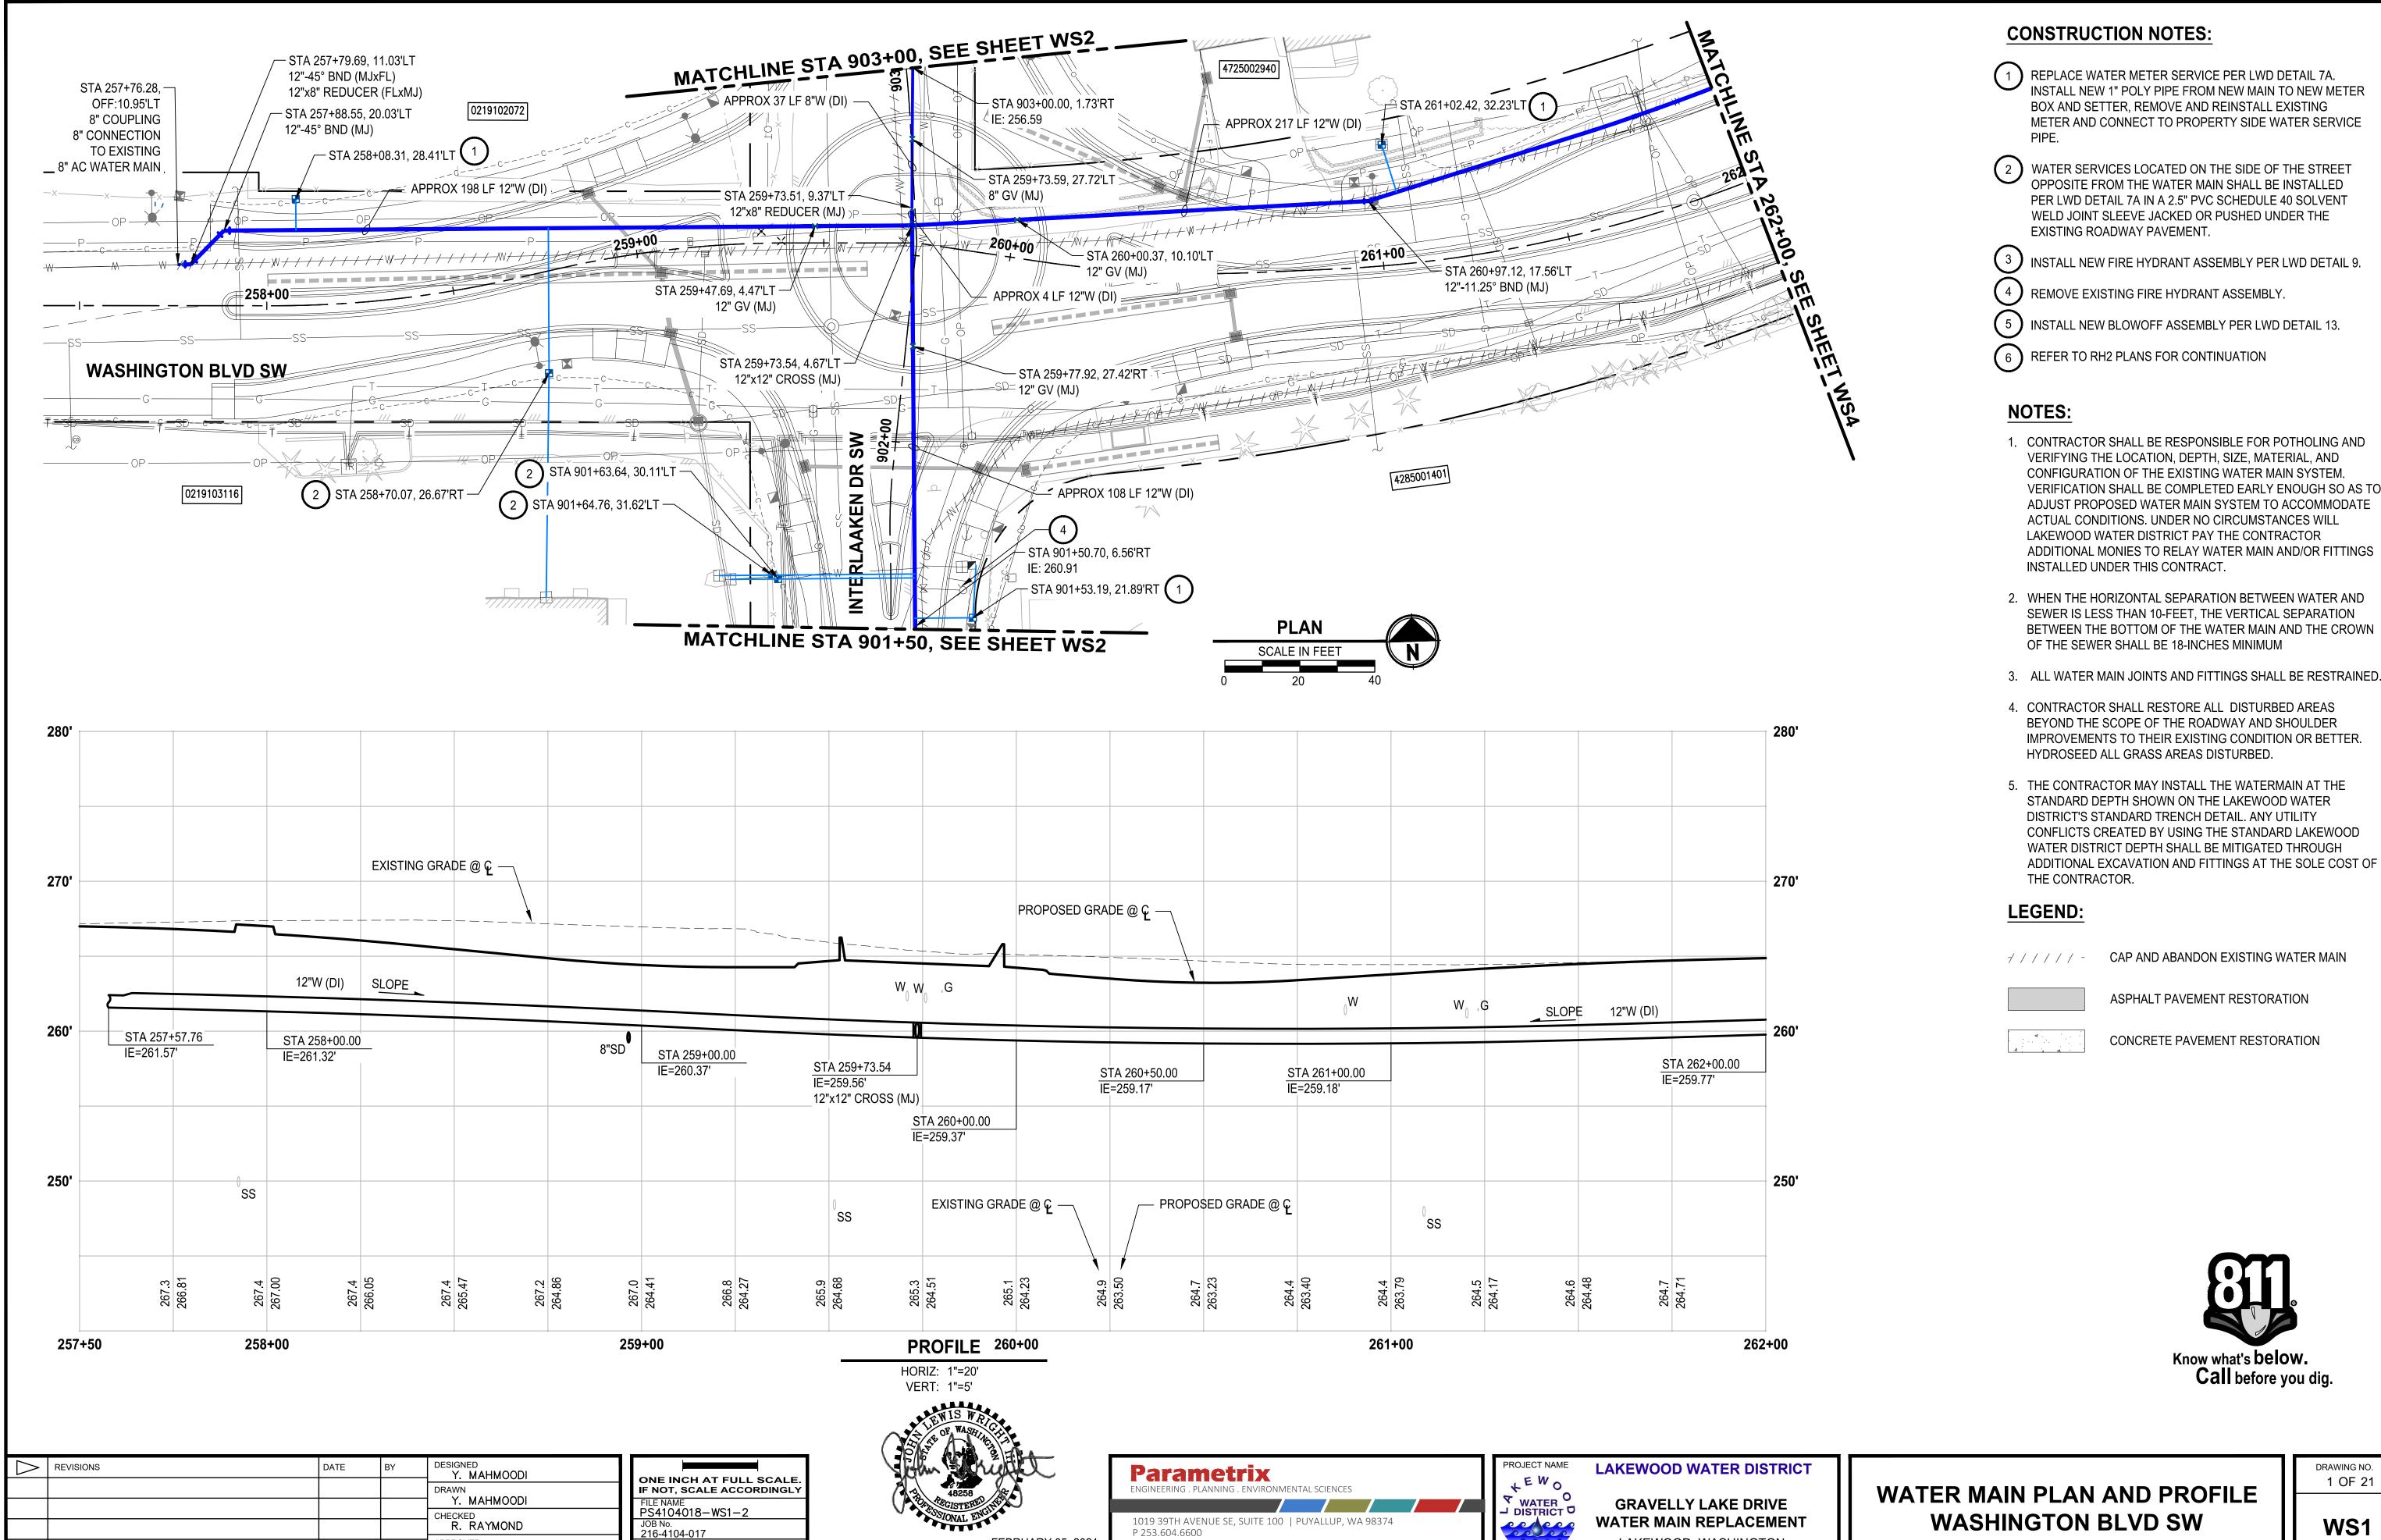TRAFFIC CONTROL PLAN - ALTERNATE ROUTE DETAILS



FEBRUARY 05, 2021

WWW.PARAMETRIX.COM

APPROVED

J. WRIGHT


DATE FEBRUARY 2021

- VERIFICATION SHALL BE COMPLETED EARLY ENOUGH SO AS TO ADJUST PROPOSED WATER MAIN SYSTEM TO ACCOMMODATE ADDITIONAL MONIES TO RELAY WATER MAIN AND/OR FITTINGS

**WASHINGTON BLVD SW** 

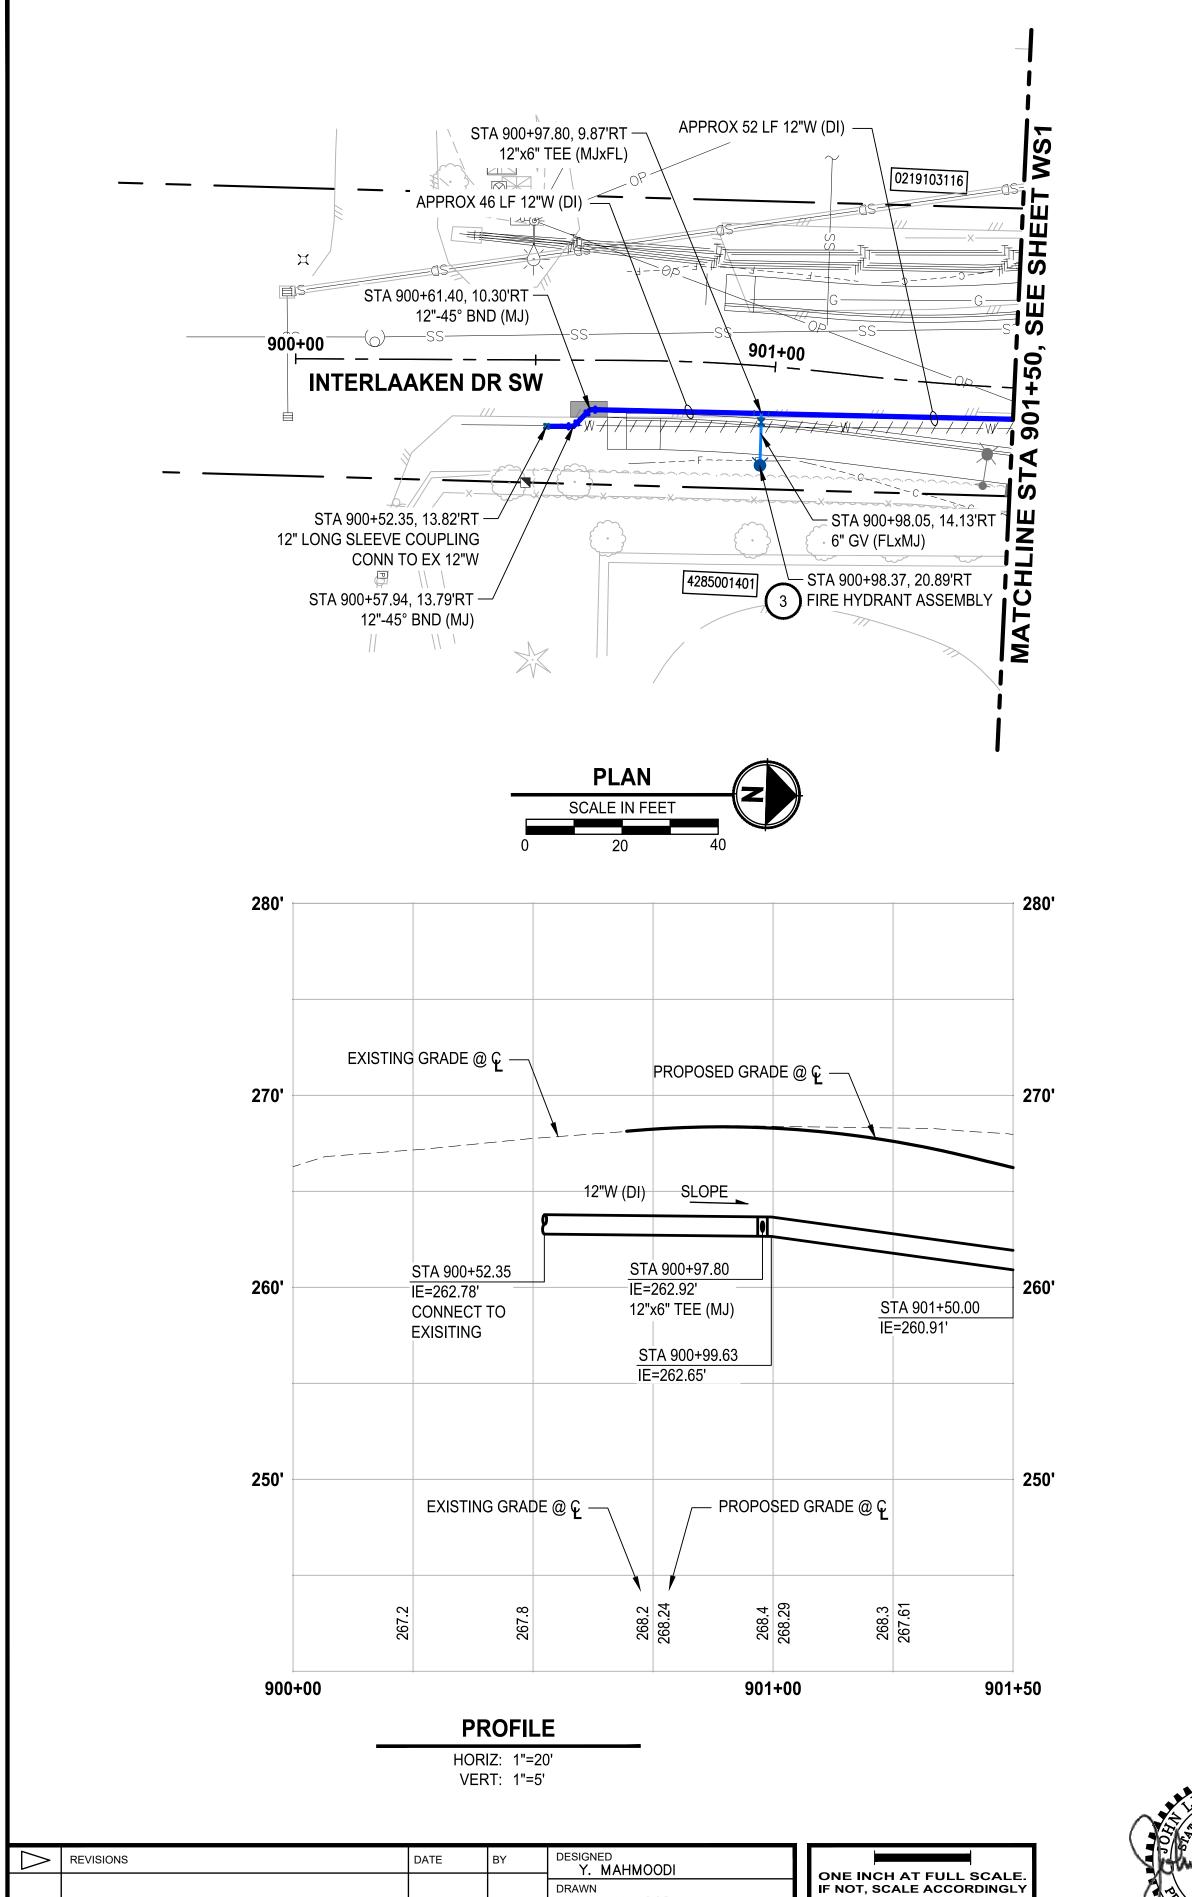LAKEWOOD, WASHINGTON

DRAWING NO. 1 OF 21



Y. MAHMOODI

R. RAYMOND

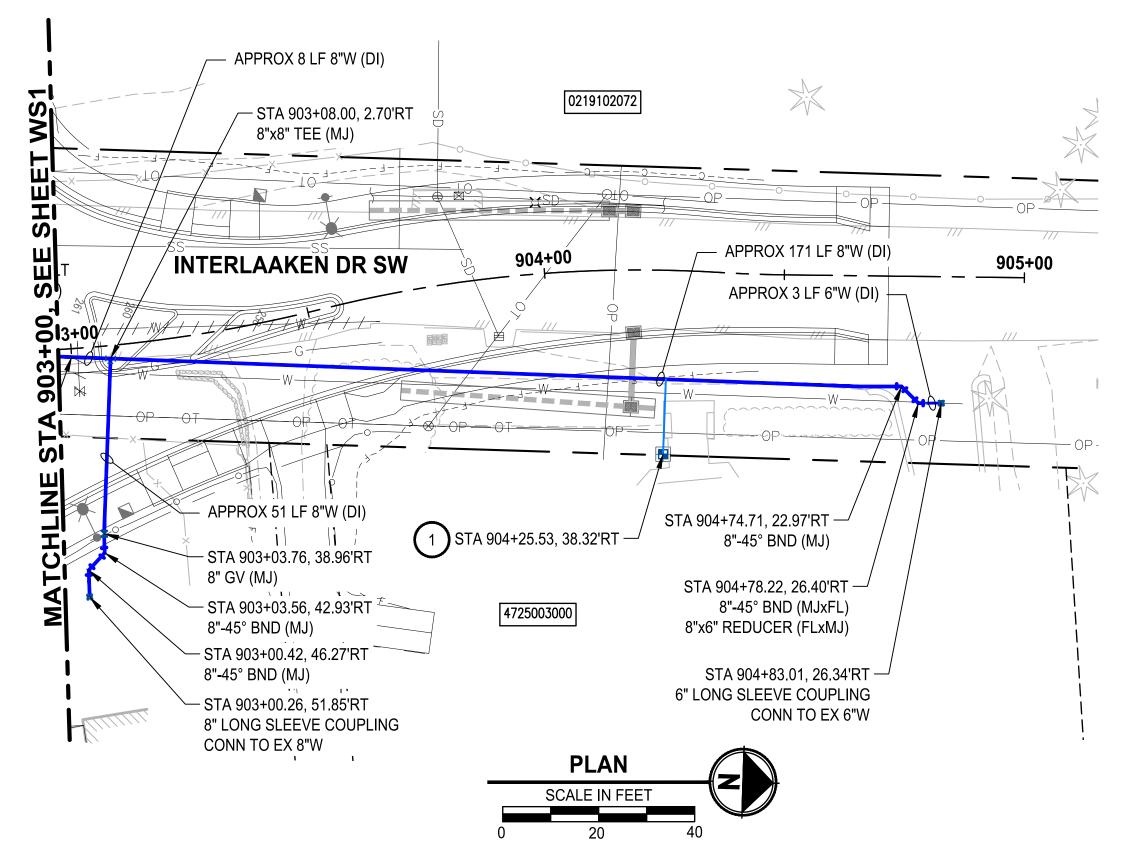
J. WRIGHT

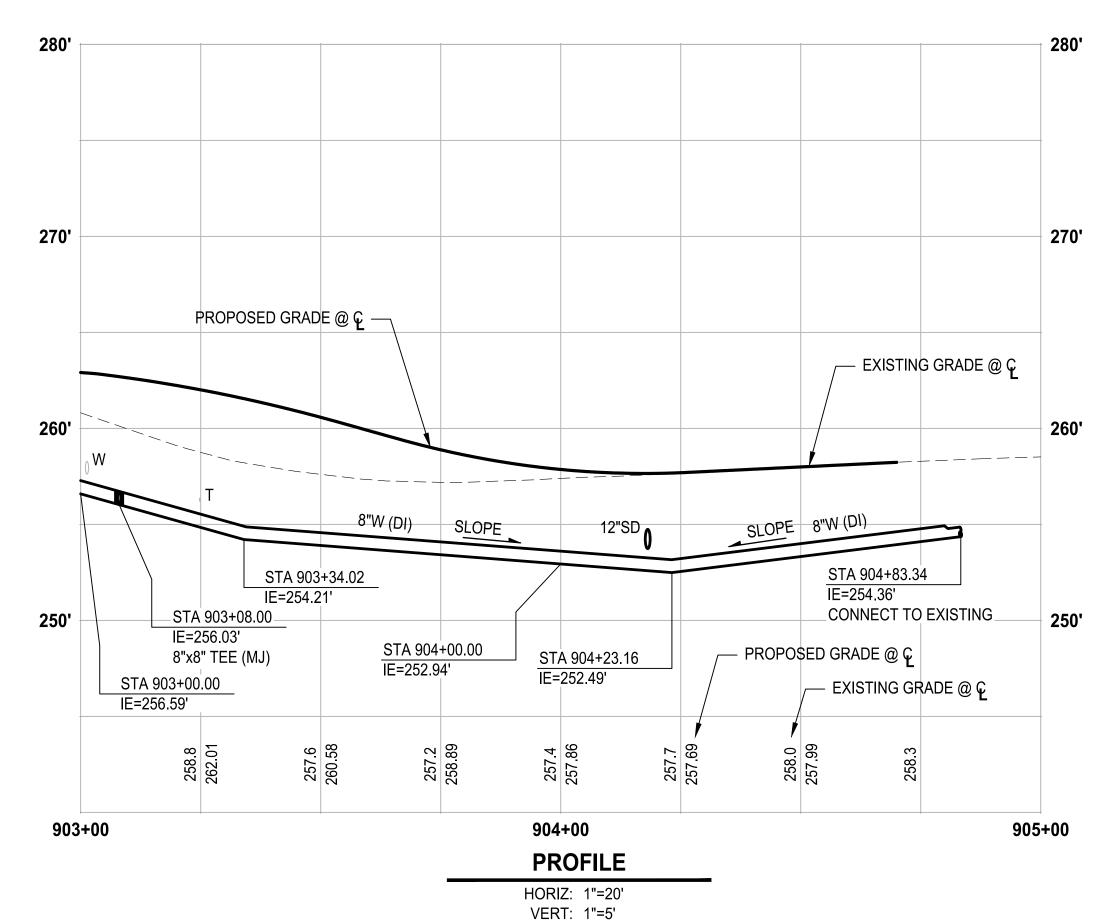
APPROVED

FILE NAME PS4104018-WS1-2

JOB No. 216-4104-017

DATE FEBRUARY 2021





#### **CONSTRUCTION NOTES:**

- 1 REPLACE WATER METER SERVICE PER LWD DETAIL 7A.
  INSTALL NEW 1" POLY PIPE FROM NEW MAIN TO NEW METER
  BOX AND SETTER, REMOVE AND REINSTALL EXISTING
  METER AND CONNECT TO PROPERTY SIDE WATER SERVICE
  PIPE.
- WATER SERVICES LOCATED ON THE SIDE OF THE STREET OPPOSITE FROM THE WATER MAIN SHALL BE INSTALLED PER LWD DETAIL 7A IN A 2.5" PVC SCHEDULE 40 SOLVENT WELD JOINT SLEEVE JACKED OR PUSHED UNDER THE EXISTING ROADWAY PAVEMENT.
- (3) INSTALL NEW FIRE HYDRANT ASSEMBLY PER LWD DETAIL 9.
- 4 REMOVE EXISTING FIRE HYDRANT ASSEMBLY.
- ( 5 ) INSTALL NEW BLOWOFF ASSEMBLY PER LWD DETAIL 13.
- 6 REFER TO RH2 PLANS FOR CONTINUATION

#### NOTES:

- 1. CONTRACTOR SHALL BE RESPONSIBLE FOR POTHOLING AND VERIFYING THE LOCATION, DEPTH, SIZE, MATERIAL, AND CONFIGURATION OF THE EXISTING WATER MAIN SYSTEM. VERIFICATION SHALL BE COMPLETED EARLY ENOUGH SO AS TO ADJUST PROPOSED WATER MAIN SYSTEM TO ACCOMMODATE ACTUAL CONDITIONS. UNDER NO CIRCUMSTANCES WILL LAKEWOOD WATER DISTRICT PAY THE CONTRACTOR ADDITIONAL MONIES TO RELAY WATER MAIN AND/OR FITTINGS INSTALLED UNDER THIS CONTRACT.
- 2. WHEN THE HORIZONTAL SEPARATION BETWEEN WATER AND SEWER IS LESS THAN 10-FEET, THE VERTICAL SEPARATION BETWEEN THE BOTTOM OF THE WATER MAIN AND THE CROWN OF THE SEWER SHALL BE 18-INCHES MINIMUM
- 3. ALL WATER MAIN JOINTS AND FITTINGS SHALL BE RESTRAINED.
- 4. CONTRACTOR SHALL RESTORE ALL DISTURBED AREAS BEYOND THE SCOPE OF THE ROADWAY AND SHOULDER IMPROVEMENTS TO THEIR EXISTING CONDITION OR BETTER. HYDROSEED ALL GRASS AREAS DISTURBED.
- 5. THE CONTRACTOR MAY INSTALL THE WATERMAIN AT THE STANDARD DEPTH SHOWN ON THE LAKEWOOD WATER DISTRICT'S STANDARD TRENCH DETAIL. ANY UTILITY CONFLICTS CREATED BY USING THE STANDARD LAKEWOOD WATER DISTRICT DEPTH SHALL BE MITIGATED THROUGH ADDITIONAL EXCAVATION AND FITTINGS AT THE SOLE COST OF THE CONTRACTOR.

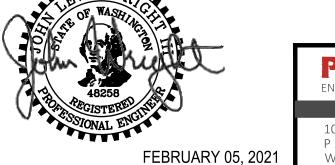
# LEGEND:

/ / / / / - CAP AND ABANDON EXISTING WATER MAIN

ASPHALT PAVEMENT RESTORATION

CONCRETE PAVEMENT RESTORATION

Know what's below.
Call before you dig.








WATER MAIN PLAN AND PROFILE INTERLAKKEN DR SW

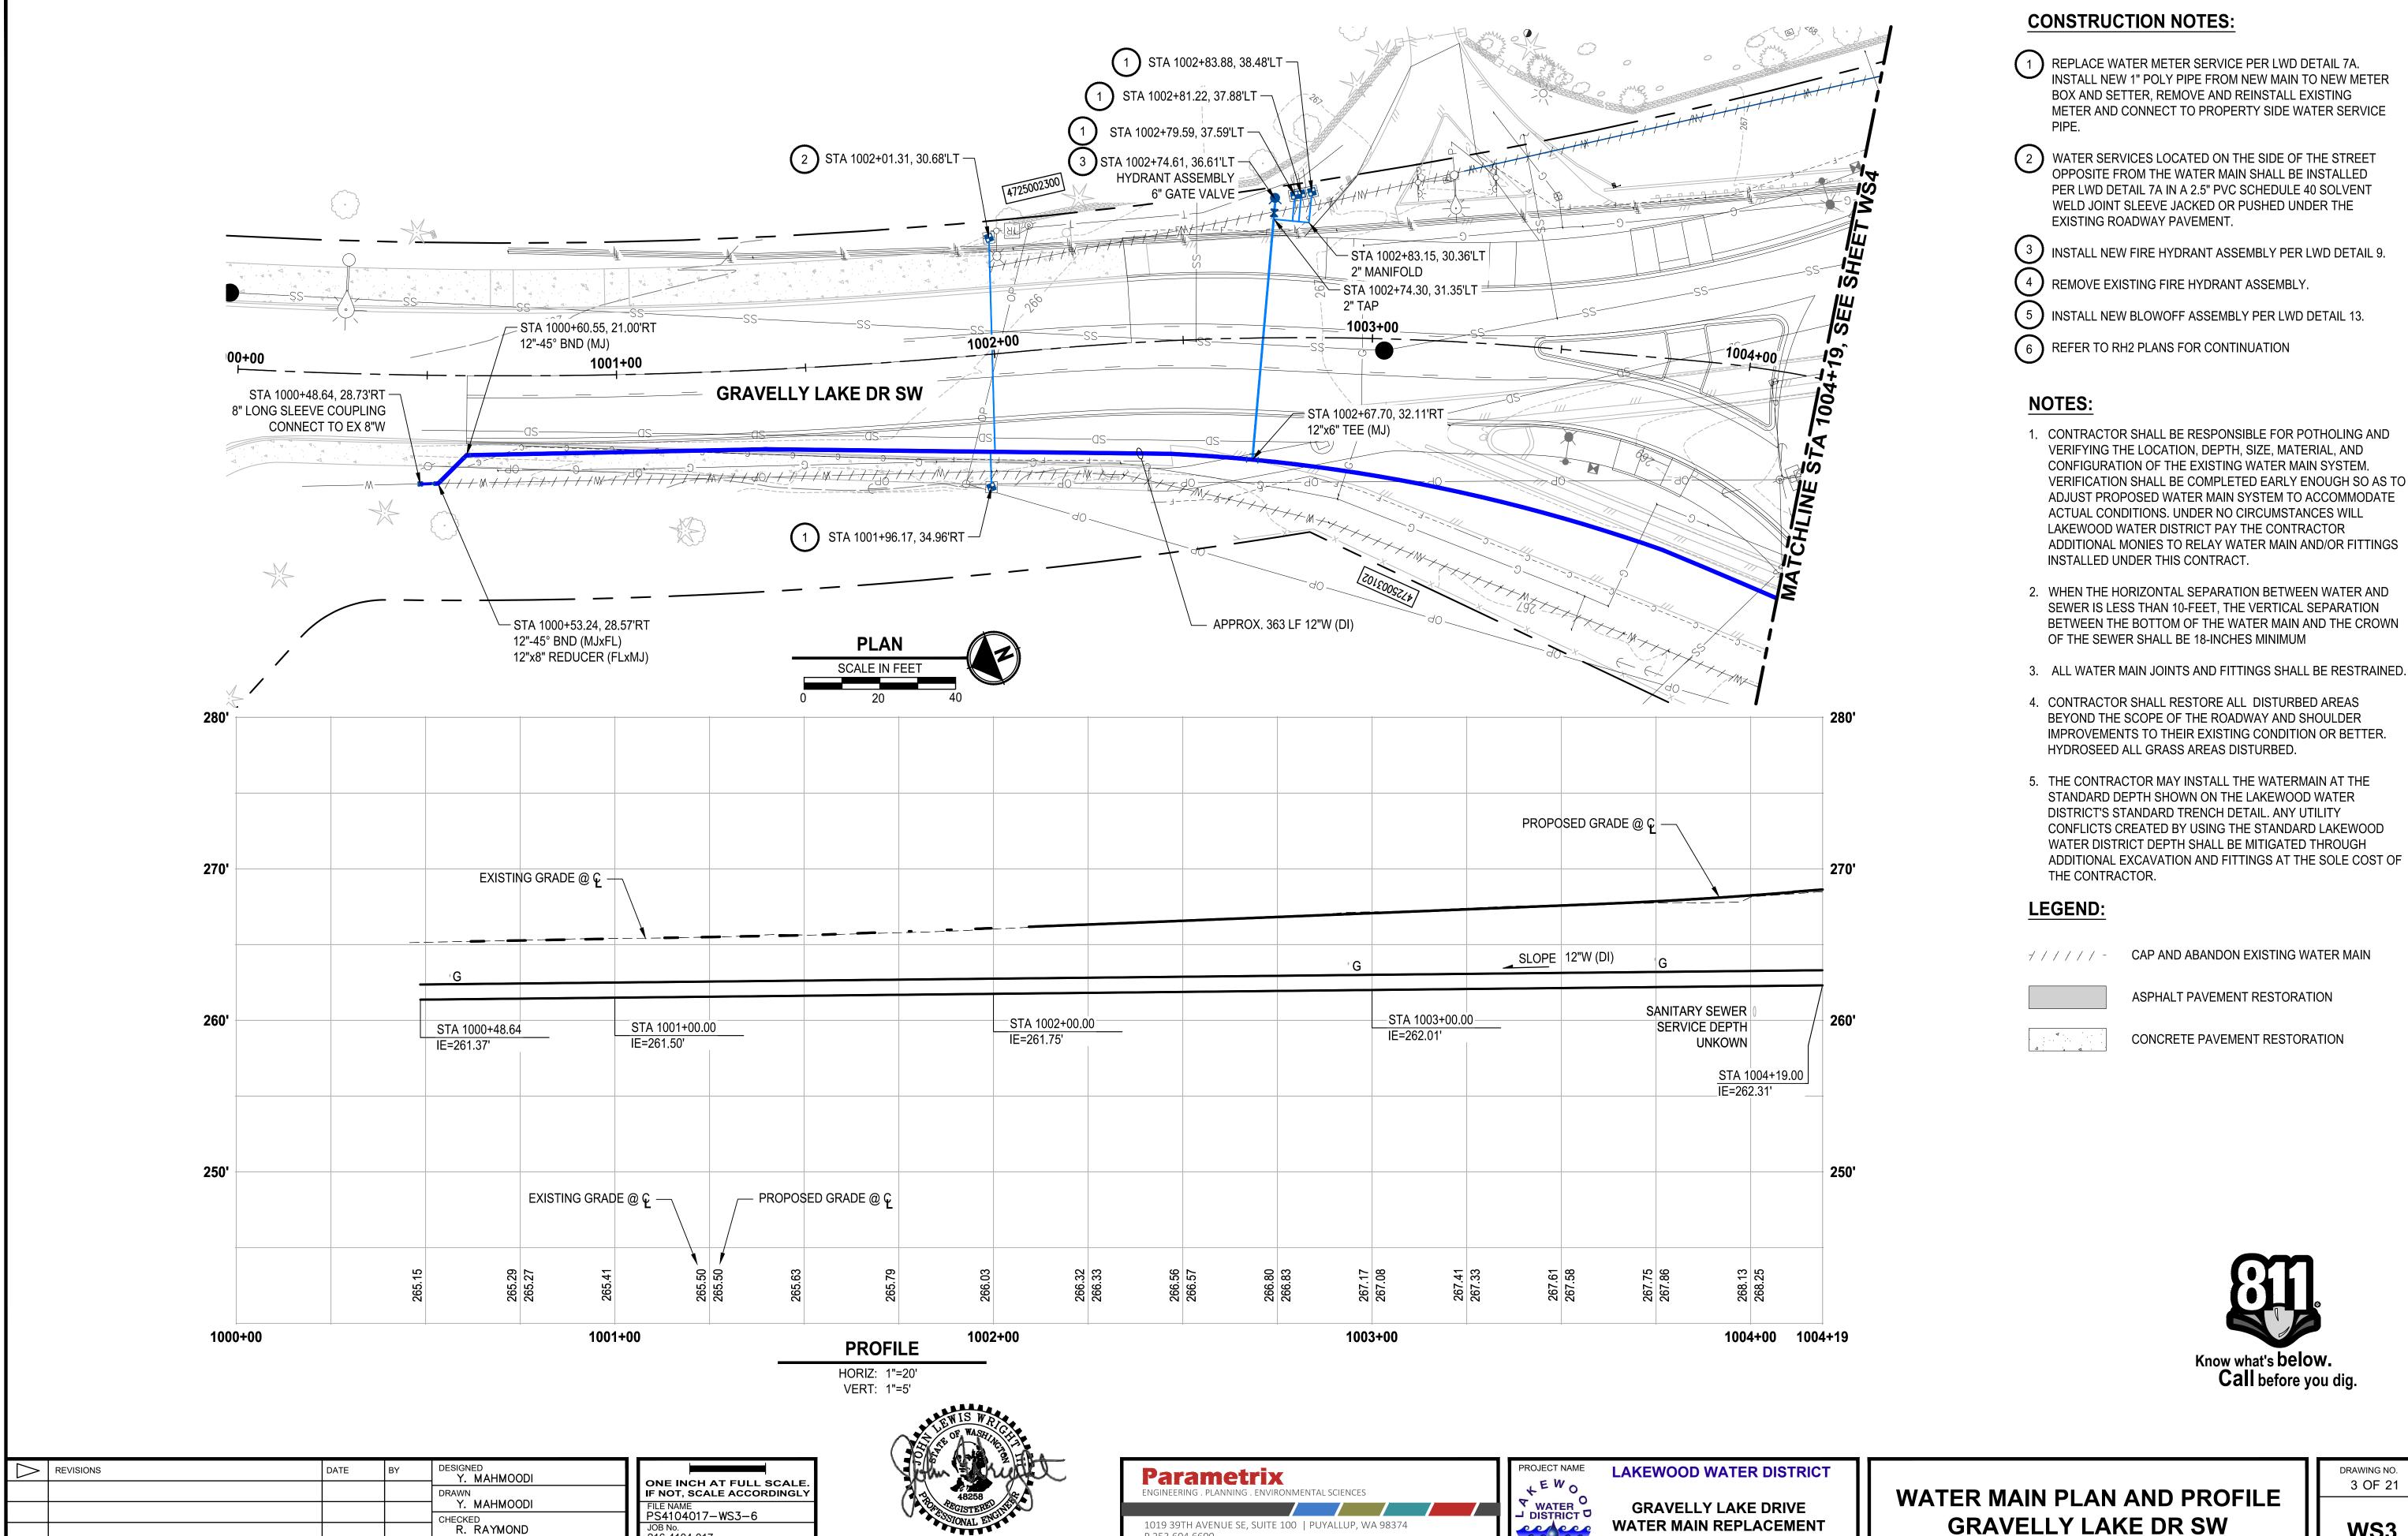DRAWING NO. 2 OF 21



1019 39TH AVENUE SE, SUITE 100 | PUYALLUP, WA 98374

LAKEWOOD, WASHINGTON

P 253.604.6600

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FEBRUARY 05, 2021

R. RAYMOND

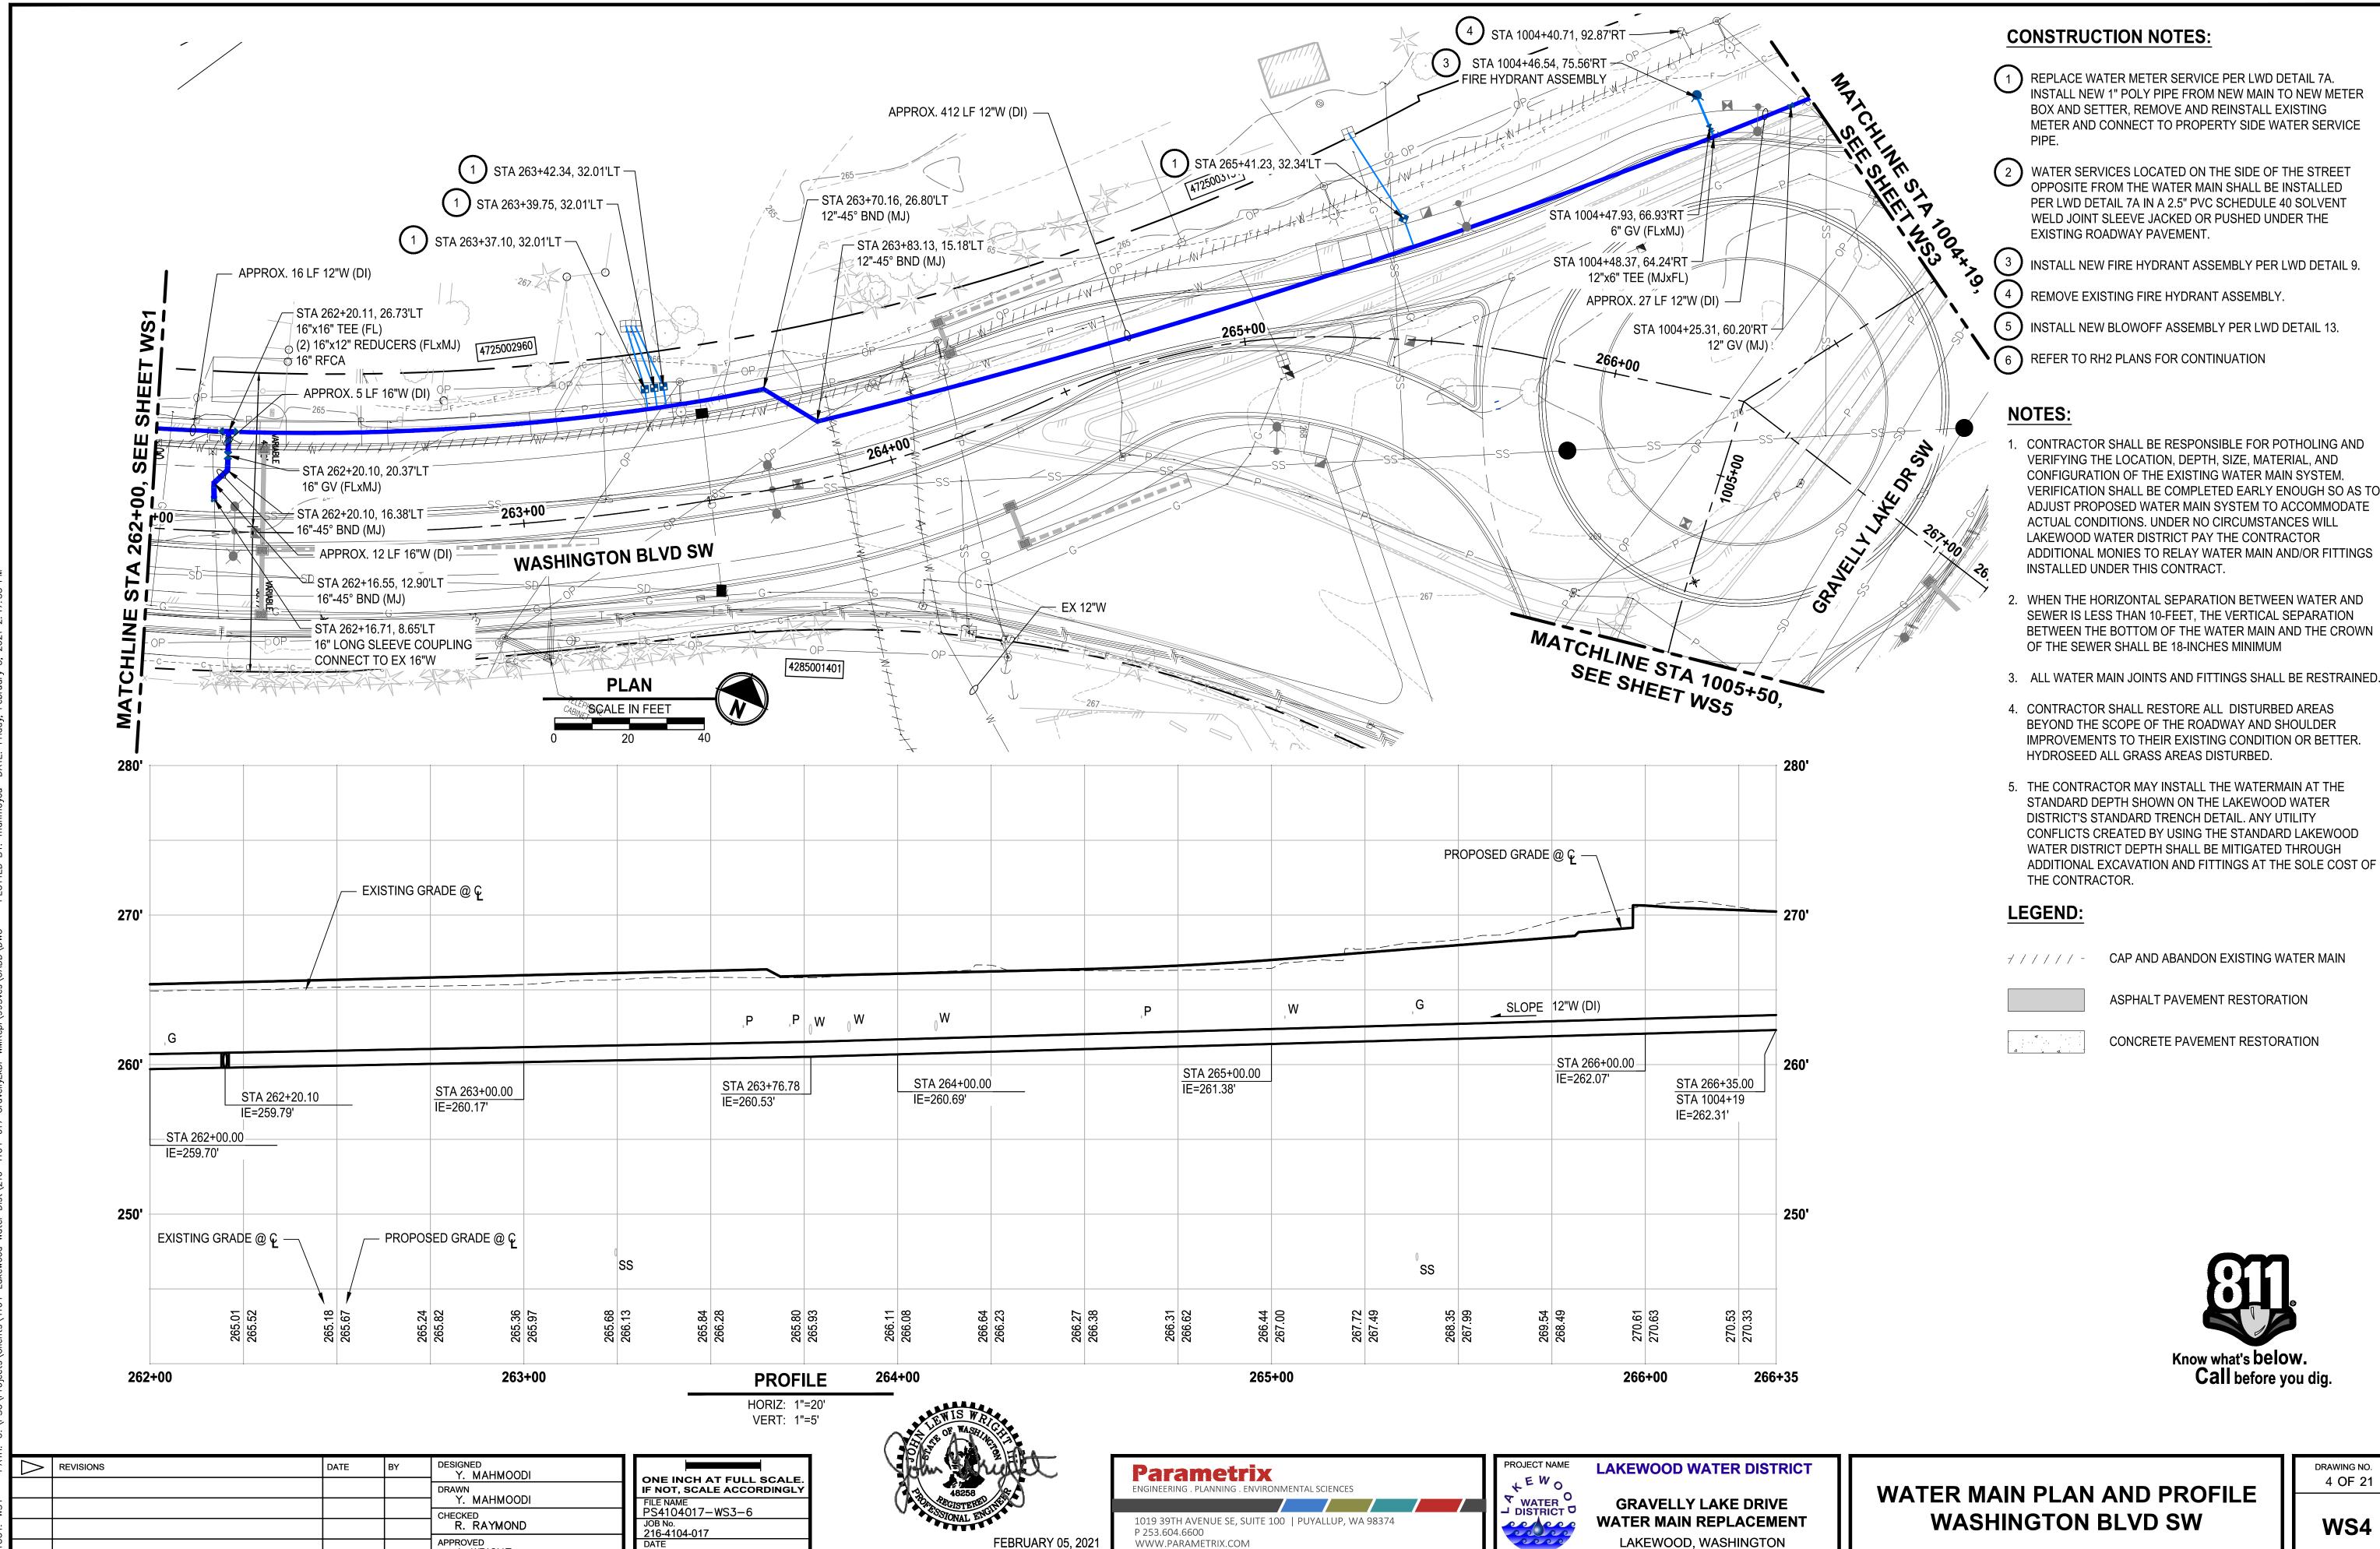
J. WRIGHT

APPROVED

JOB No. 216-4104-017

DATE FEBRUARY 2021

DRAWING NO. 3 OF 21




FEBRUARY 05, 2021


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J. WRIGHT

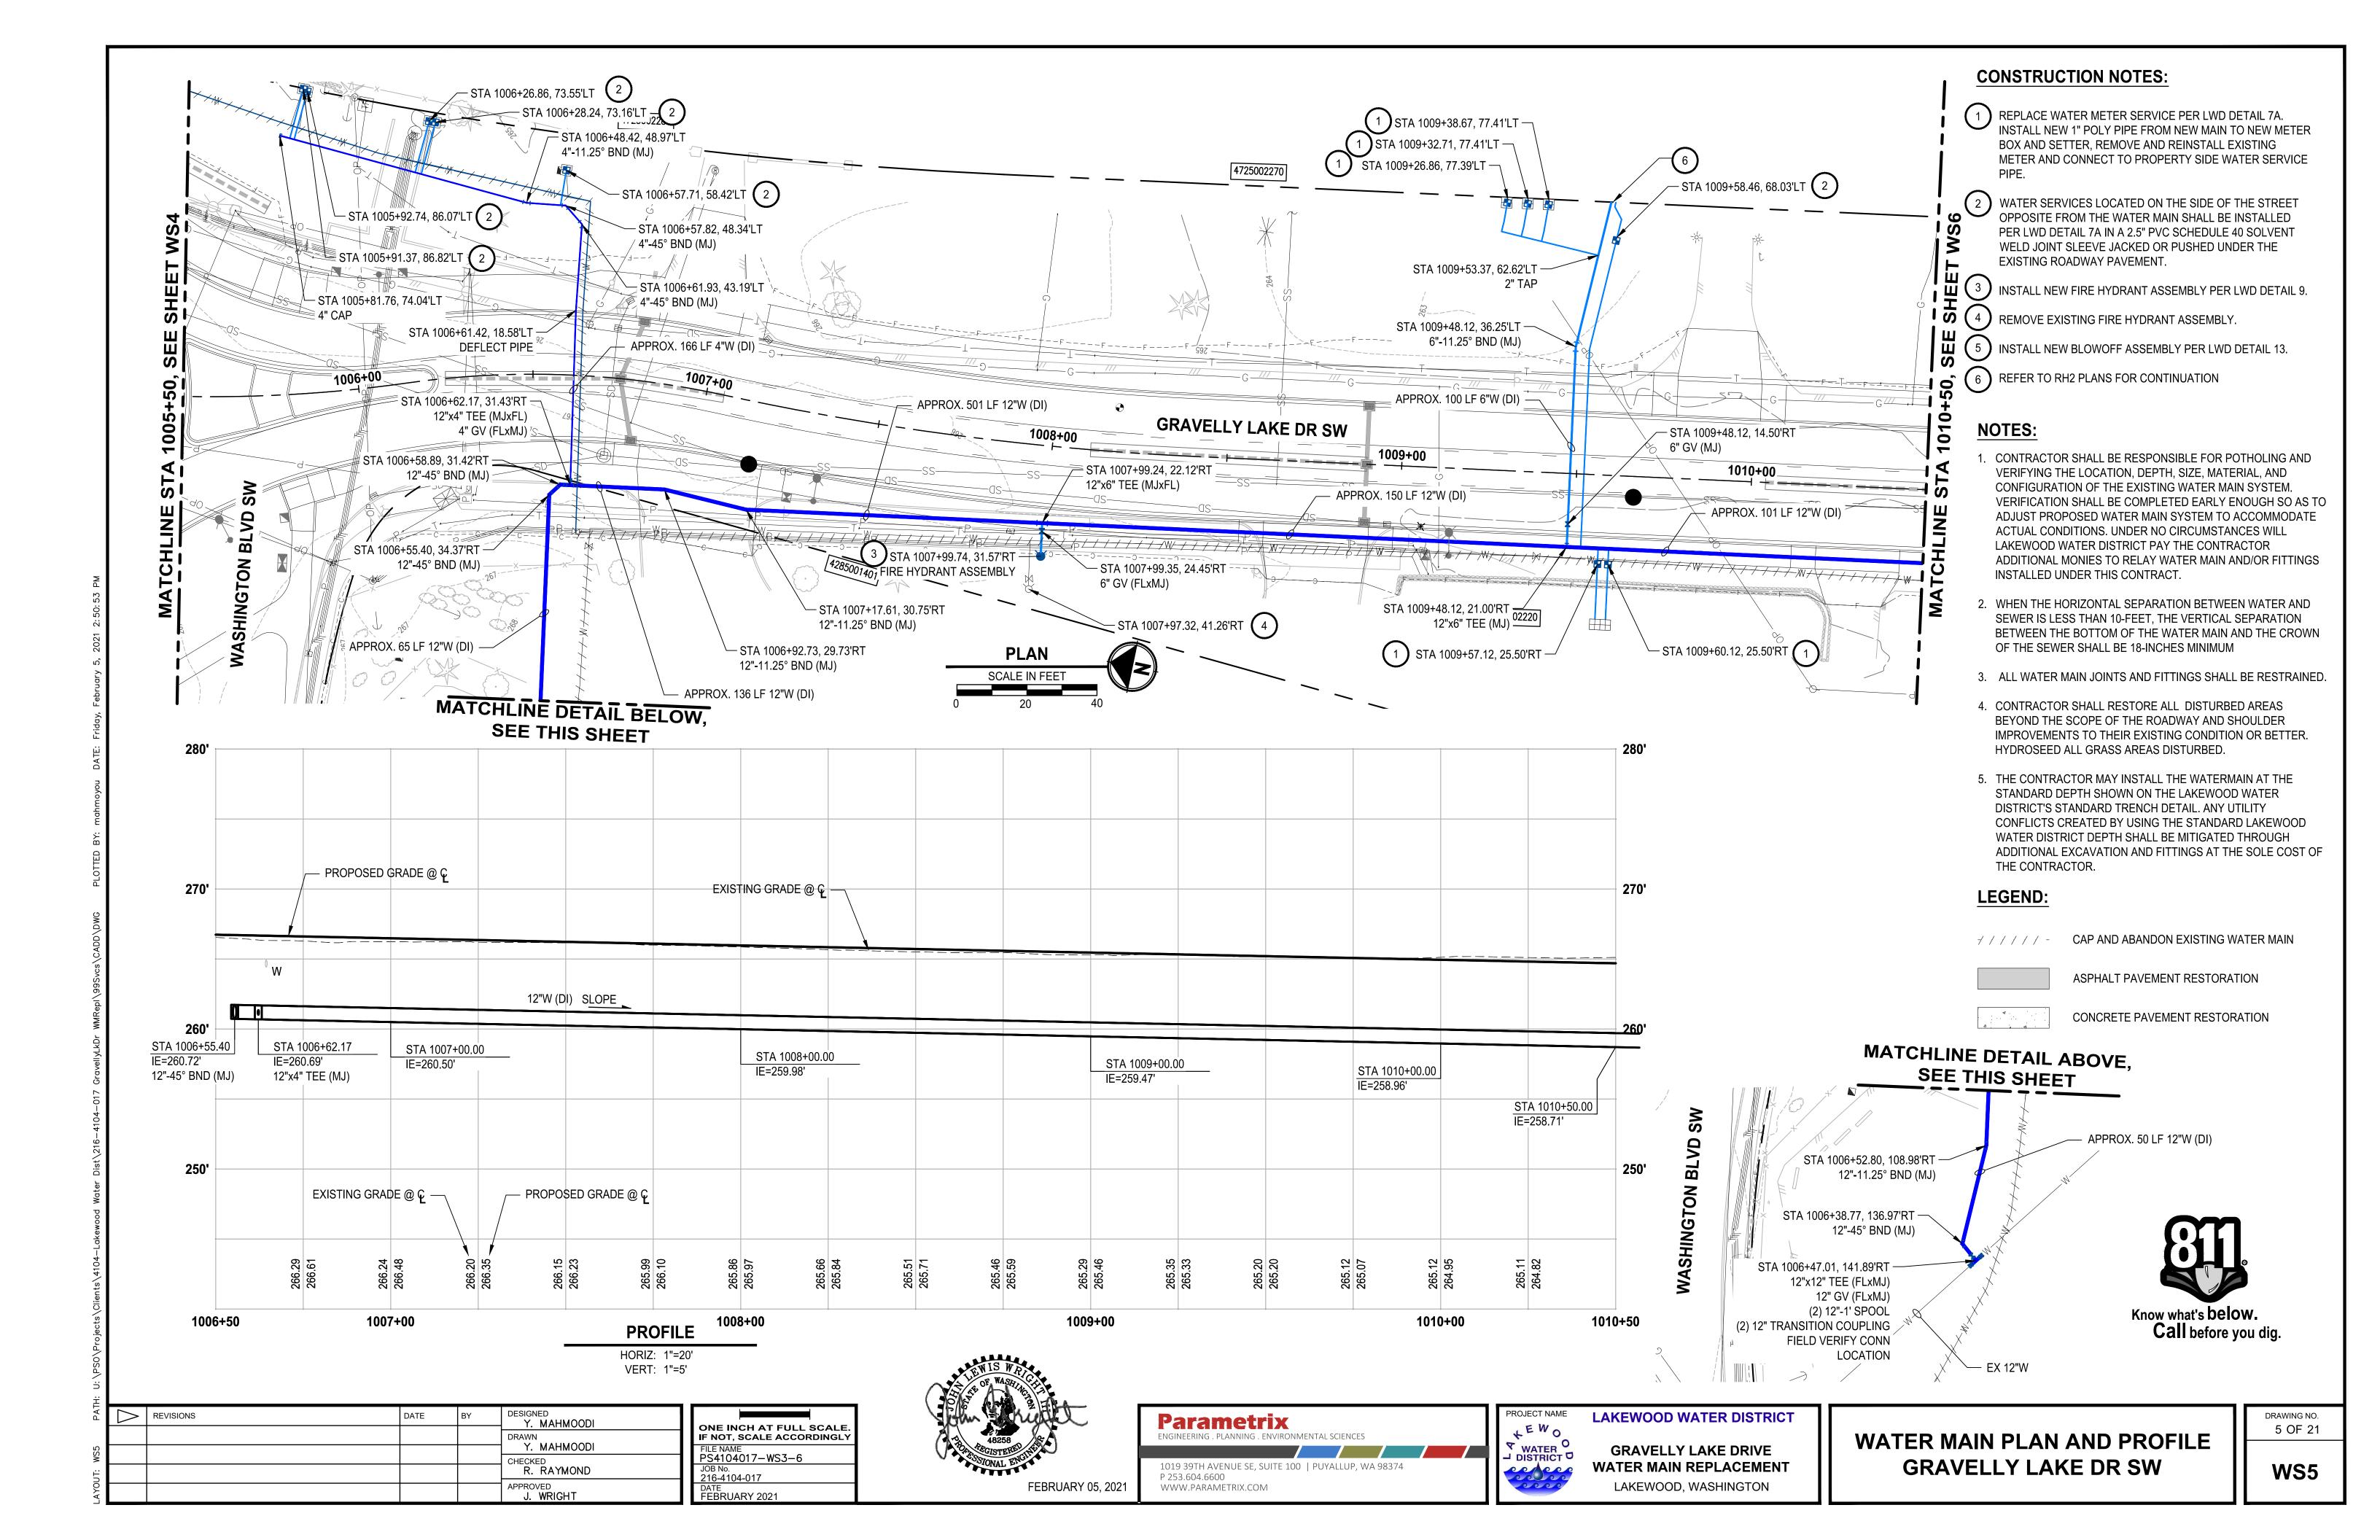DATE FEBRUARY 2021





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LAKEWOOD, WASHINGTON
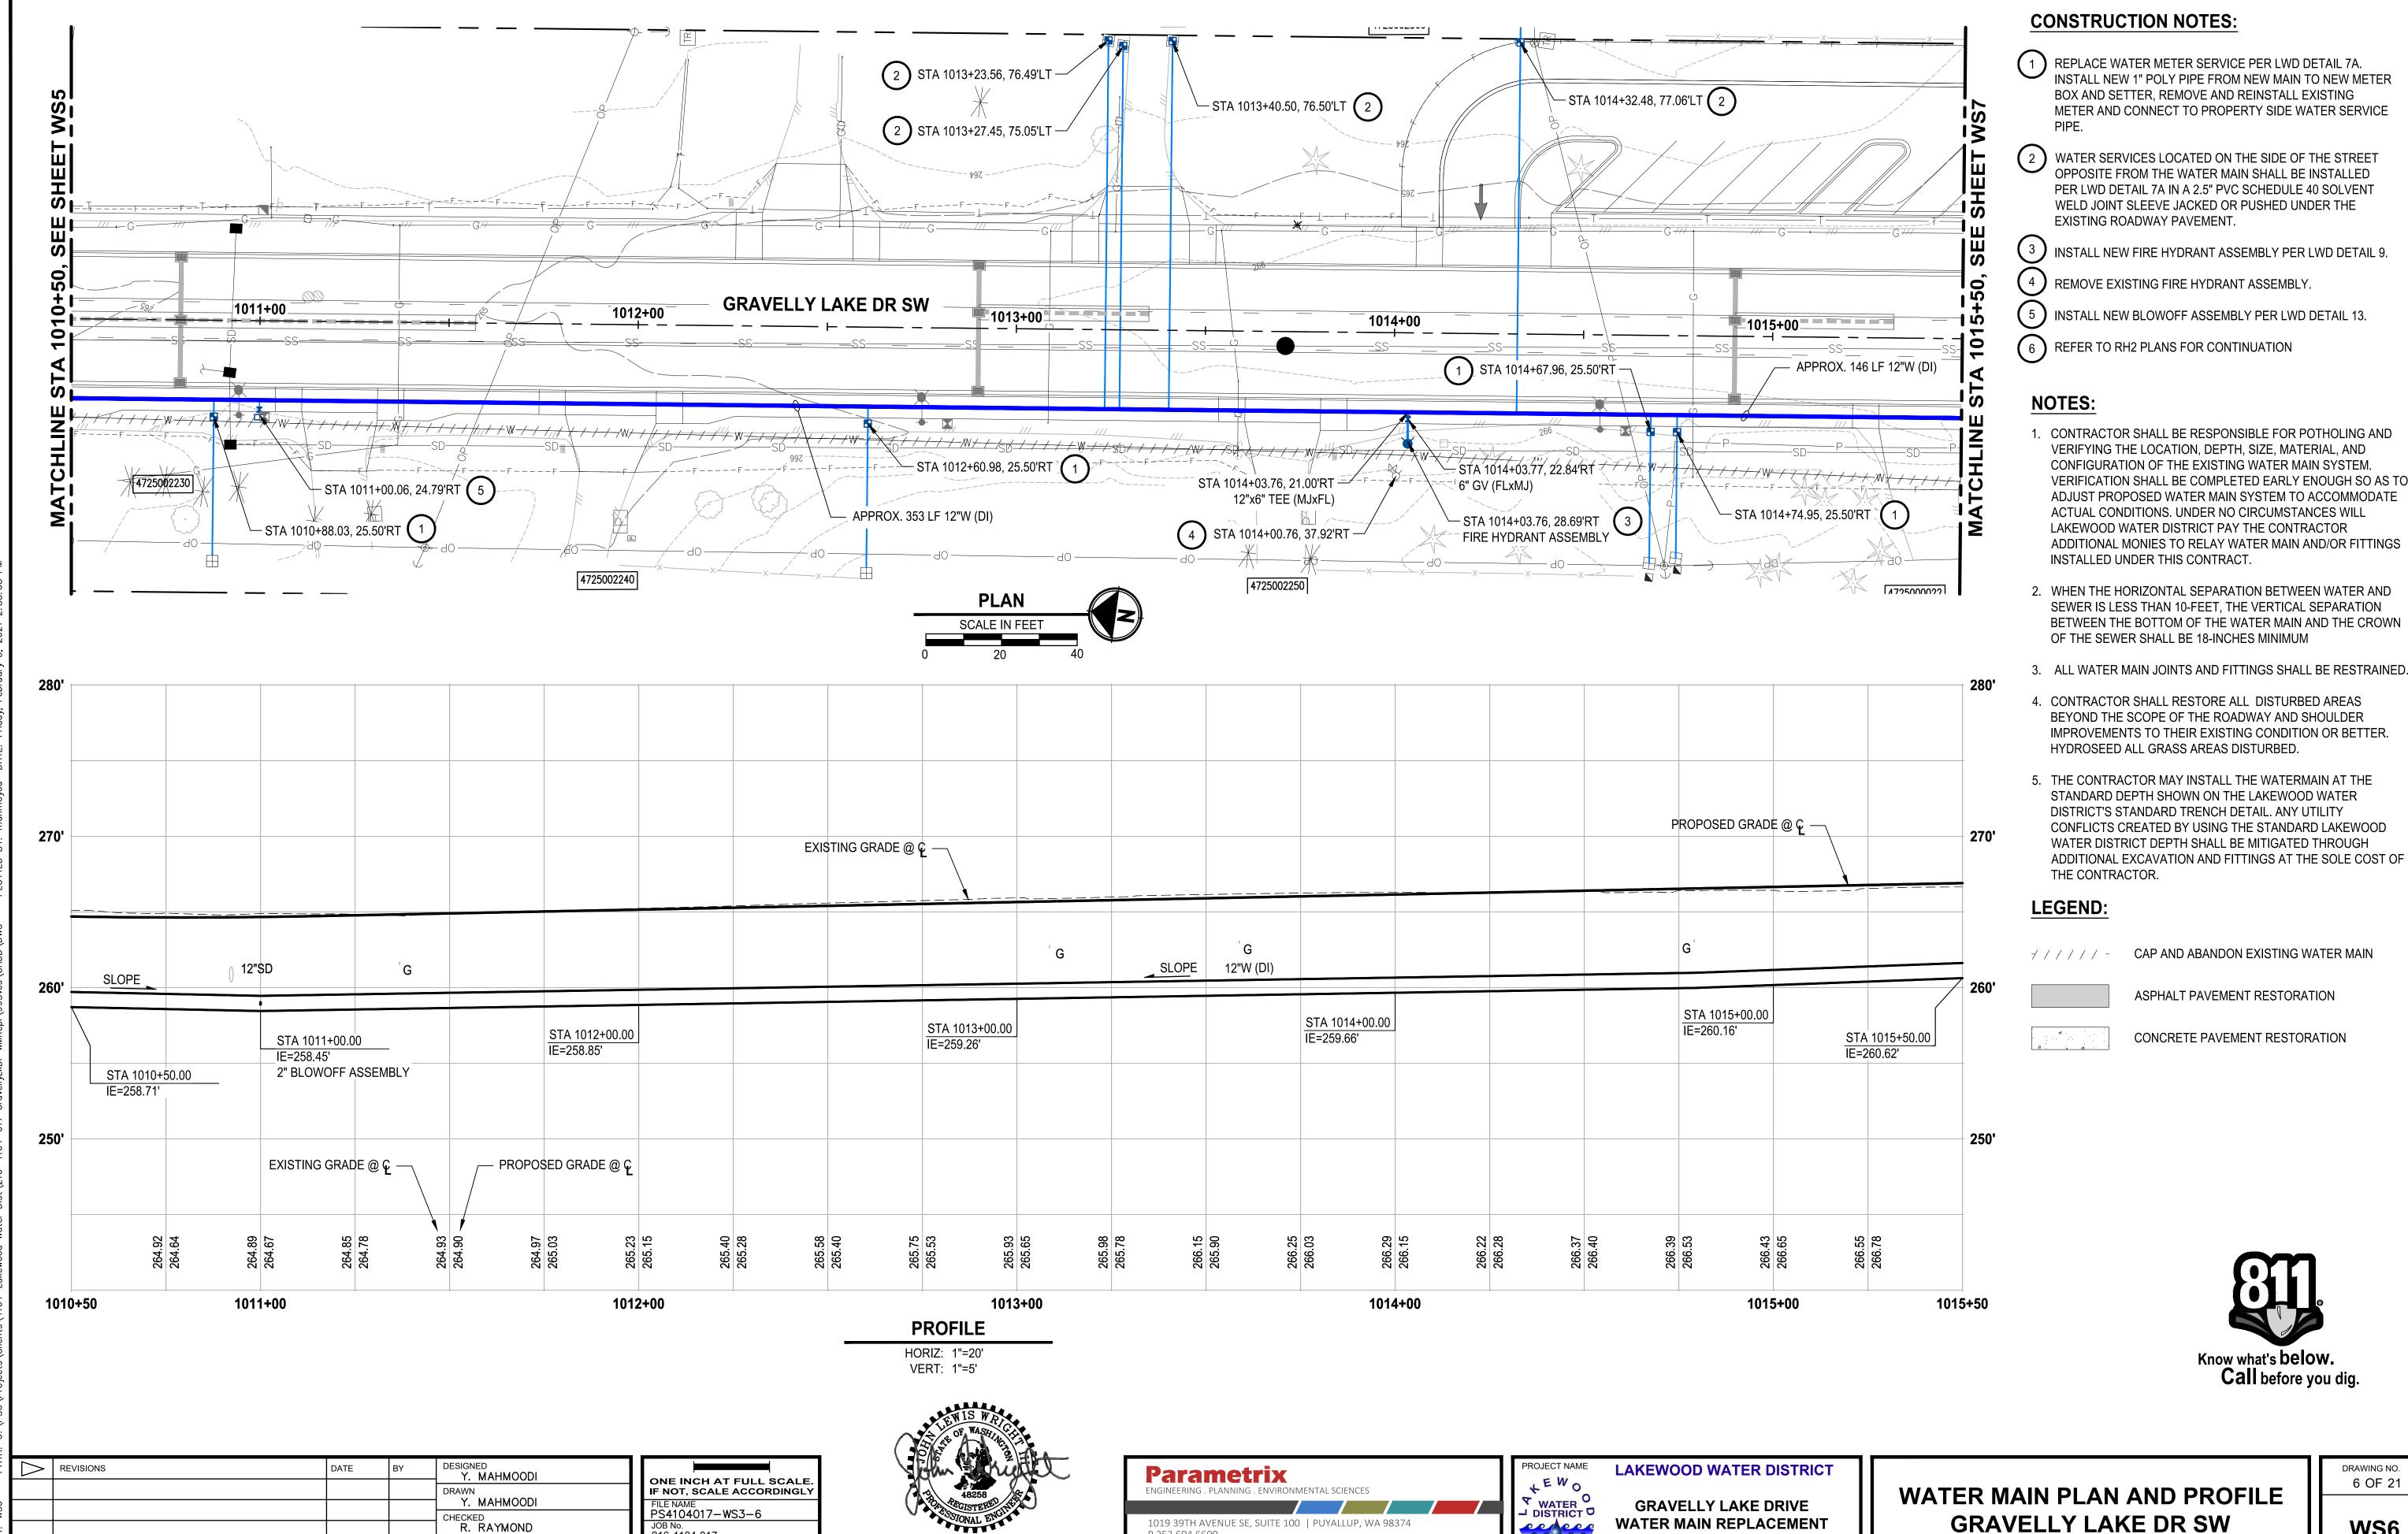
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FEBRUARY 05, 2021

JOB No. 216-4104-017


DATE FEBRUARY 2021

R. RAYMOND

J. WRIGHT

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DRAWING NO. 6 OF 21

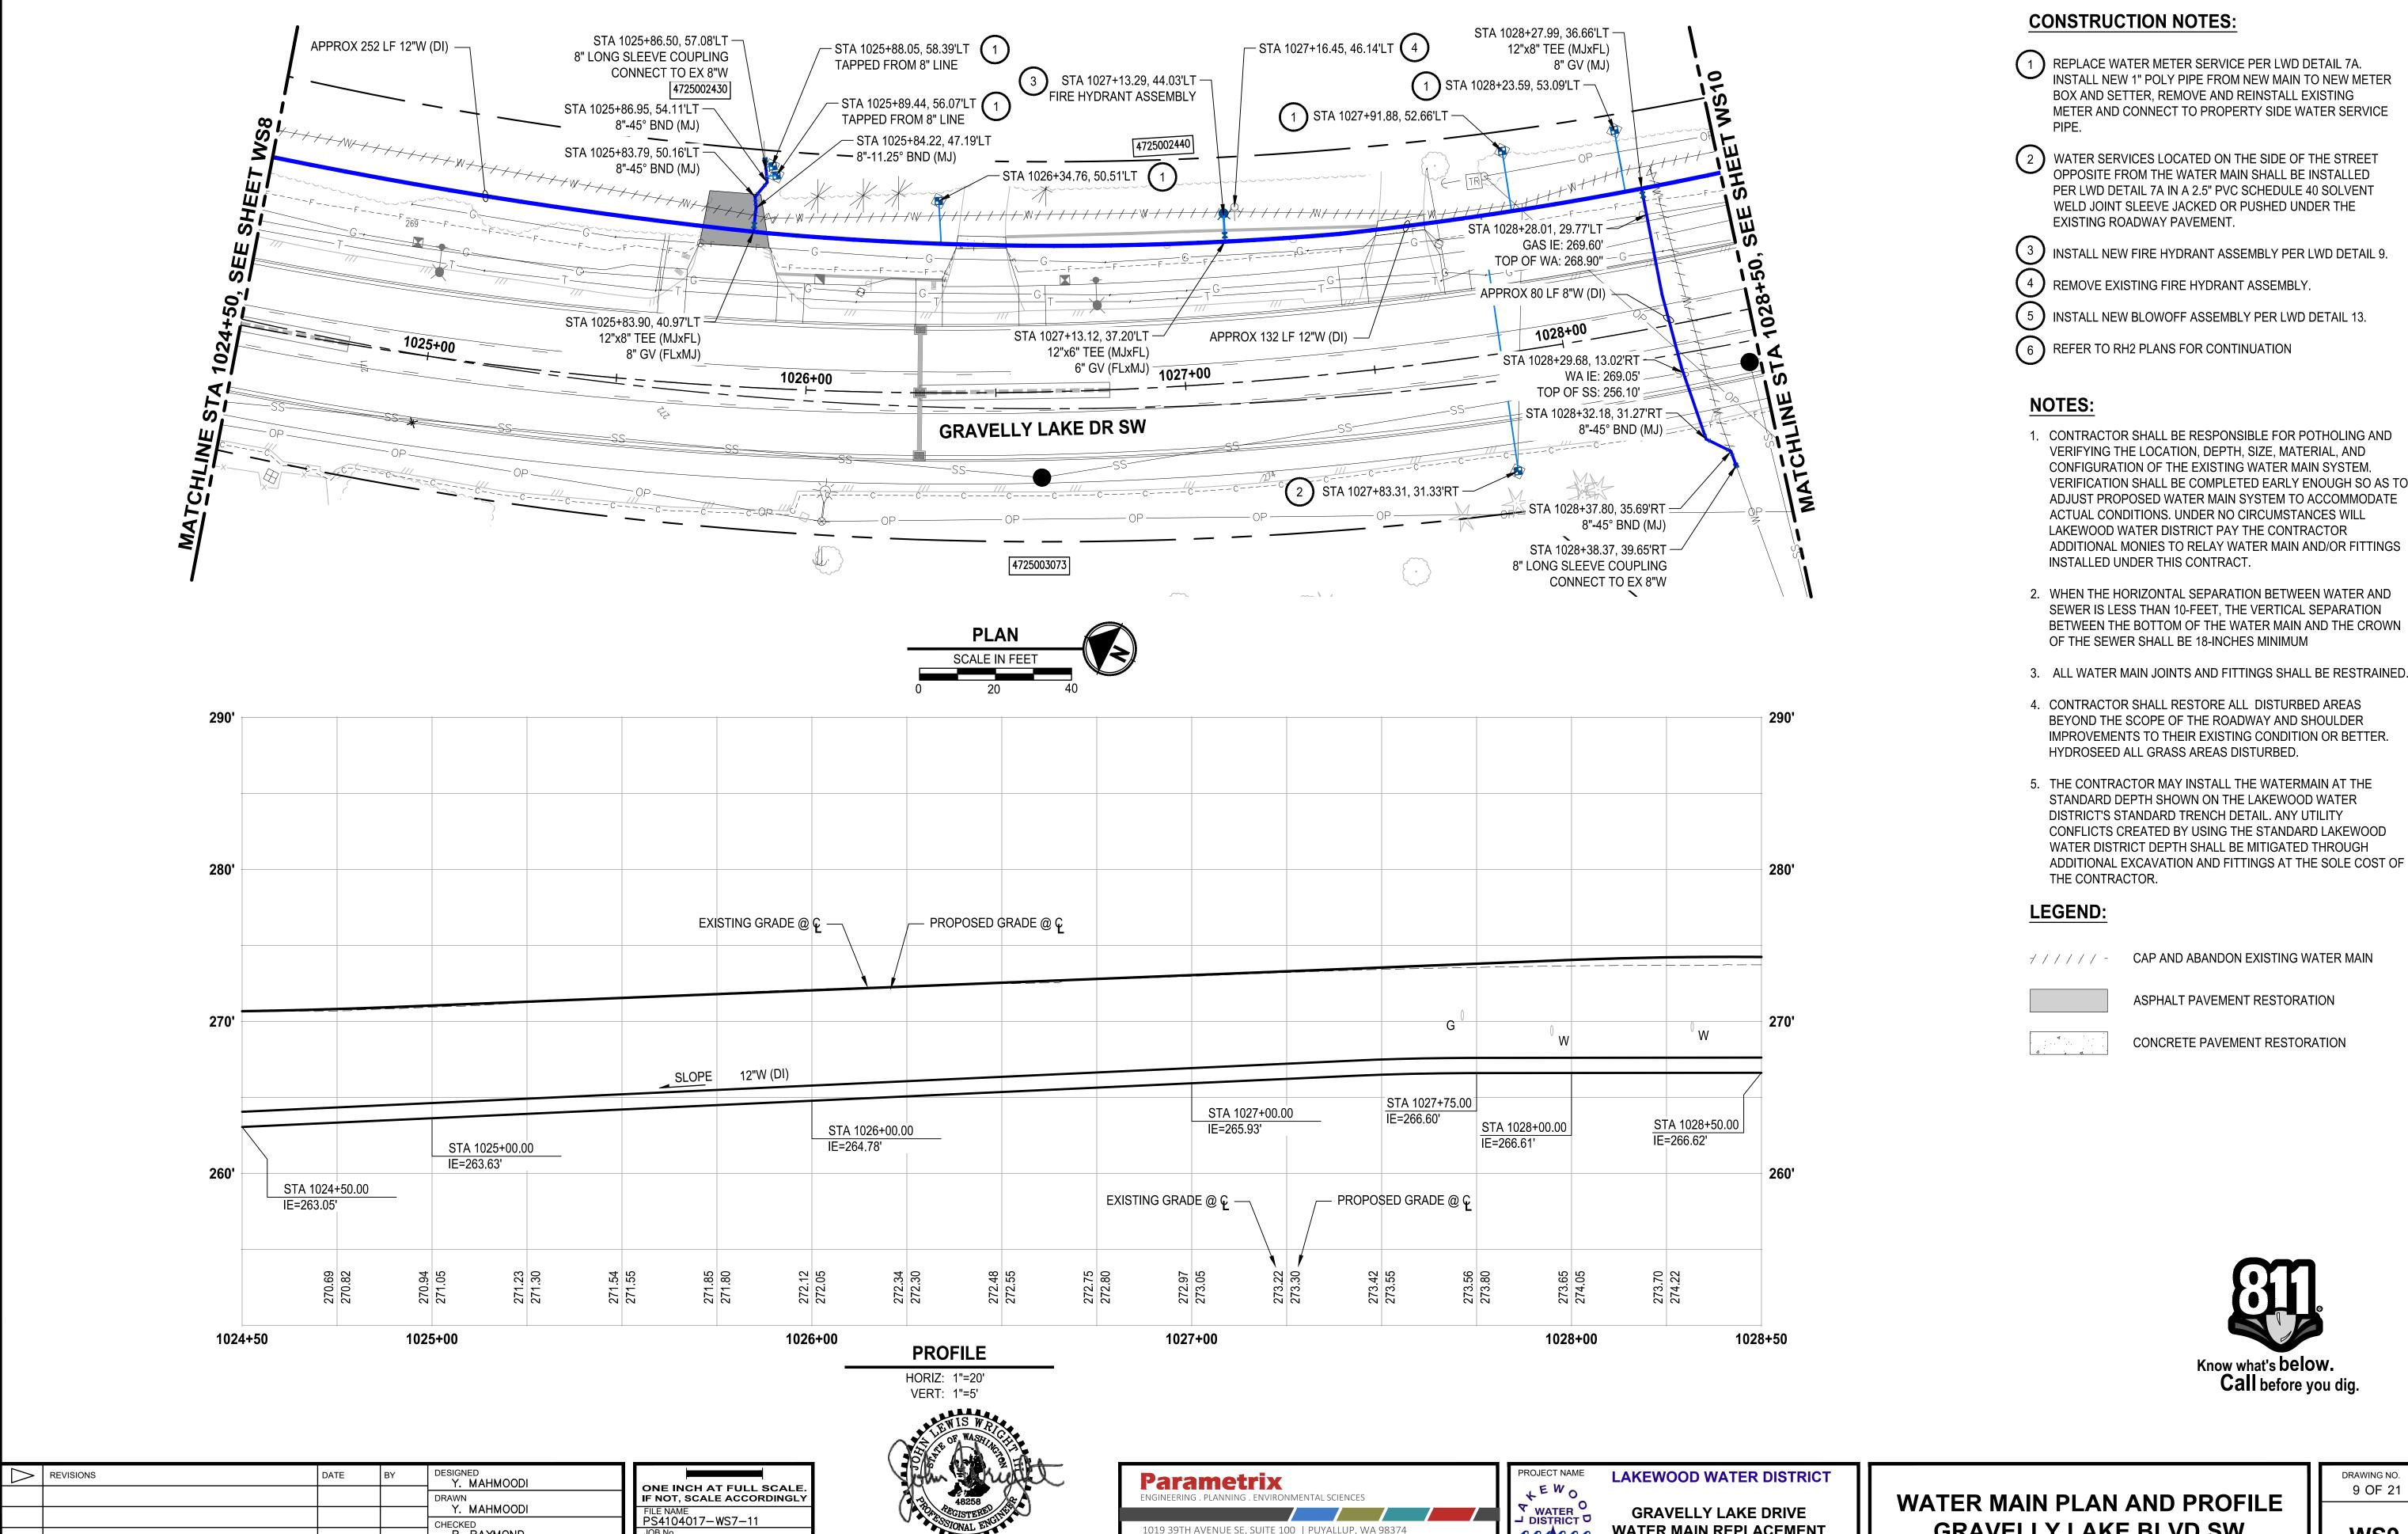

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FEBRUARY 05, 2021

R. RAYMOND

J. WRIGHT

APPROVED

JOB No. 216-4104-017

DATE FEBRUARY 2021

- 1. CONTRACTOR SHALL BE RESPONSIBLE FOR POTHOLING AND VERIFICATION SHALL BE COMPLETED EARLY ENOUGH SO AS TO ADJUST PROPOSED WATER MAIN SYSTEM TO ACCOMMODATE ADDITIONAL MONIES TO RELAY WATER MAIN AND/OR FITTINGS
- BETWEEN THE BOTTOM OF THE WATER MAIN AND THE CROWN


- ADDITIONAL EXCAVATION AND FITTINGS AT THE SOLE COST OF

**GRAVELLY LAKE BLVD SW** 

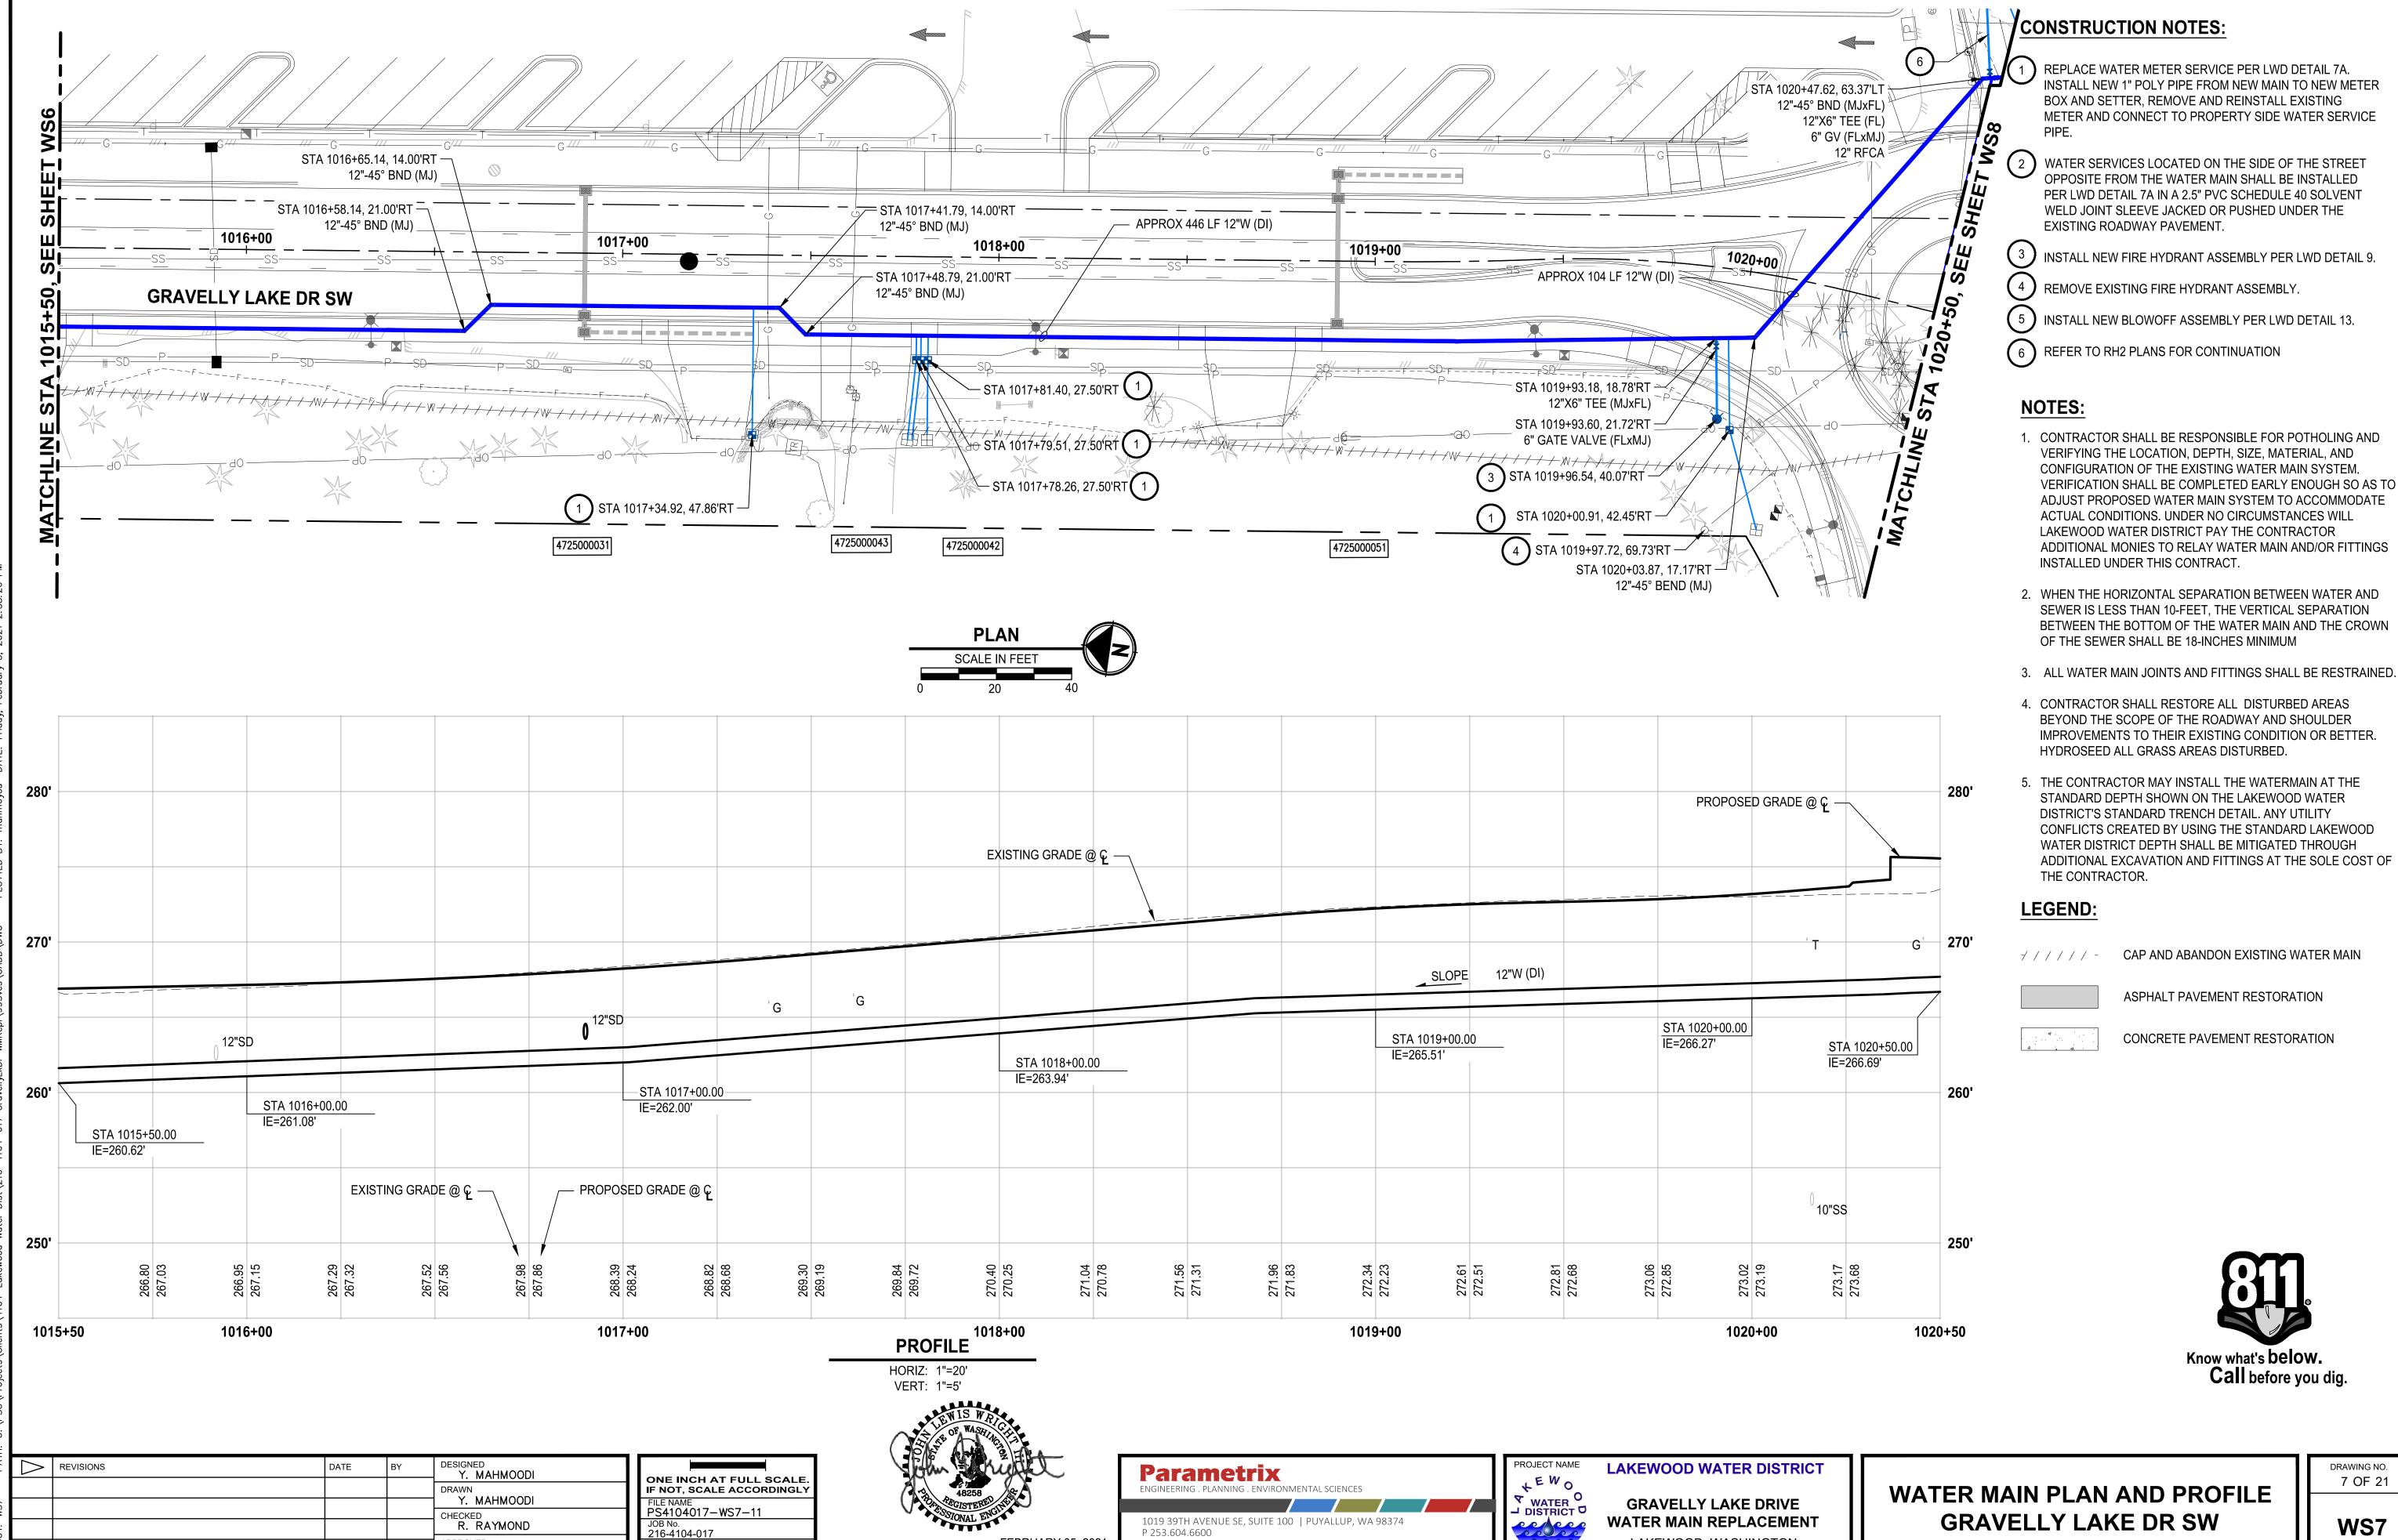**WATER MAIN REPLACEMENT** 

LAKEWOOD, WASHINGTON

DRAWING NO. 9 OF 21



P 253.604.6600

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FEBRUARY 05, 2021

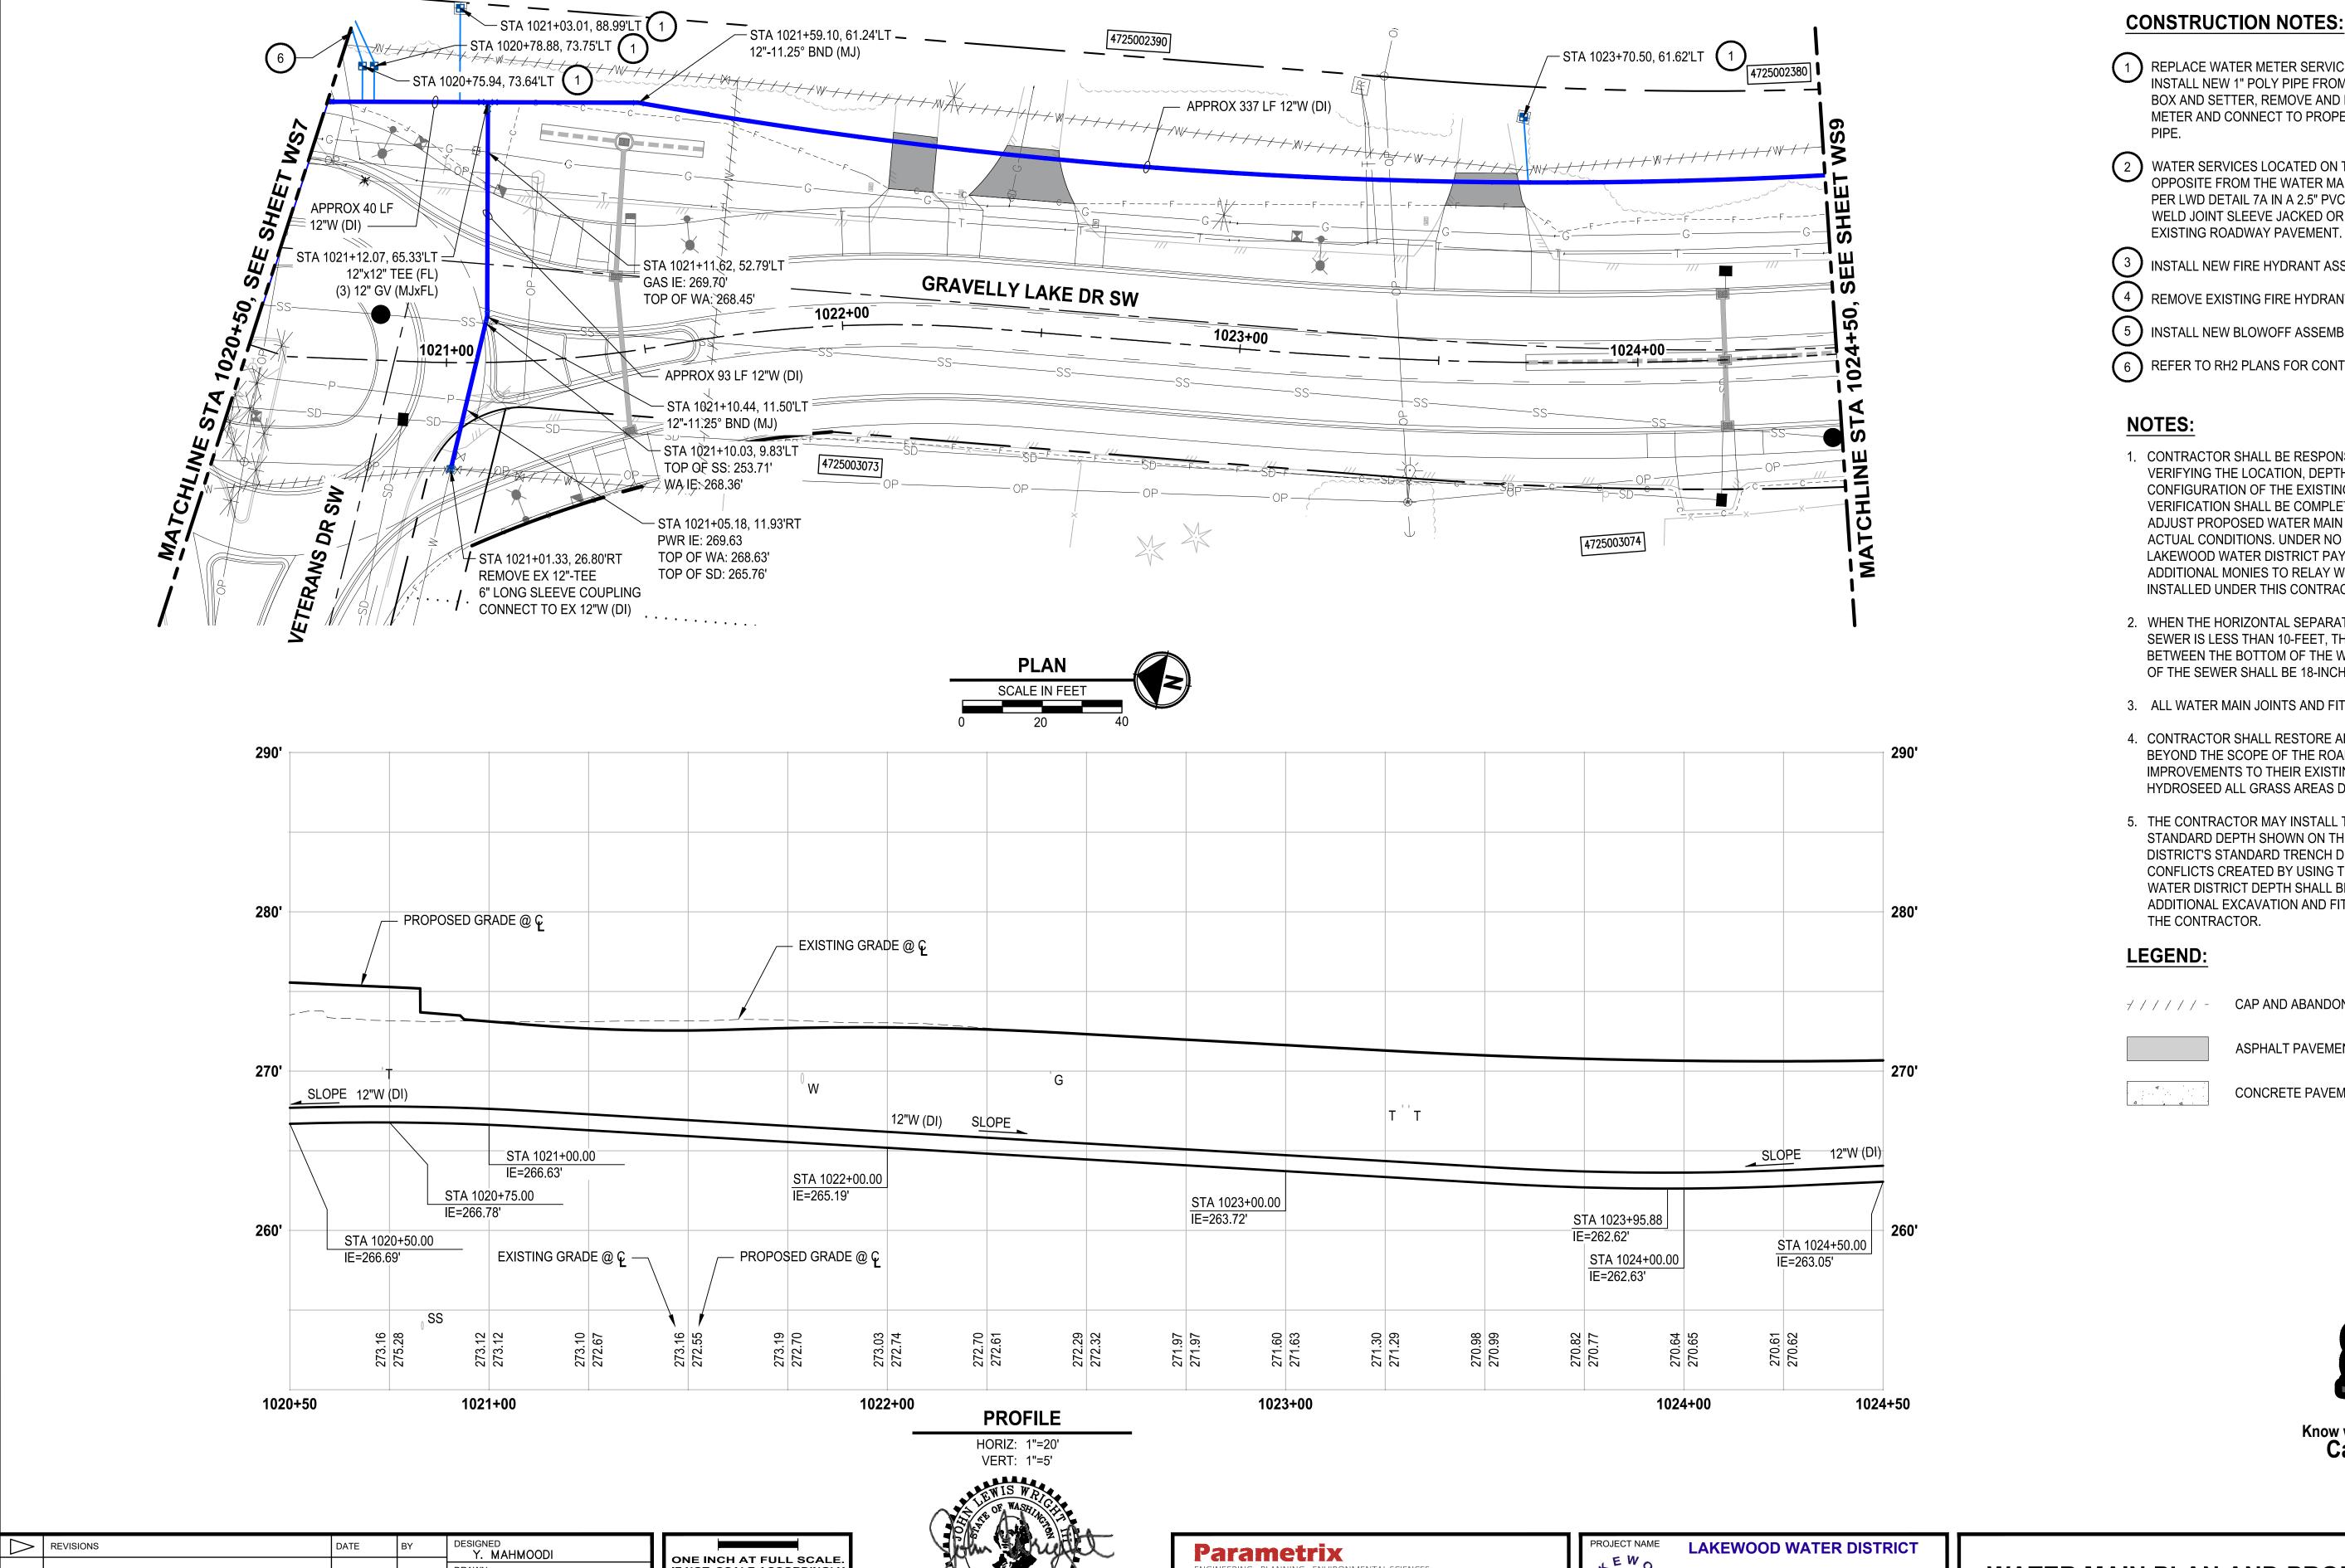
APPROVED

J. WRIGHT

DATE FEBRUARY 2021

LAKEWOOD, WASHINGTON

DRAWING NO. 7 OF 21



**CONSTRUCTION NOTES:** 

(1) REPLACE WATER METER SERVICE PER LWD DETAIL 7A. INSTALL NEW 1" POLY PIPE FROM NEW MAIN TO NEW METER BOX AND SETTER, REMOVE AND REINSTALL EXISTING METER AND CONNECT TO PROPERTY SIDE WATER SERVICE

2 WATER SERVICES LOCATED ON THE SIDE OF THE STREET OPPOSITE FROM THE WATER MAIN SHALL BE INSTALLED PER LWD DETAIL 7A IN A 2.5" PVC SCHEDULE 40 SOLVENT WELD JOINT SLEEVE JACKED OR PUSHED UNDER THE

(3) INSTALL NEW FIRE HYDRANT ASSEMBLY PER LWD DETAIL 9.

(4) REMOVE EXISTING FIRE HYDRANT ASSEMBLY.

( 5 ) INSTALL NEW BLOWOFF ASSEMBLY PER LWD DETAIL 13.

6 REFER TO RH2 PLANS FOR CONTINUATION

- 1. CONTRACTOR SHALL BE RESPONSIBLE FOR POTHOLING AND VERIFYING THE LOCATION, DEPTH, SIZE, MATERIAL, AND CONFIGURATION OF THE EXISTING WATER MAIN SYSTEM. VERIFICATION SHALL BE COMPLETED EARLY ENOUGH SO AS TO ADJUST PROPOSED WATER MAIN SYSTEM TO ACCOMMODATE ACTUAL CONDITIONS. UNDER NO CIRCUMSTANCES WILL LAKEWOOD WATER DISTRICT PAY THE CONTRACTOR ADDITIONAL MONIES TO RELAY WATER MAIN AND/OR FITTINGS INSTALLED UNDER THIS CONTRACT.
- 2. WHEN THE HORIZONTAL SEPARATION BETWEEN WATER AND SEWER IS LESS THAN 10-FEET, THE VERTICAL SEPARATION BETWEEN THE BOTTOM OF THE WATER MAIN AND THE CROWN OF THE SEWER SHALL BE 18-INCHES MINIMUM
- 3. ALL WATER MAIN JOINTS AND FITTINGS SHALL BE RESTRAINED.
- 4. CONTRACTOR SHALL RESTORE ALL DISTURBED AREAS BEYOND THE SCOPE OF THE ROADWAY AND SHOULDER IMPROVEMENTS TO THEIR EXISTING CONDITION OR BETTER. HYDROSEED ALL GRASS AREAS DISTURBED.
- 5. THE CONTRACTOR MAY INSTALL THE WATERMAIN AT THE STANDARD DEPTH SHOWN ON THE LAKEWOOD WATER DISTRICT'S STANDARD TRENCH DETAIL. ANY UTILITY CONFLICTS CREATED BY USING THE STANDARD LAKEWOOD WATER DISTRICT DEPTH SHALL BE MITIGATED THROUGH ADDITIONAL EXCAVATION AND FITTINGS AT THE SOLE COST OF

CAP AND ABANDON EXISTING WATER MAIN

ASPHALT PAVEMENT RESTORATION

CONCRETE PAVEMENT RESTORATION

Know what's below.

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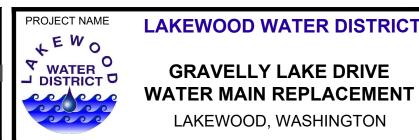
Y. MAHMOODI R. RAYMOND APPROVED

J. WRIGHT

ONE INCH AT FULL SCALE. IF NOT, SCALE ACCORDINGLY FILE NAME PS4104017-WS7-11 JOB No. 216-4104-017 DATE FEBRUARY 2021

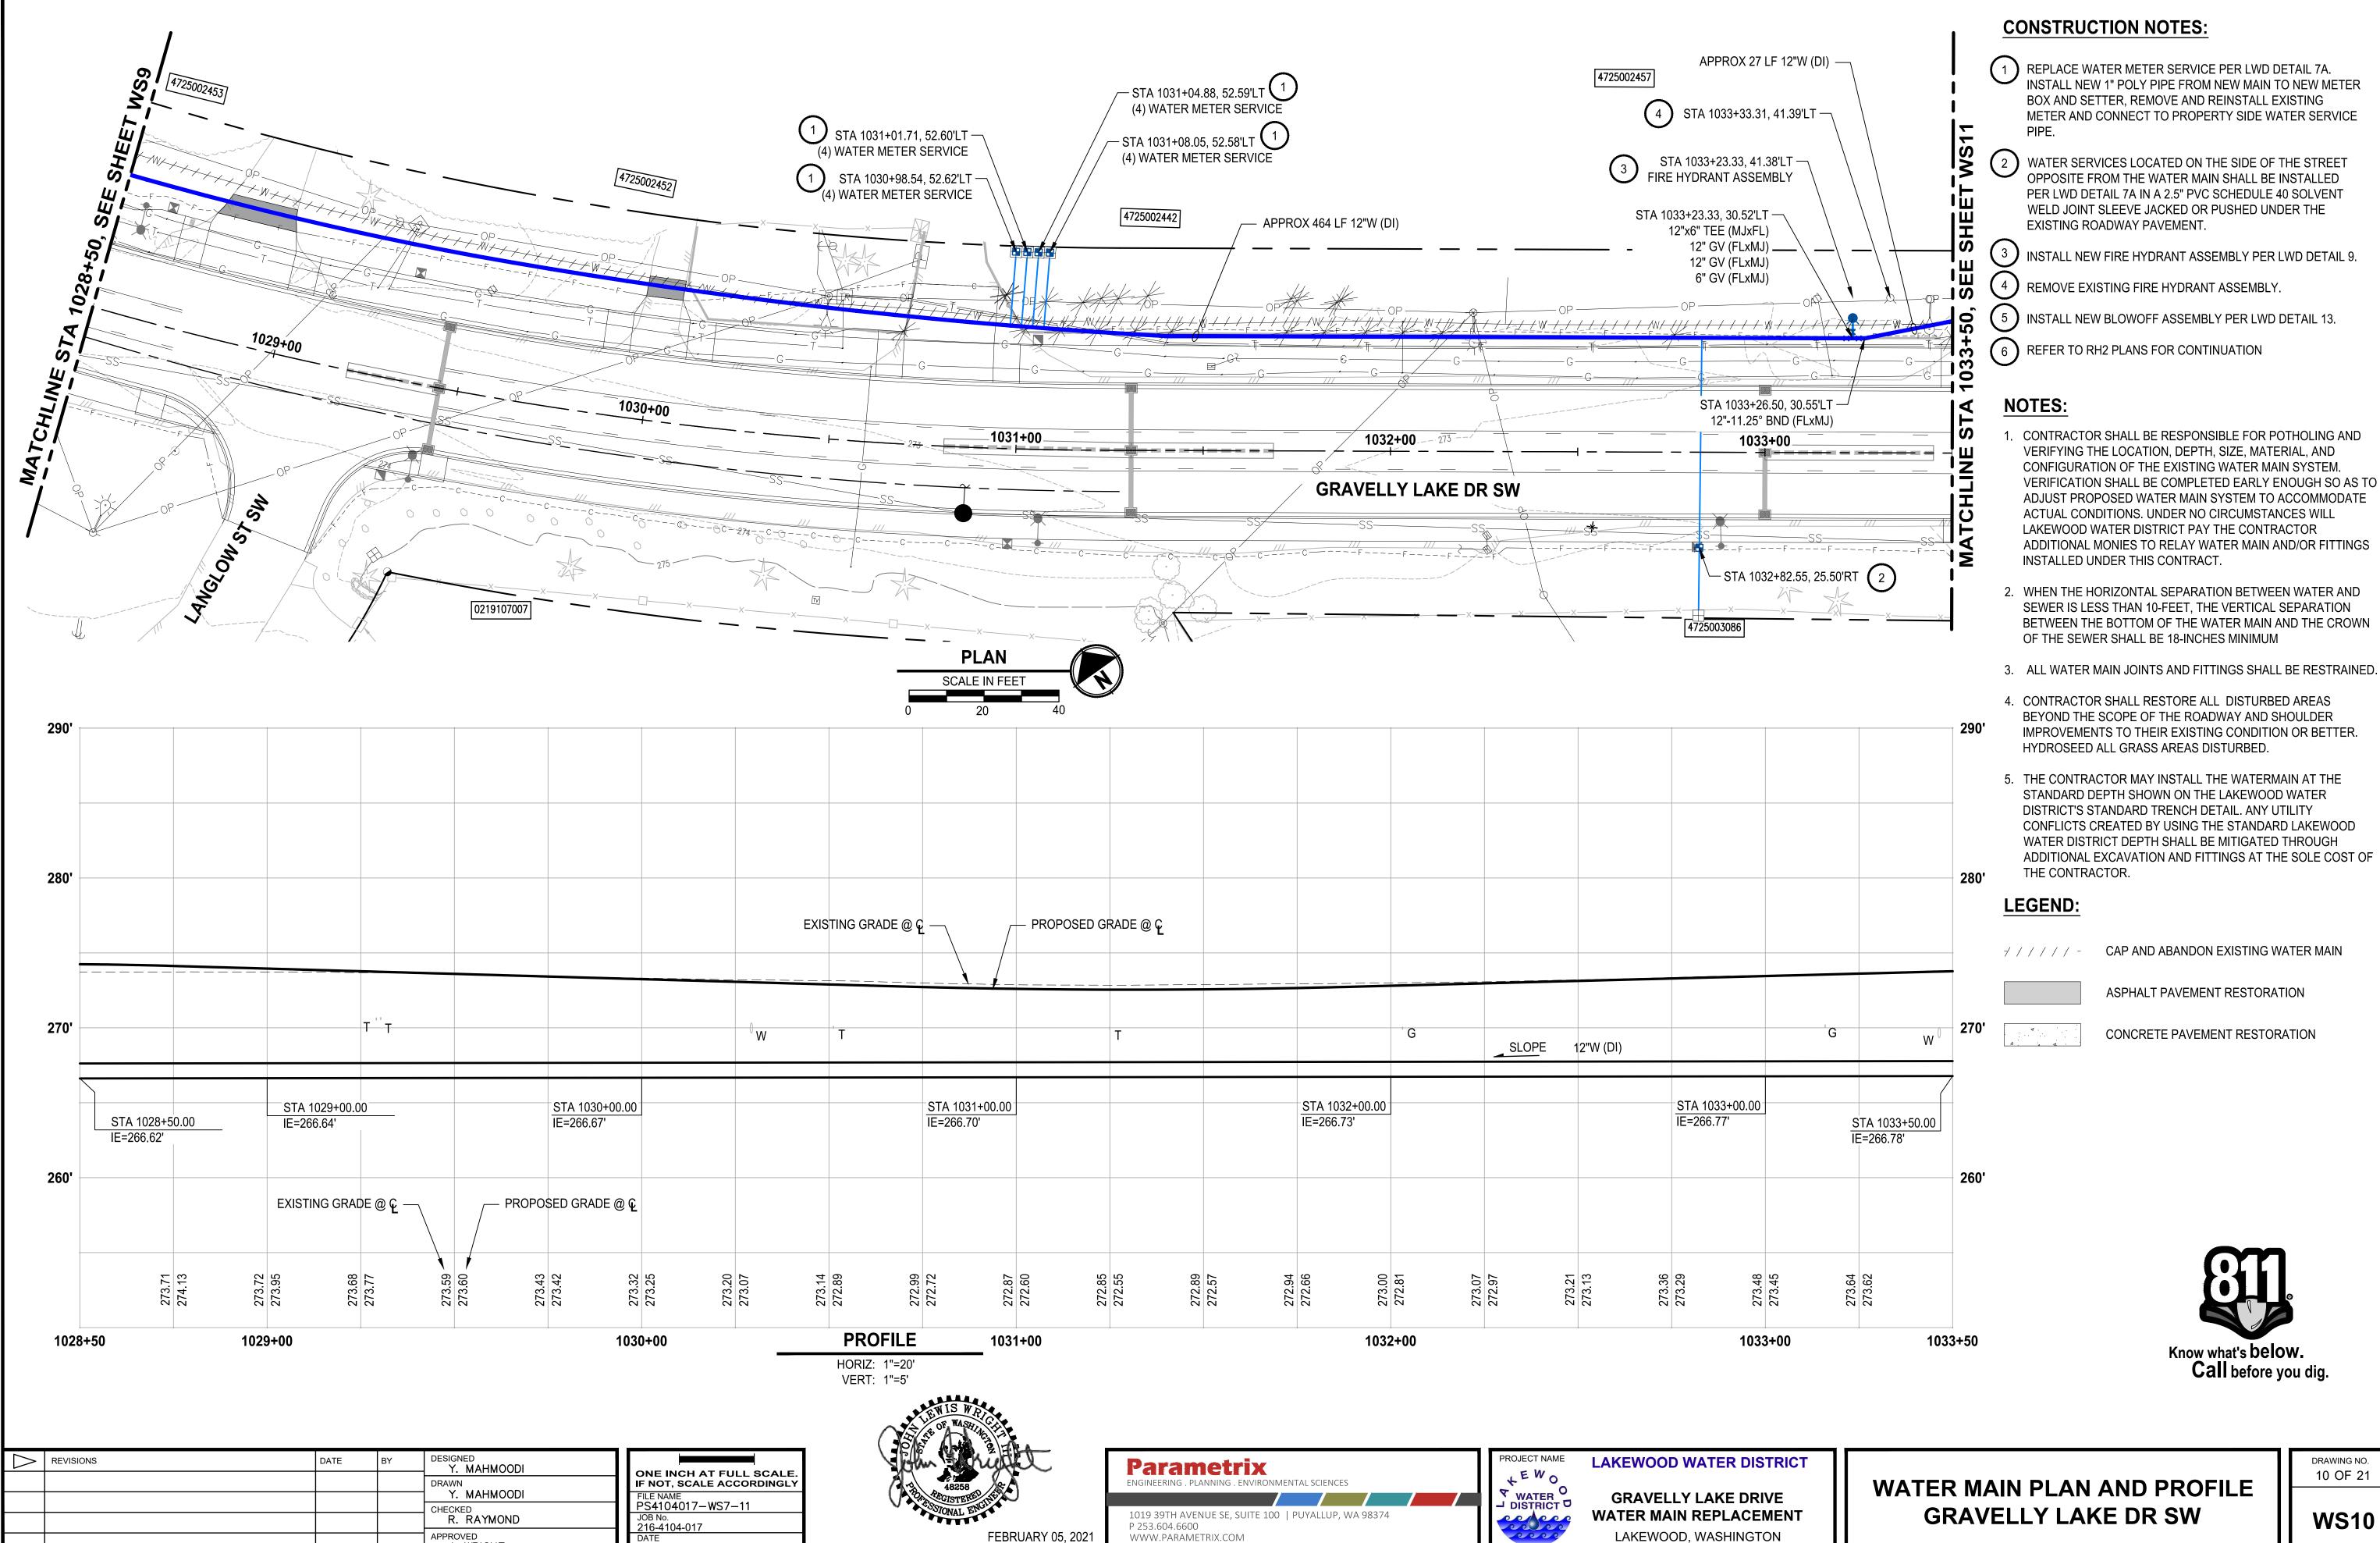







WATER MAIN PLAN AND PROFILE **GRAVELLY BLVD SW** 

DRAWING NO. 8 OF 21




DATE FEBRUARY 2021

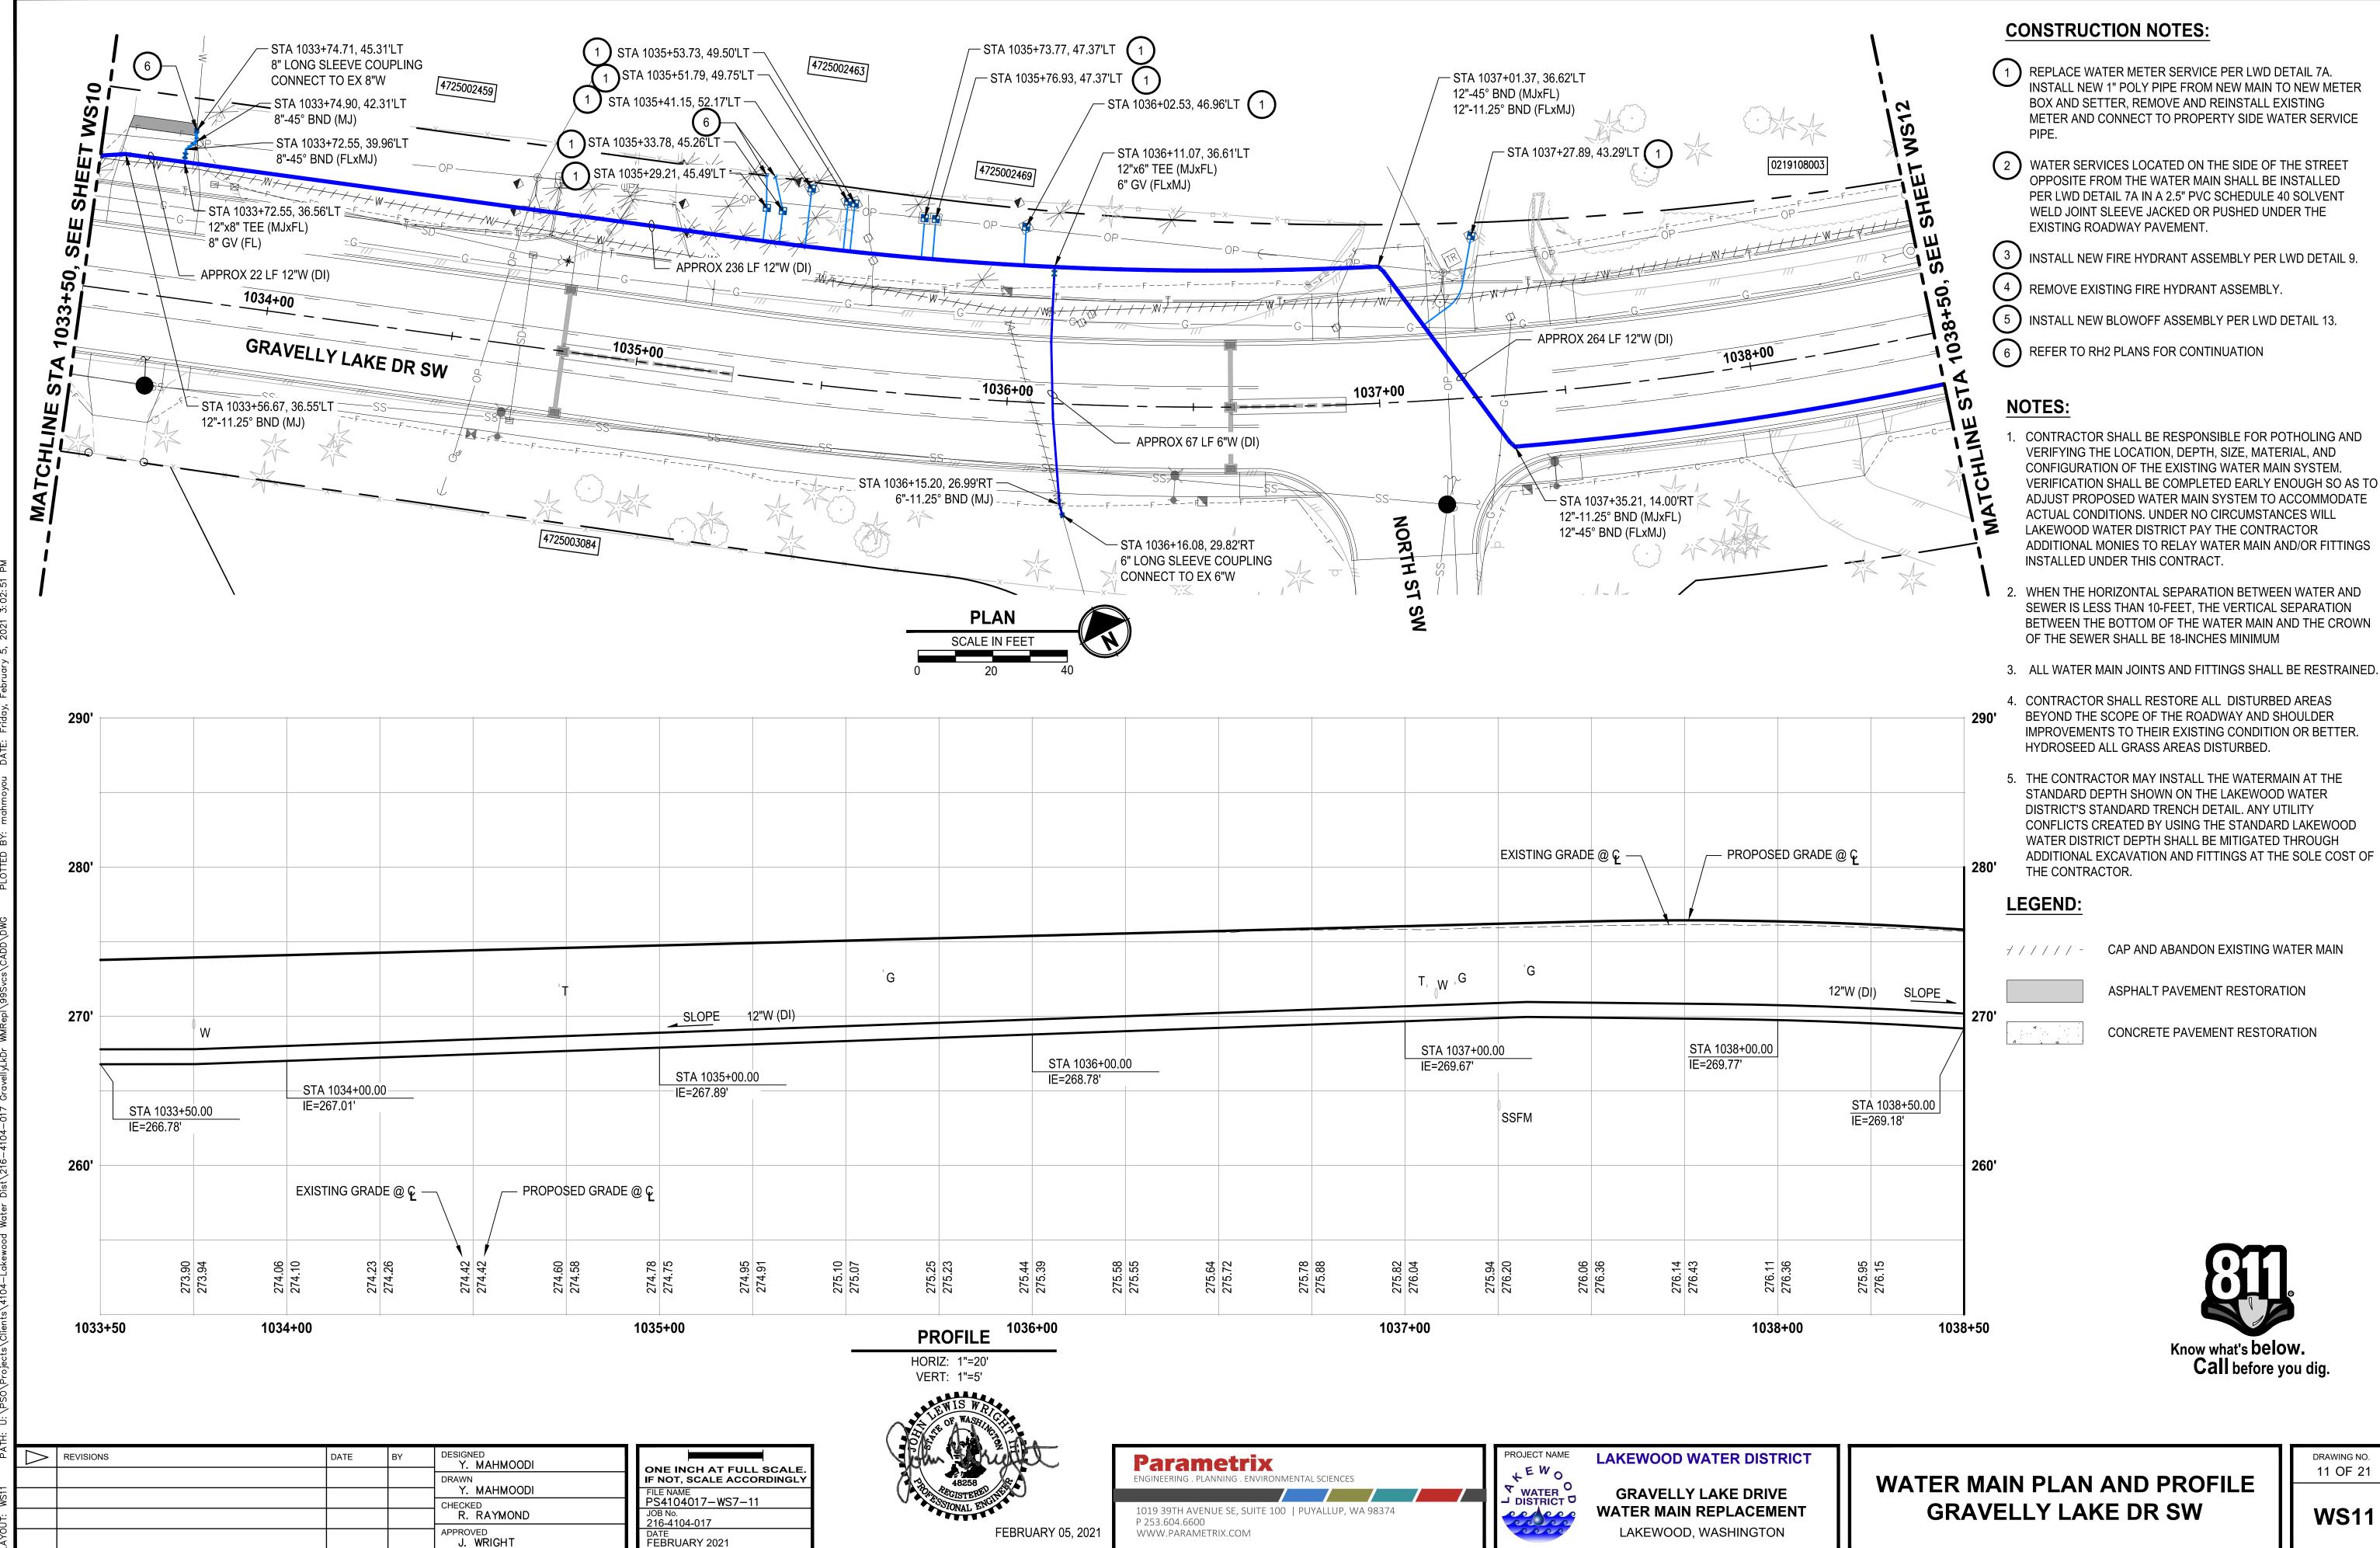J. WRIGHT



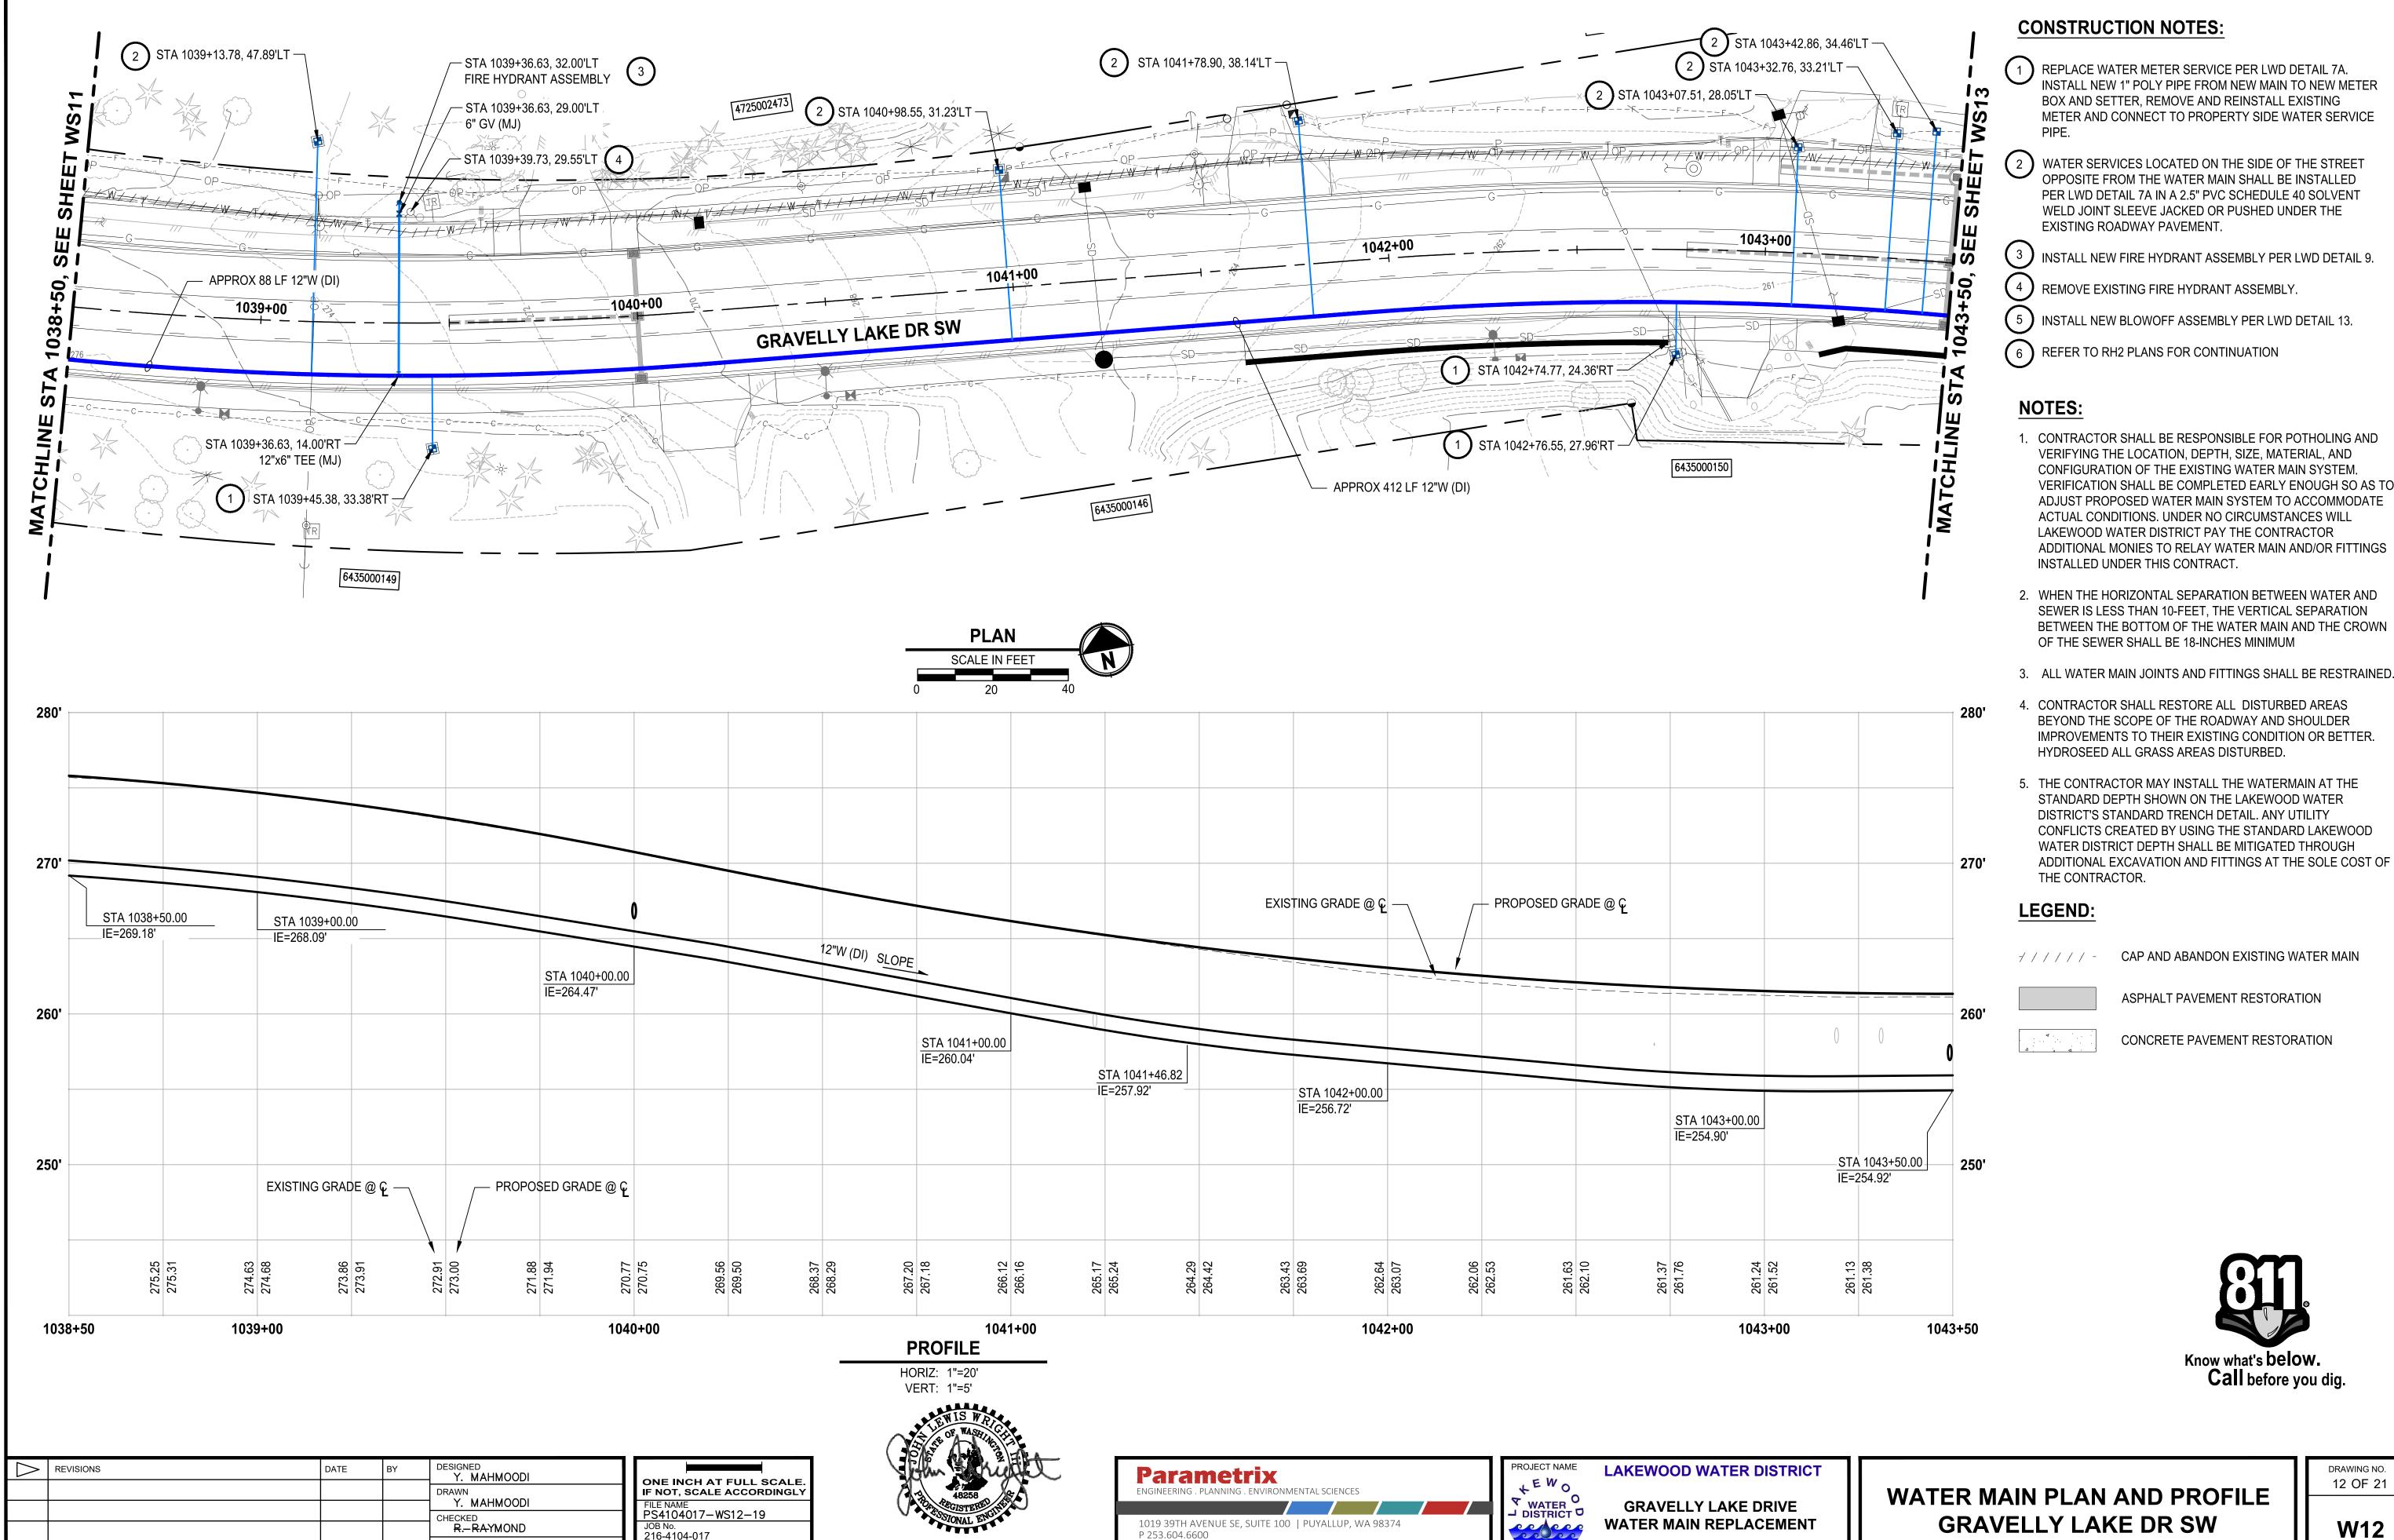J. WRIGHT



- VERIFICATION SHALL BE COMPLETED EARLY ENOUGH SO AS TO ADJUST PROPOSED WATER MAIN SYSTEM TO ACCOMMODATE ADDITIONAL MONIES TO RELAY WATER MAIN AND/OR FITTINGS
- ADDITIONAL EXCAVATION AND FITTINGS AT THE SOLE COST OF

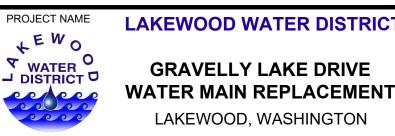
APPROVED

J.-WRIGHT

JOB No. 216-4104-017 DATE FEBRUARY 2021









**GRAVELLY LAKE DR SW** 

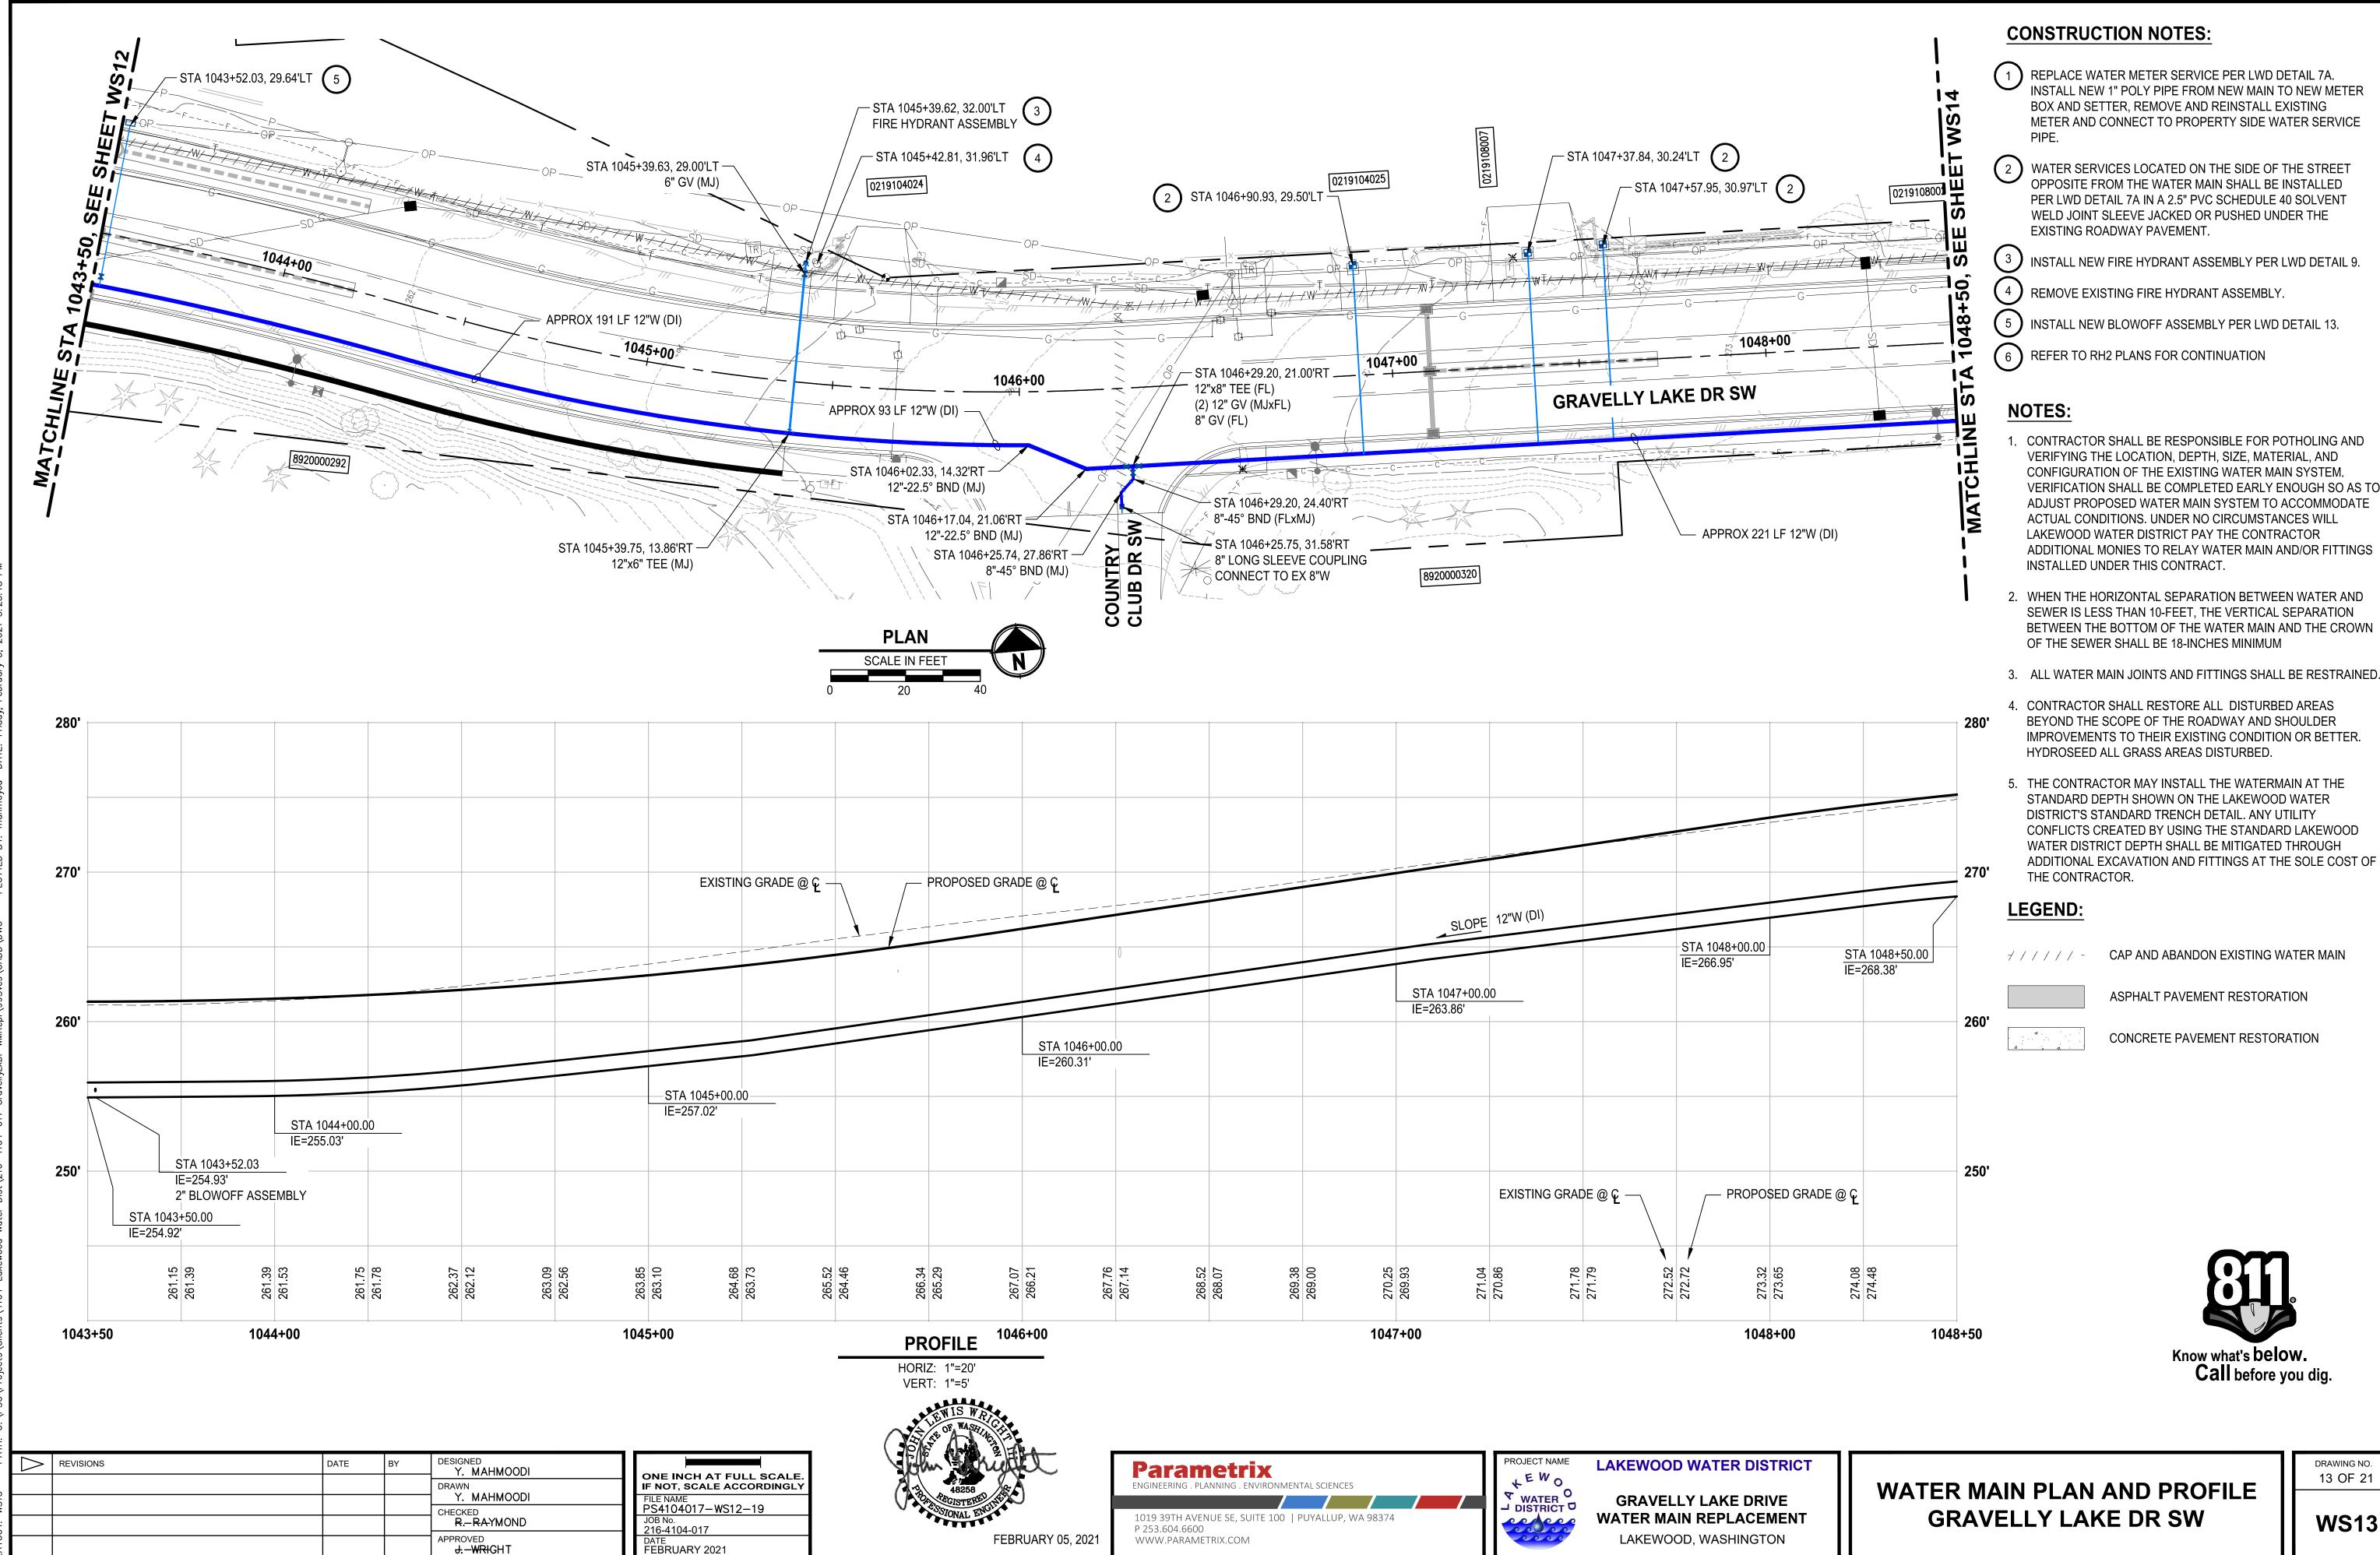DRAWING NO. 12 OF 21




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- VERIFICATION SHALL BE COMPLETED EARLY ENOUGH SO AS TO ADDITIONAL MONIES TO RELAY WATER MAIN AND/OR FITTINGS

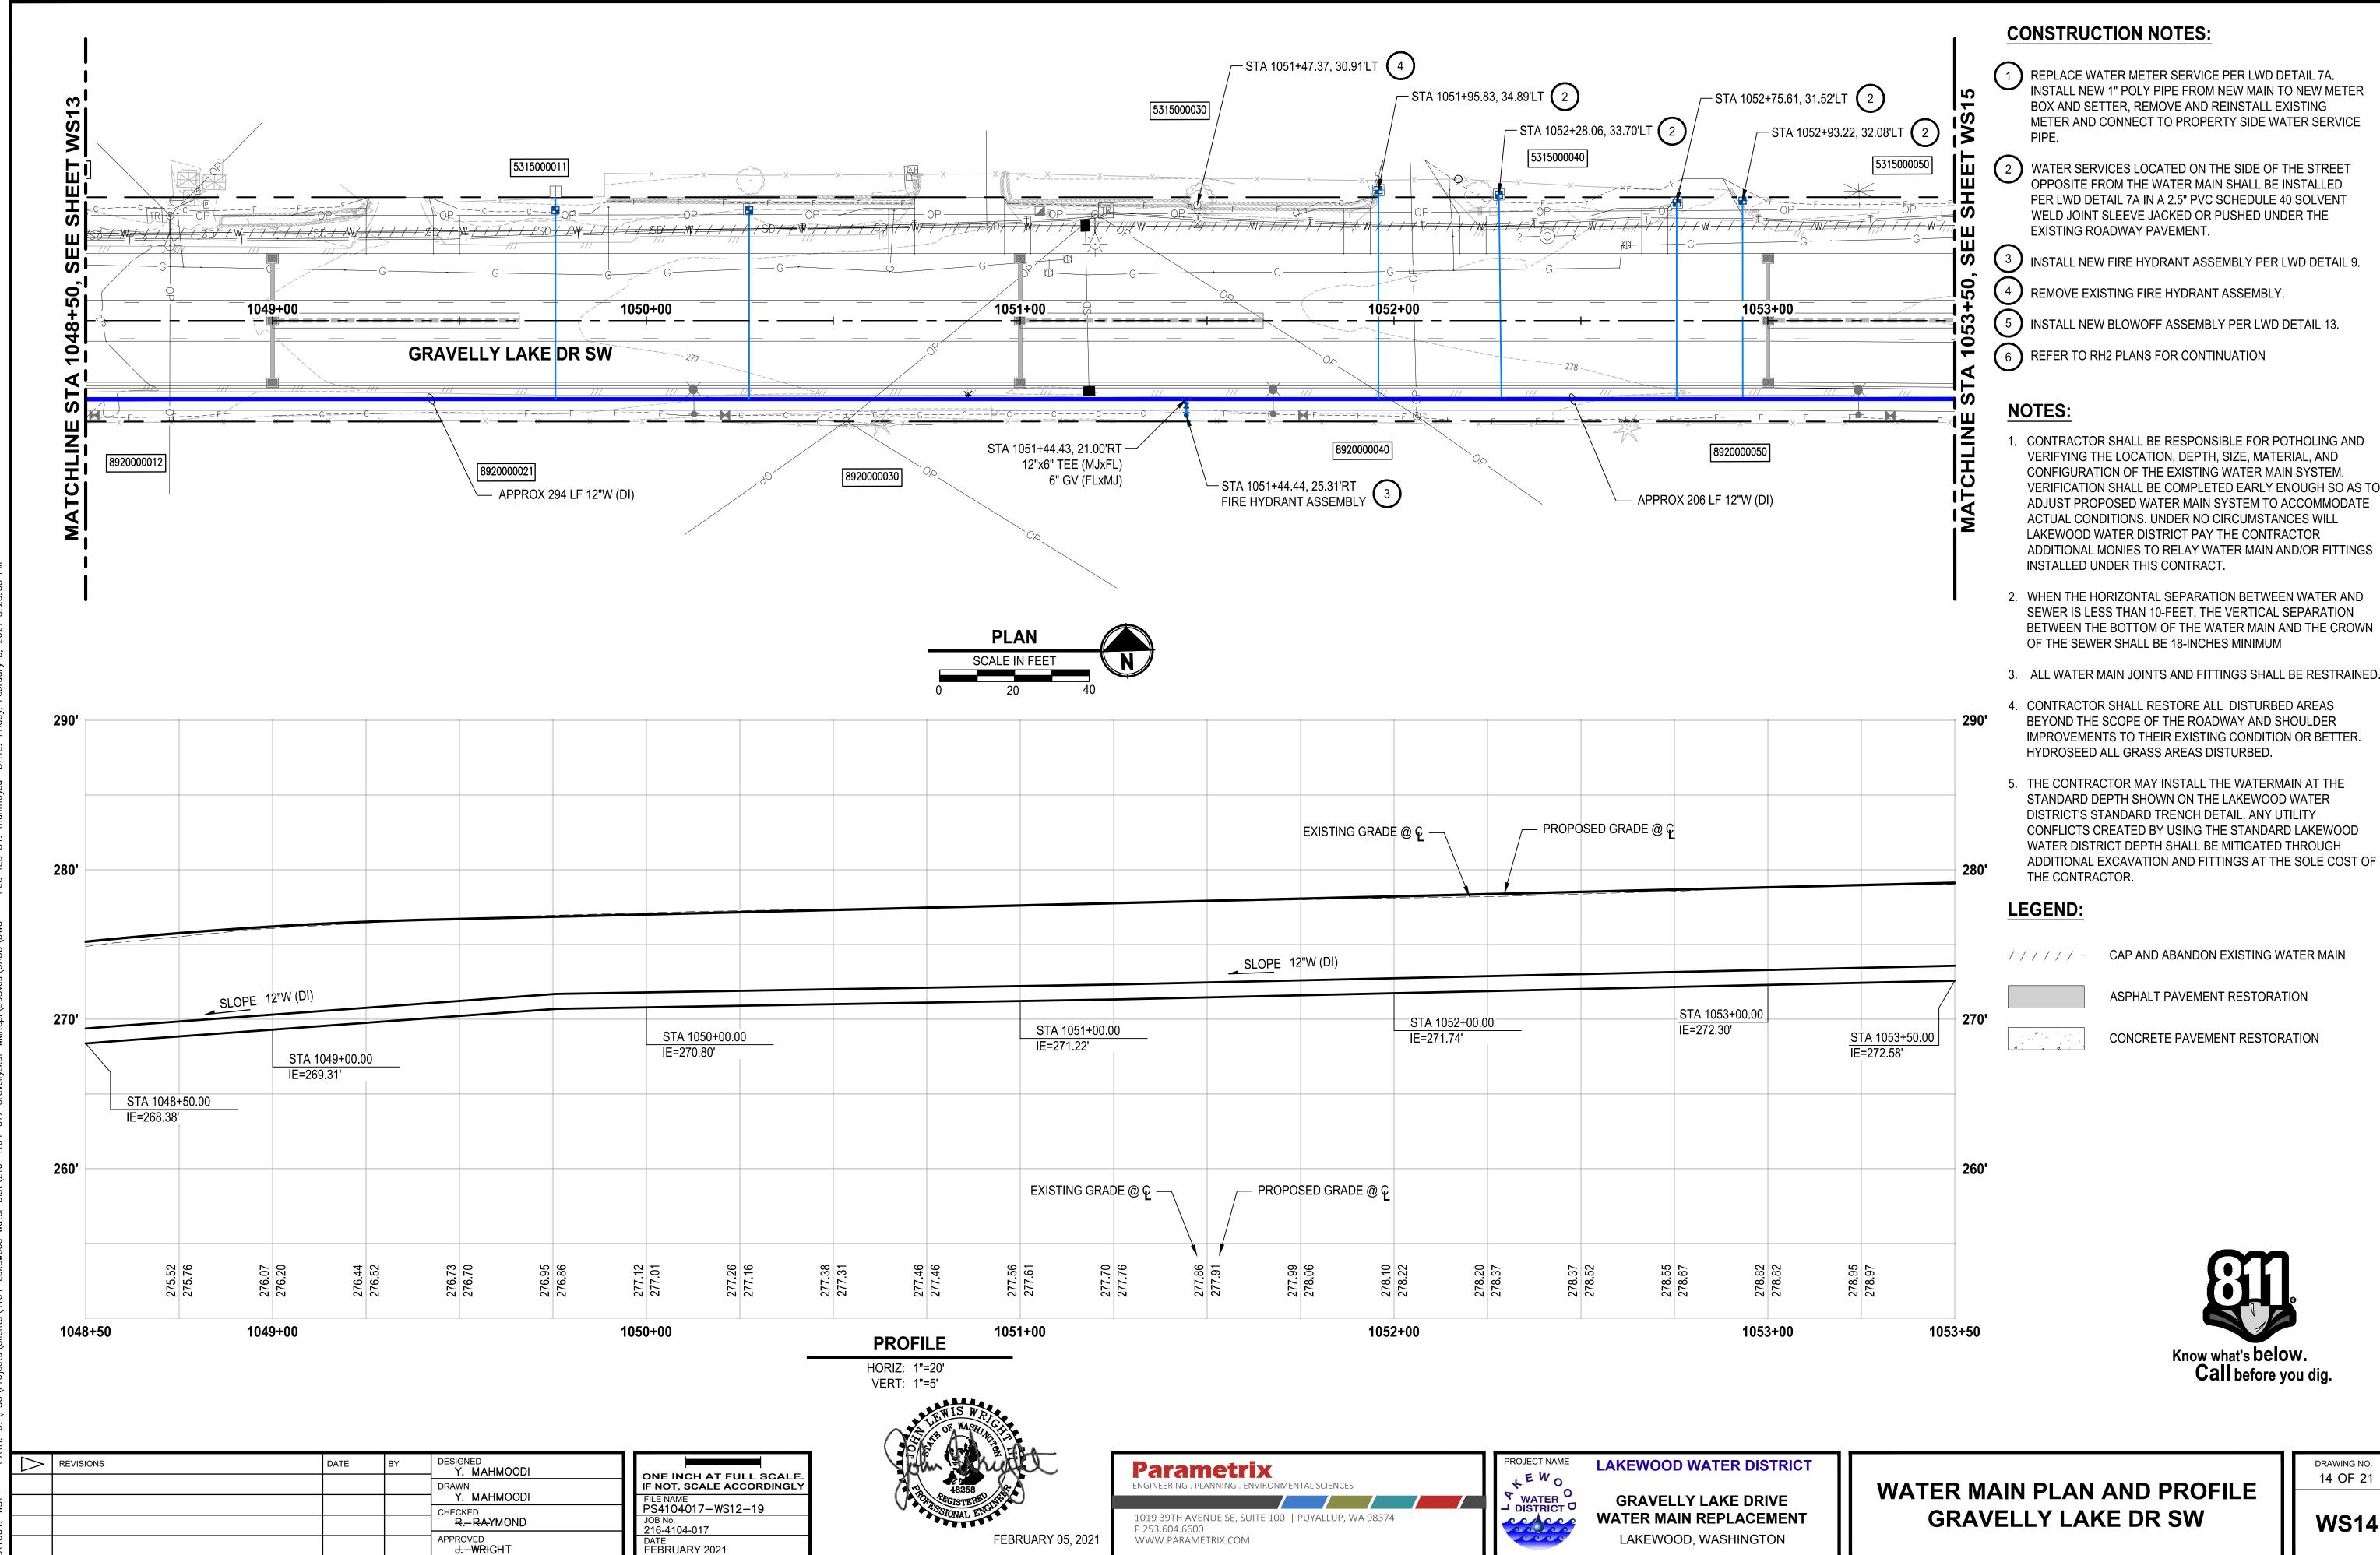

J.-WRIGHT

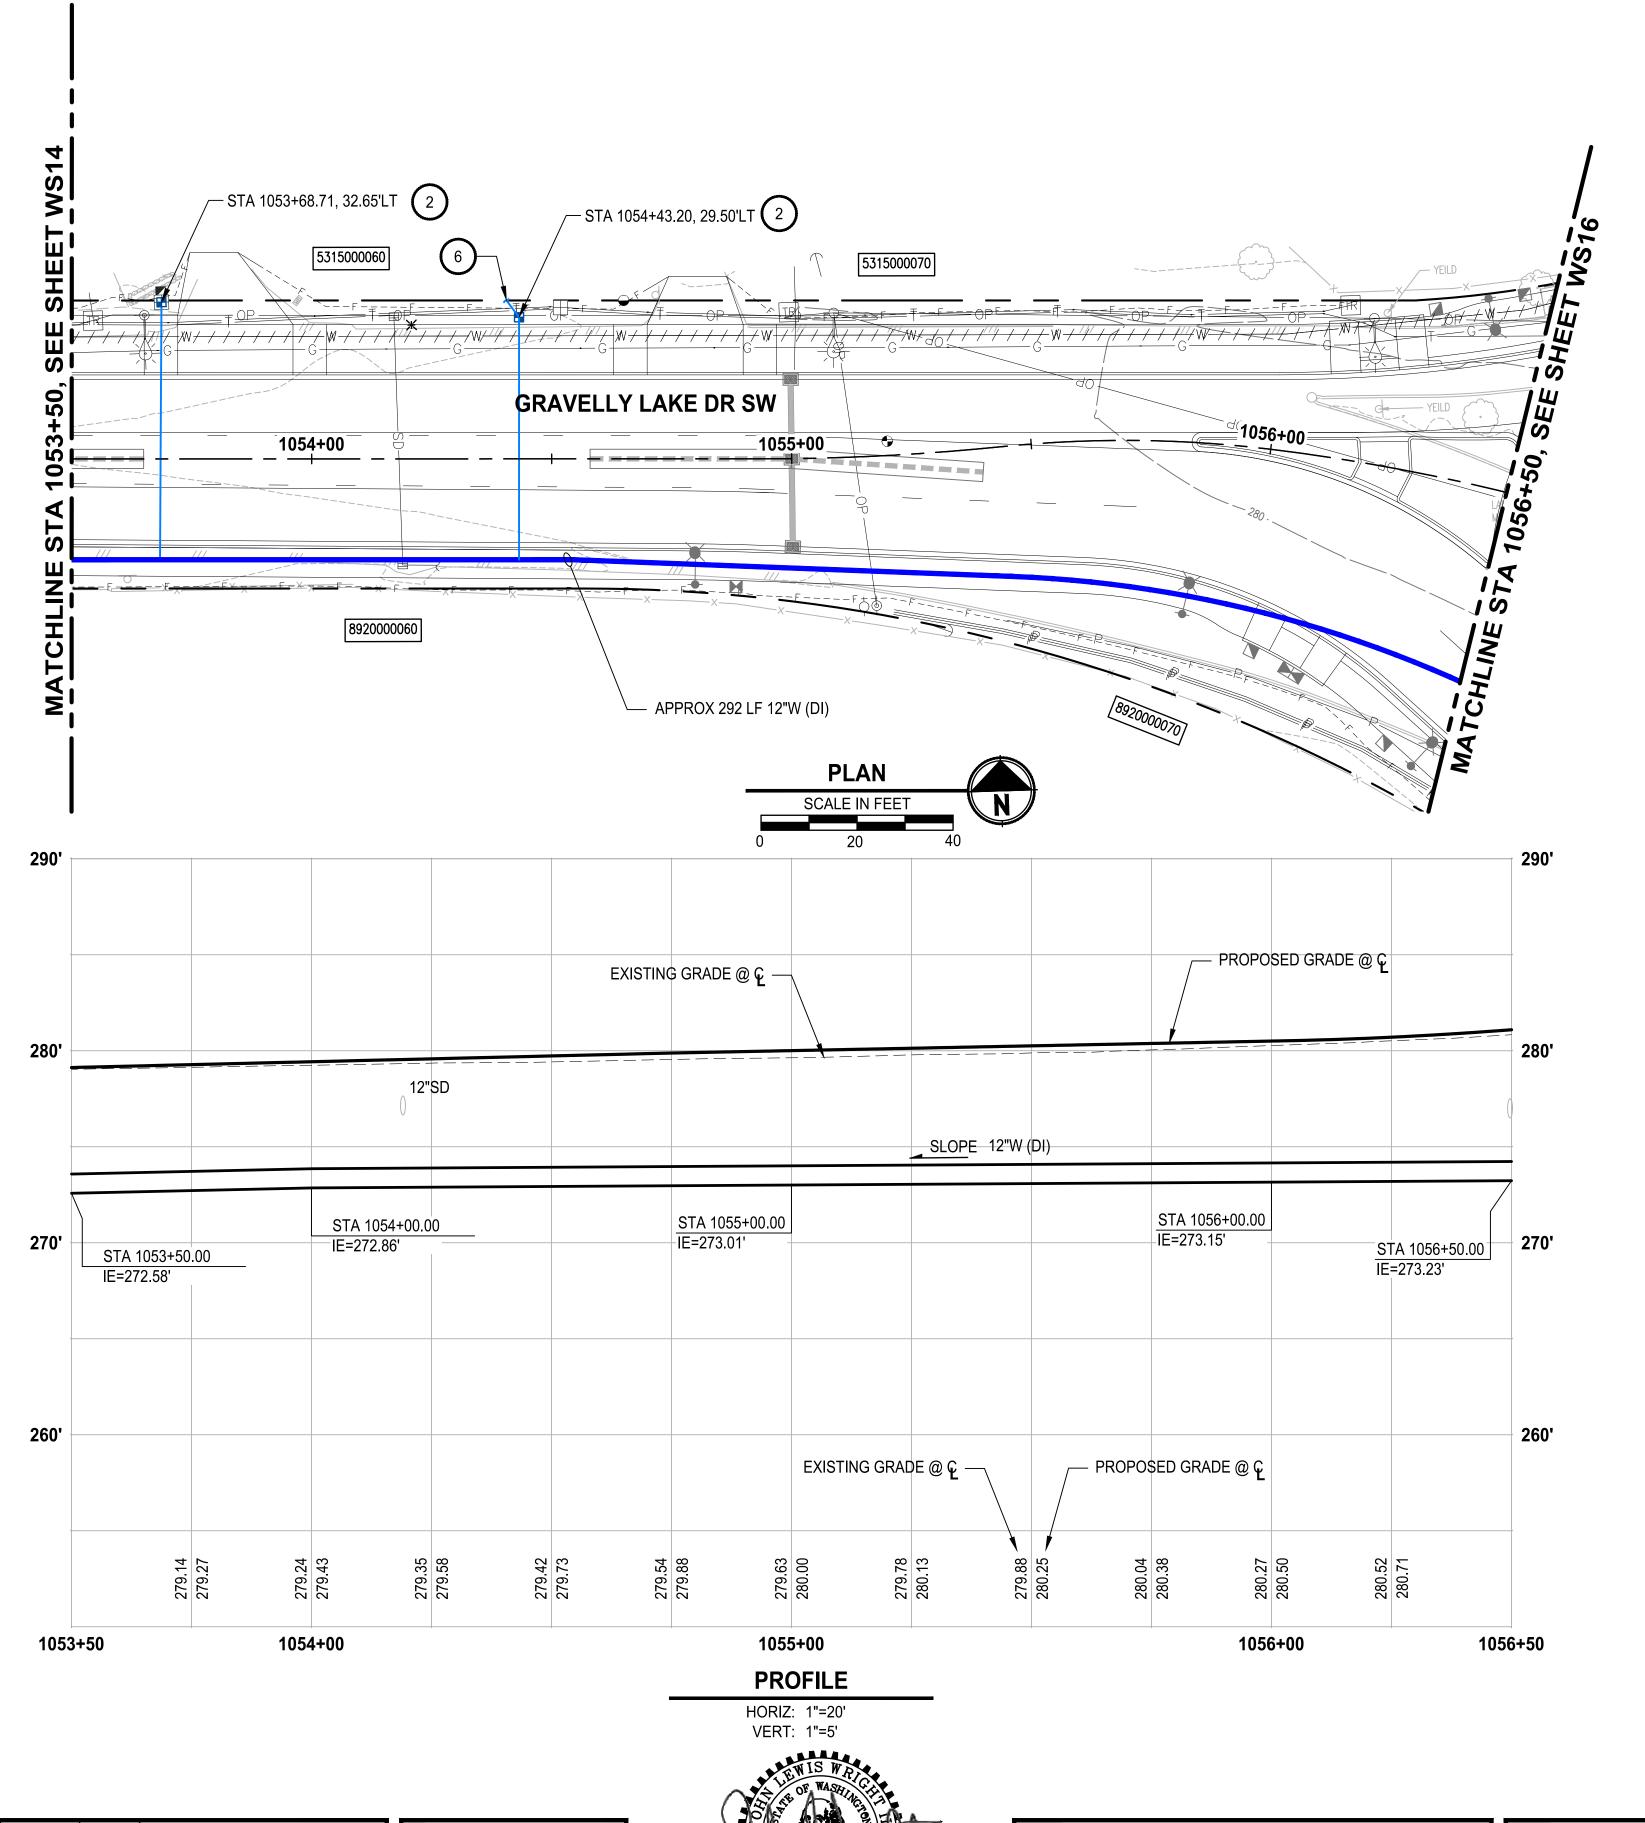DRAWING NO. 14 OF 21



#### **CONSTRUCTION NOTES:**

1 REPLACE WATER METER SERVICE PER LWD DETAIL 7A.
INSTALL NEW 1" POLY PIPE FROM NEW MAIN TO NEW METER
BOX AND SETTER, REMOVE AND REINSTALL EXISTING
METER AND CONNECT TO PROPERTY SIDE WATER SERVICE
PIPE.

WATER SERVICES LOCATED ON THE SIDE OF THE STREET OPPOSITE FROM THE WATER MAIN SHALL BE INSTALLED PER LWD DETAIL 7A IN A 2.5" PVC SCHEDULE 40 SOLVENT WELD JOINT SLEEVE JACKED OR PUSHED UNDER THE EXISTING ROADWAY PAVEMENT.

(3) INSTALL NEW FIRE HYDRANT ASSEMBLY PER LWD DETAIL 9.

4 REMOVE EXISTING FIRE HYDRANT ASSEMBLY.

( 5 ) INSTALL NEW BLOWOFF ASSEMBLY PER LWD DETAIL 13.

6 REFER TO RH2 PLANS FOR CONTINUATION

#### **NOTES:**

- 1. CONTRACTOR SHALL BE RESPONSIBLE FOR POTHOLING AND VERIFYING THE LOCATION, DEPTH, SIZE, MATERIAL, AND CONFIGURATION OF THE EXISTING WATER MAIN SYSTEM. VERIFICATION SHALL BE COMPLETED EARLY ENOUGH SO AS TO ADJUST PROPOSED WATER MAIN SYSTEM TO ACCOMMODATE ACTUAL CONDITIONS. UNDER NO CIRCUMSTANCES WILL LAKEWOOD WATER DISTRICT PAY THE CONTRACTOR ADDITIONAL MONIES TO RELAY WATER MAIN AND/OR FITTINGS INSTALLED UNDER THIS CONTRACT.
- 2. WHEN THE HORIZONTAL SEPARATION BETWEEN WATER AND SEWER IS LESS THAN 10-FEET, THE VERTICAL SEPARATION BETWEEN THE BOTTOM OF THE WATER MAIN AND THE CROWN OF THE SEWER SHALL BE 18-INCHES MINIMUM
- 3. ALL WATER MAIN JOINTS AND FITTINGS SHALL BE RESTRAINED.
- 4. CONTRACTOR SHALL RESTORE ALL DISTURBED AREAS BEYOND THE SCOPE OF THE ROADWAY AND SHOULDER IMPROVEMENTS TO THEIR EXISTING CONDITION OR BETTER. HYDROSEED ALL GRASS AREAS DISTURBED.
- 5. THE CONTRACTOR MAY INSTALL THE WATERMAIN AT THE STANDARD DEPTH SHOWN ON THE LAKEWOOD WATER DISTRICT'S STANDARD TRENCH DETAIL. ANY UTILITY CONFLICTS CREATED BY USING THE STANDARD LAKEWOOD WATER DISTRICT DEPTH SHALL BE MITIGATED THROUGH ADDITIONAL EXCAVATION AND FITTINGS AT THE SOLE COST OF THE CONTRACTOR.

#### LEGEND:

CAP AND ABANDON EXISTING WATER MAIN

ASPHALT PAVEMENT RESTORATION

CONCRETE PAVEMENT RESTORATION

Know what's below.
Call before you dig.

REVISIONS

DATE
BY

DESIGNED
Y. MAHMOODI

DRAWN
Y. MAHMOODI

CHECKED
R.—RAYMOND

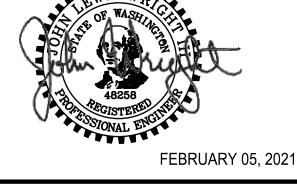
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J:—WRIGHT

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IF NOT, SCALE ACCORDINGLY

FILE NAME
PS4104017-WS12-19

JOB No.
216-4104-017

DATE
FEBRUARY 2021








WATER MAIN PLAN AND PROFILE GRAVELLY LAKE DR SW

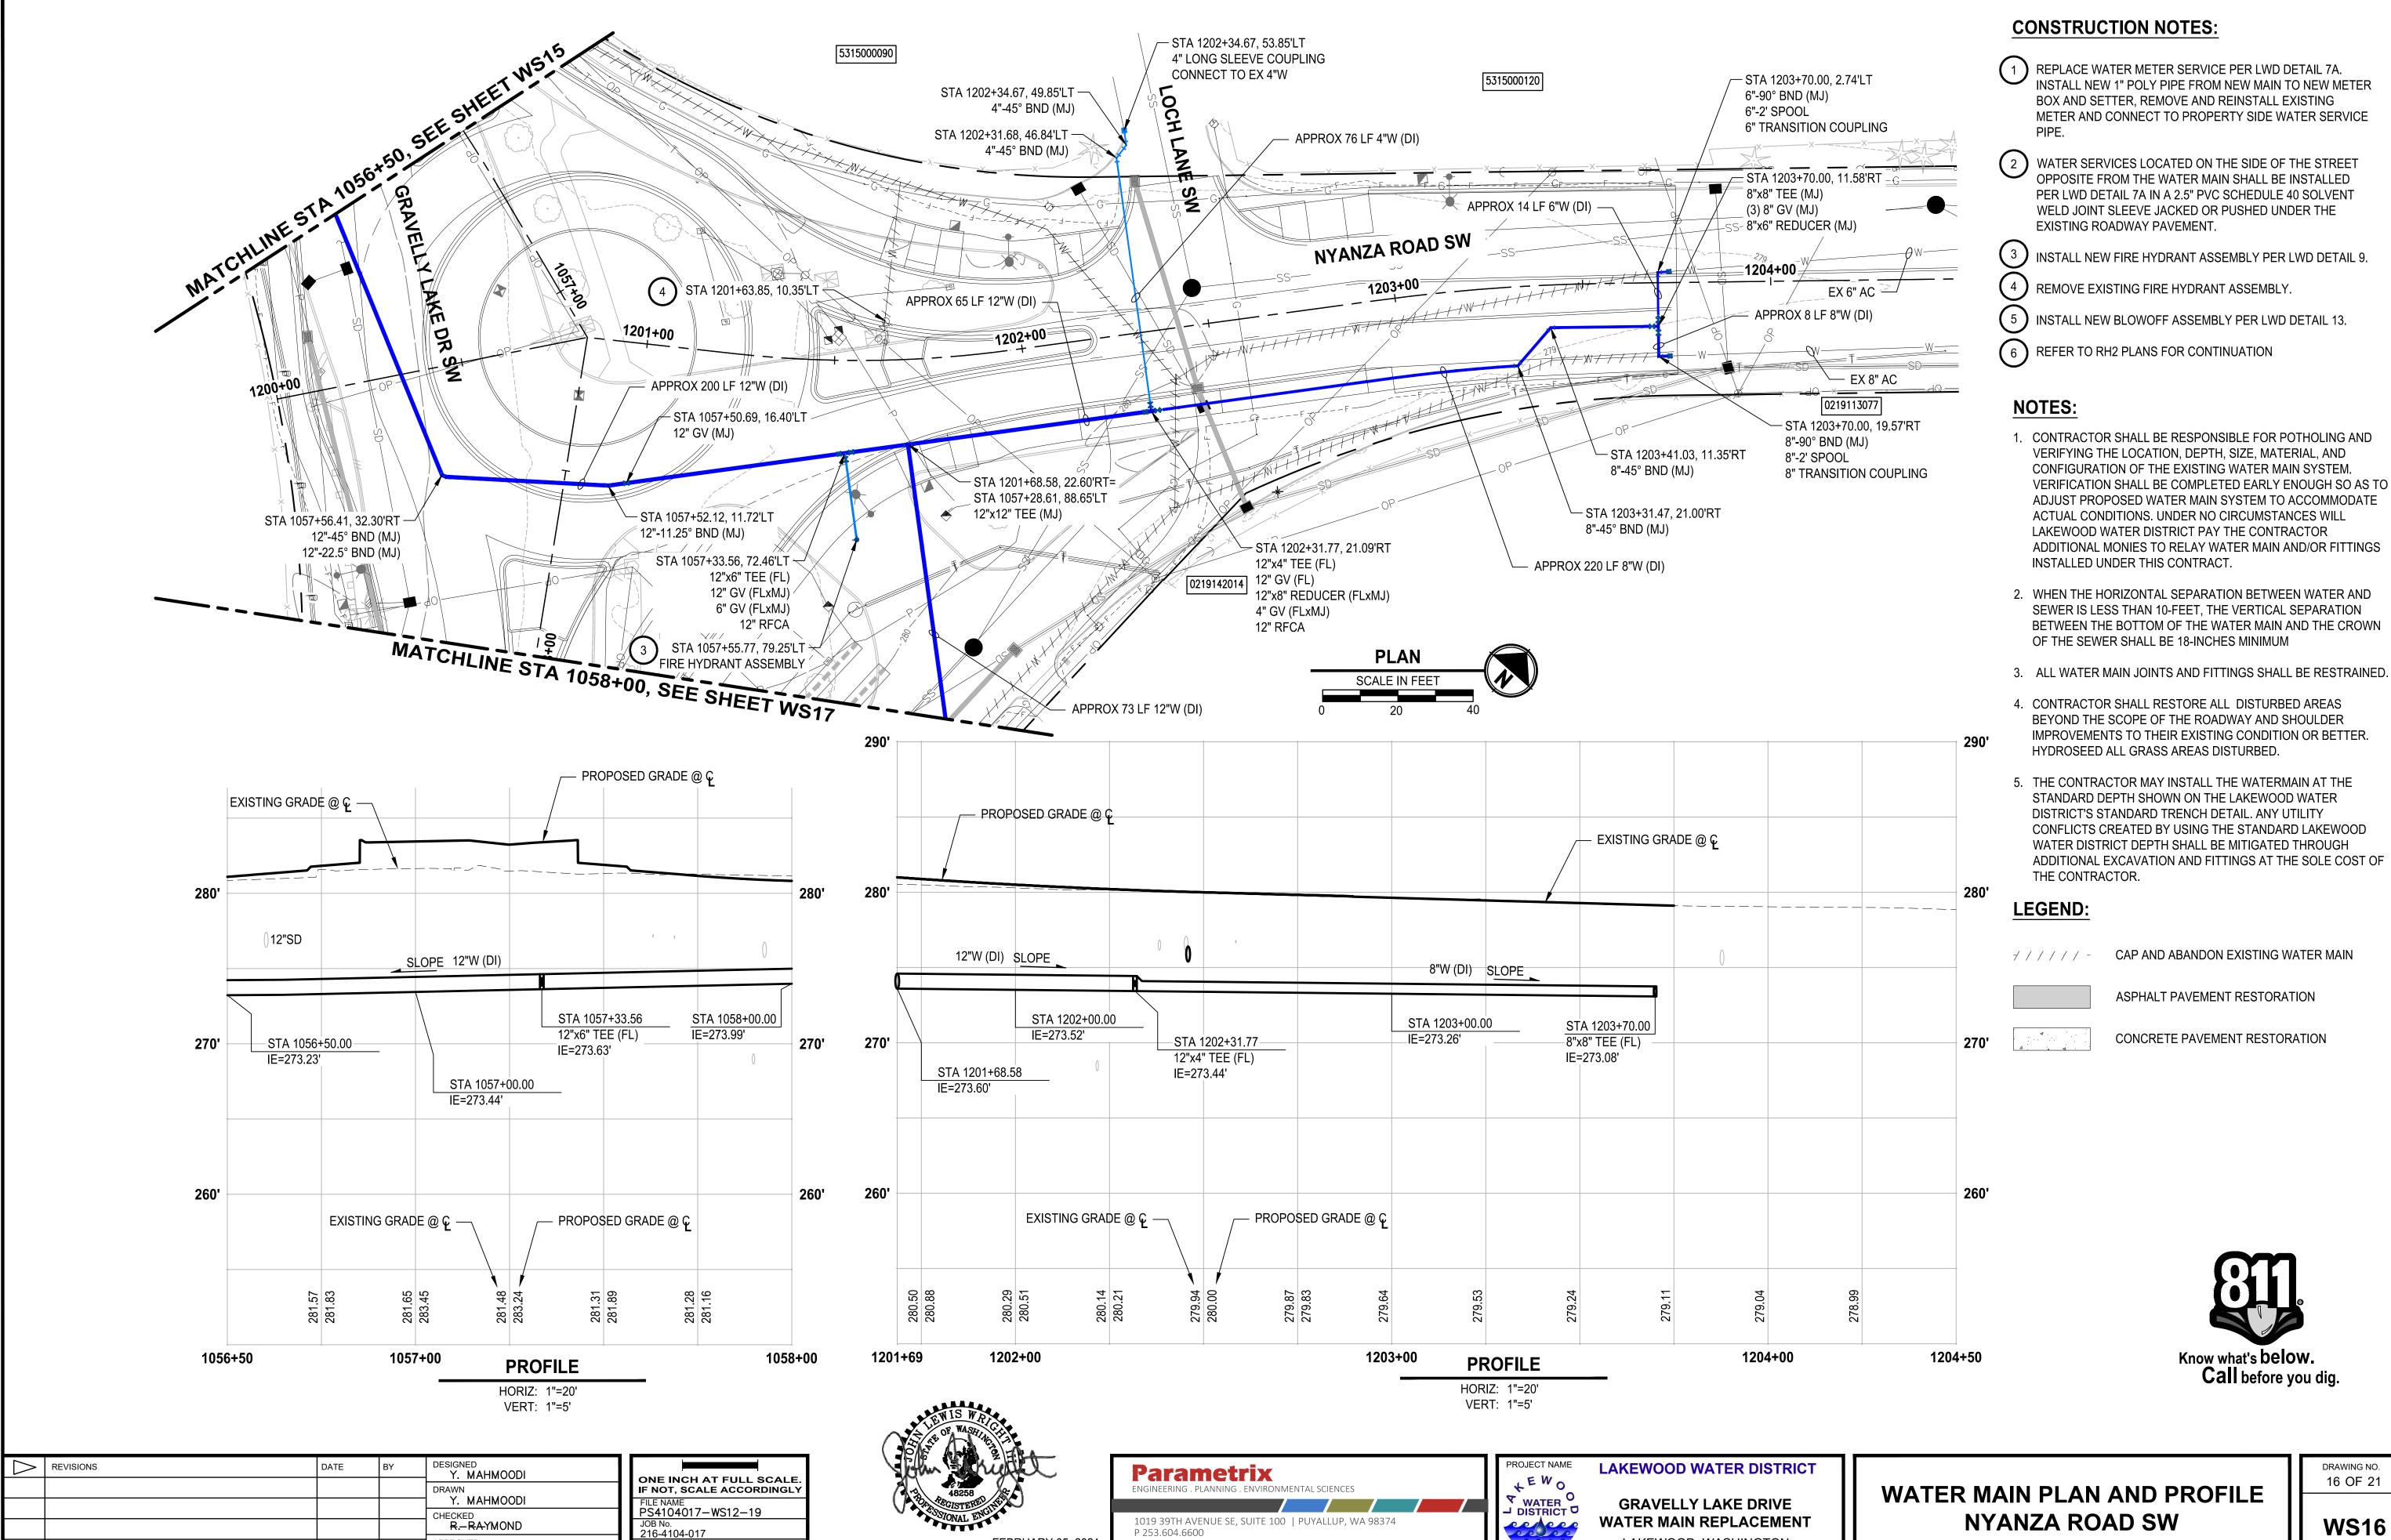DRAWING NO. 15 OF 21



FEBRUARY 05, 2021

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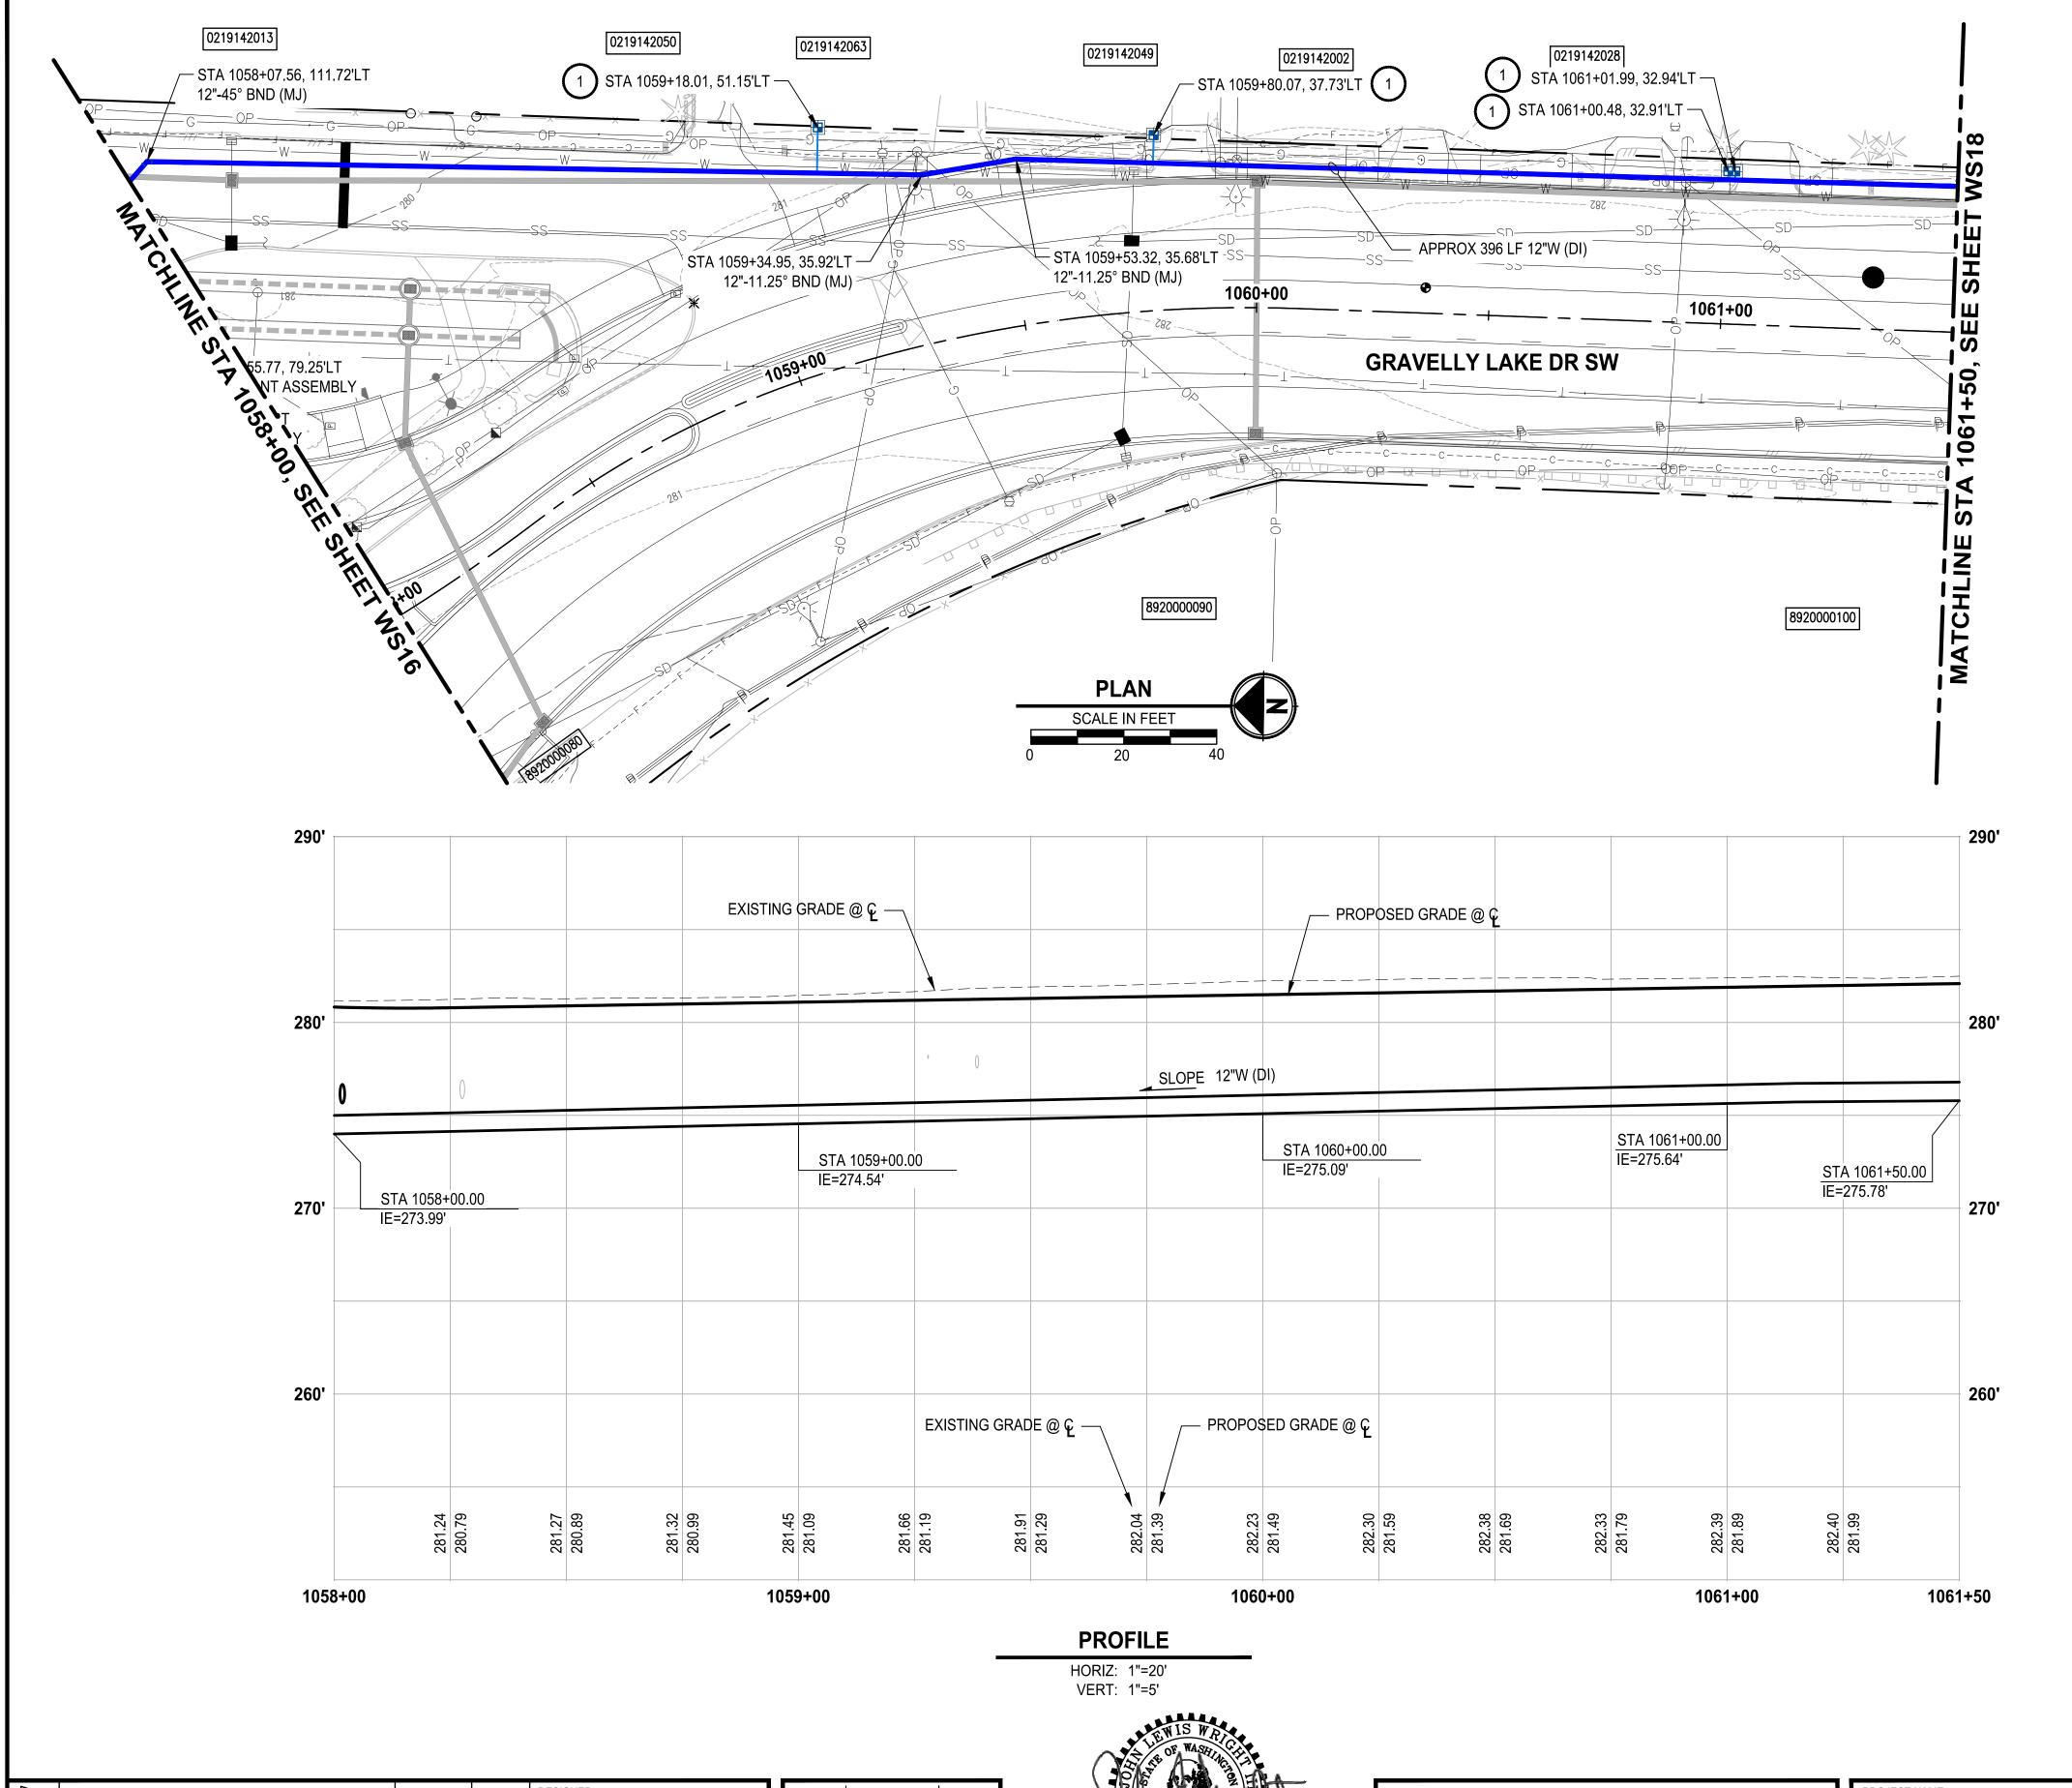
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<del>J.-WRI</del>GHT

DATE FEBRUARY 2021

**WS16** 

LAKEWOOD, WASHINGTON



#### **CONSTRUCTION NOTES:**

REPLACE WATER METER SERVICE PER LWD DETAIL 7A.
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#### LEGEND:

CAP AND ABANDON EXISTING WATER MAIN

ASPHALT PAVEMENT RESTORATION

CONCRETE PAVEMENT RESTORATION

Know what's below.
Call before you dig.

REVISIONS

DATE
BY

DESIGNED
Y. MAHMOODI

DRAWN
Y. MAHMOODI

CHECKED
R.—RAYMOND

APPROVED
J:—WRIGHT

ONE INCH AT FULL SCALE.
IF NOT, SCALE ACCORDINGLY

FILE NAME
PS4104017—WS12—19

JOB No.
216-4104-017

DATE
FEBRUARY 2021

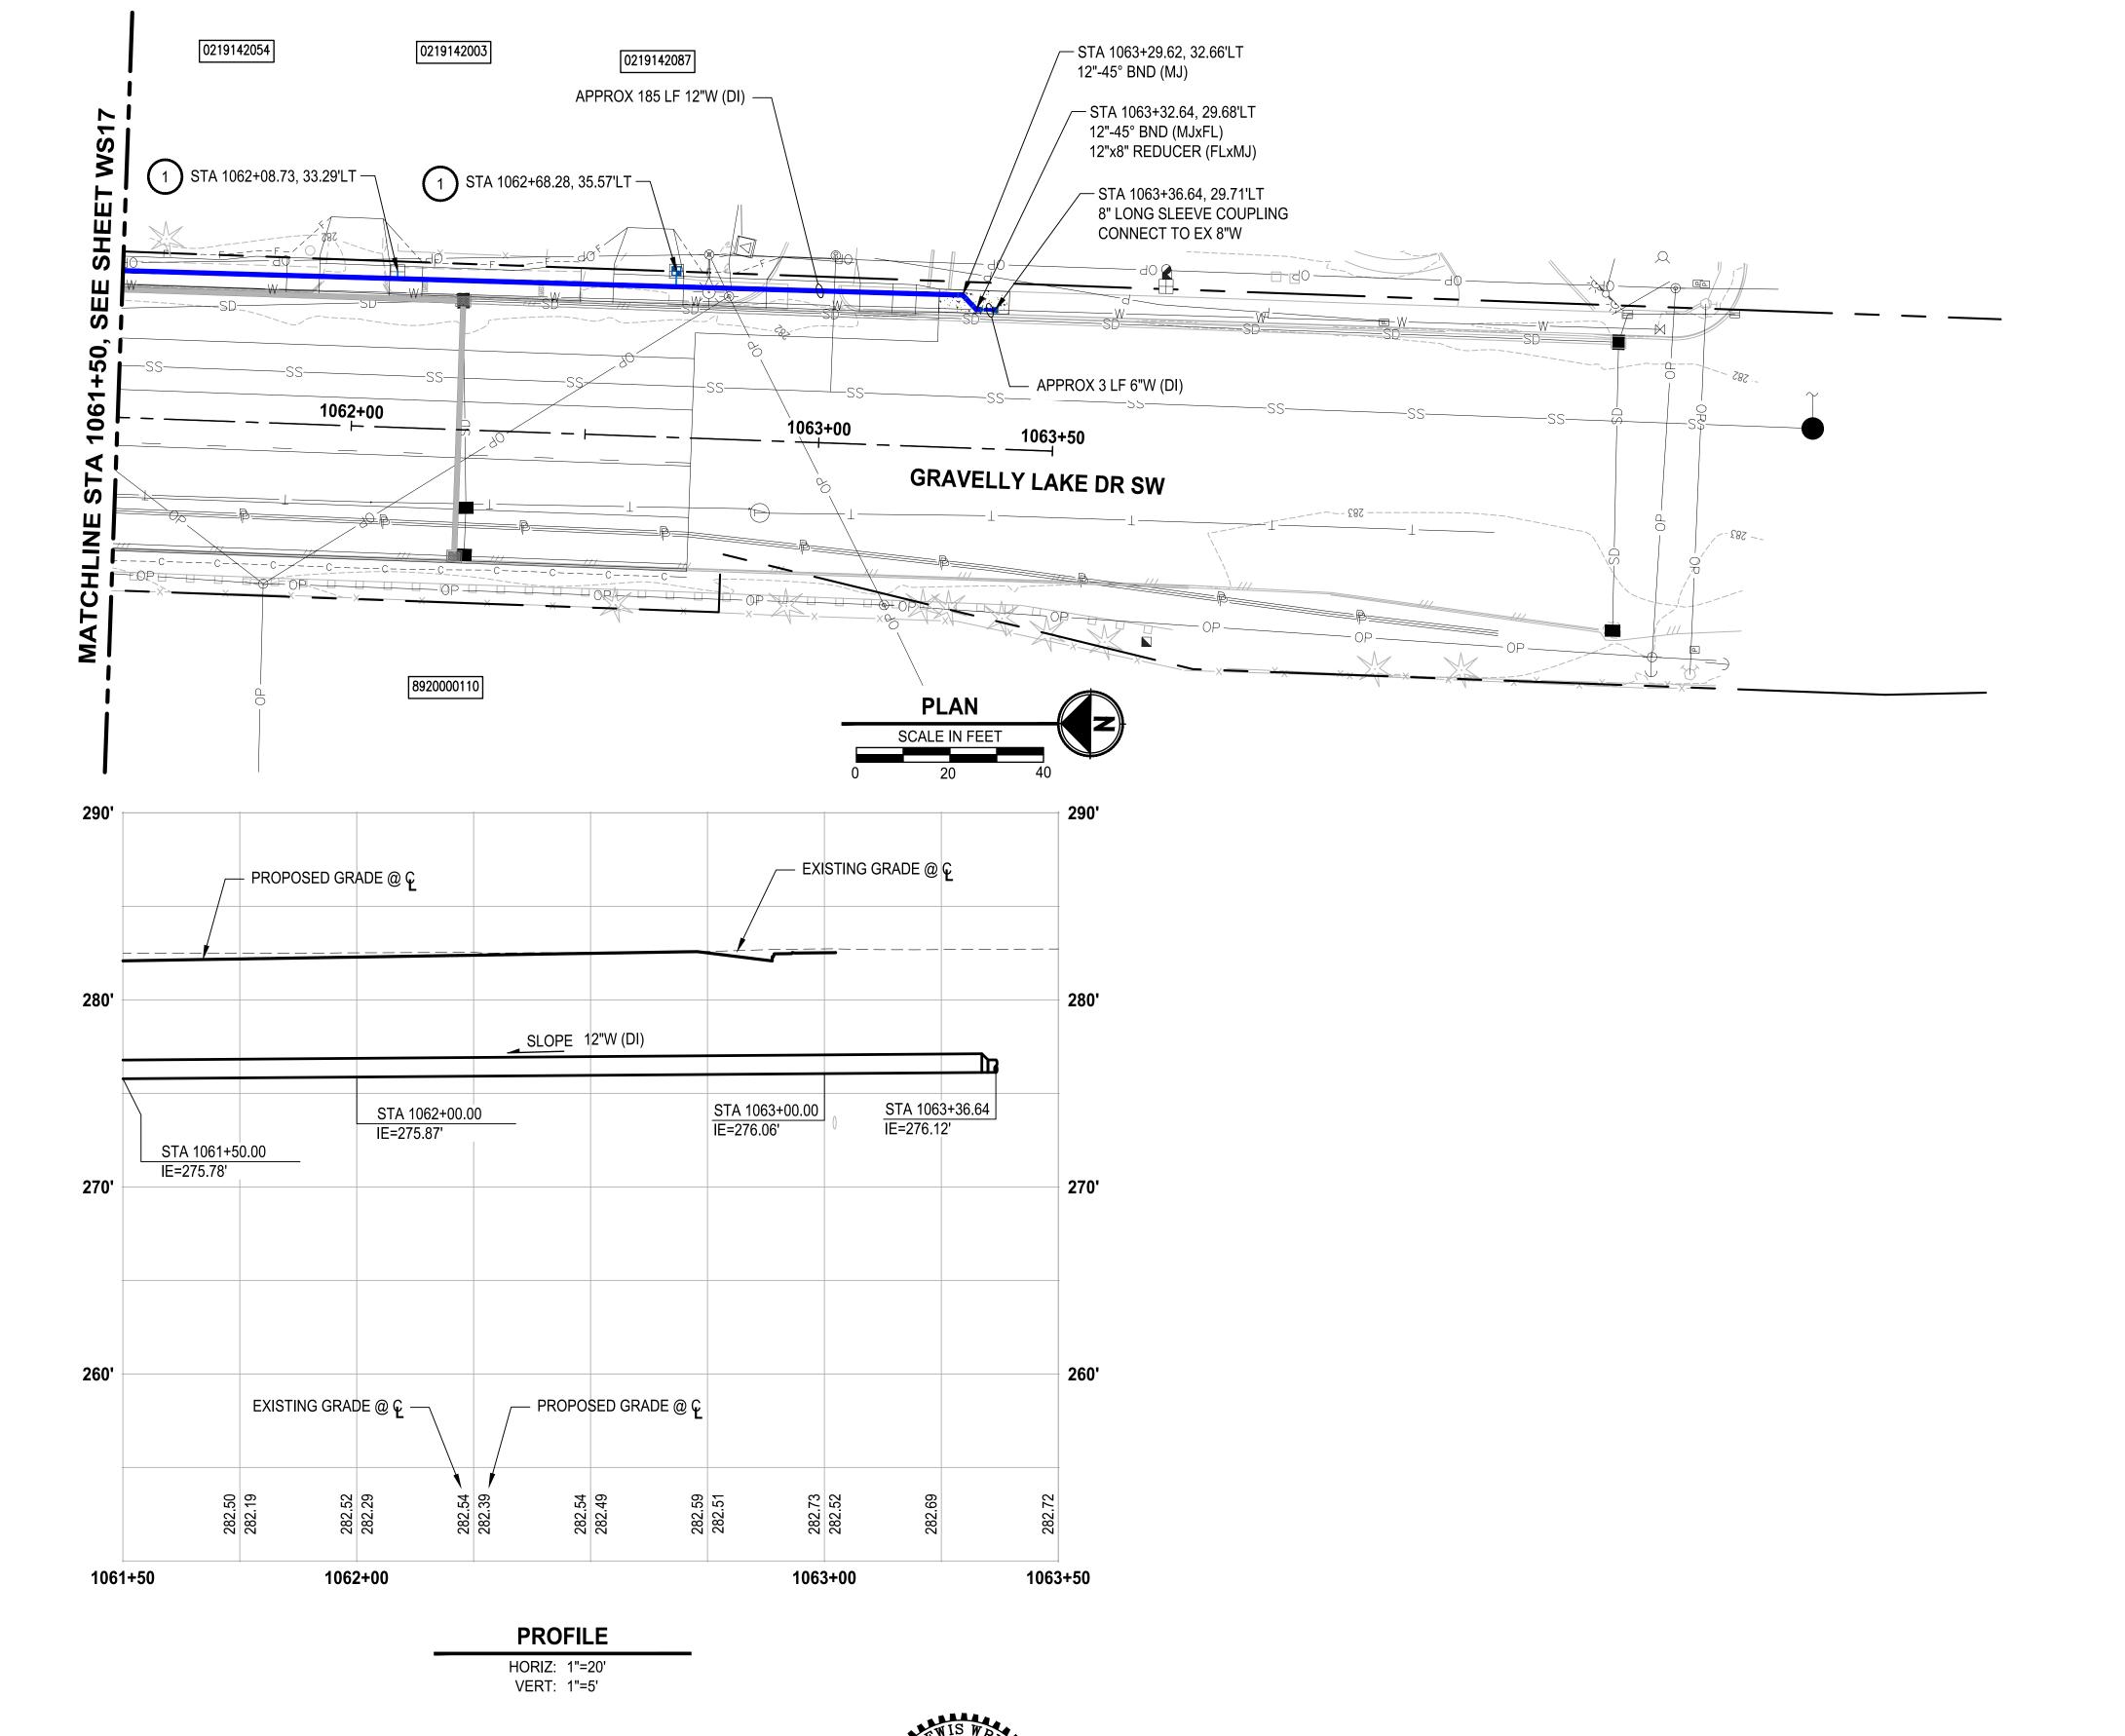






WATER MAIN PLAN AND PROFILE GRAVELLY LAKE DR SW

DRAWING NO. 17 OF 21



#### **CONSTRUCTION NOTES:**

1 REPLACE WATER METER SERVICE PER LWD DETAIL 7A.
INSTALL NEW 1" POLY PIPE FROM NEW MAIN TO NEW METER
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METER AND CONNECT TO PROPERTY SIDE WATER SERVICE
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#### **LEGEND**:

//// - CAP AND ABANDON EXISTING WATER MAIN

ASPHALT PAVEMENT RESTORATION

CONCRETE PAVEMENT RESTORATION

Know what's below.
Call before you dig.

REVISIONS

DATE
BY

DESIGNED
Y. MAHMOODI

DRAWN
Y. MAHMOODI

CHECKED
R.—RAYMOND

APPROVED
J:—WRIGHT

ONE INCH AT FULL SCALE.
IF NOT, SCALE ACCORDINGLY

FILE NAME
PS4104017—WS12—19

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216-4104-017

DATE
FEBRUARY 2021





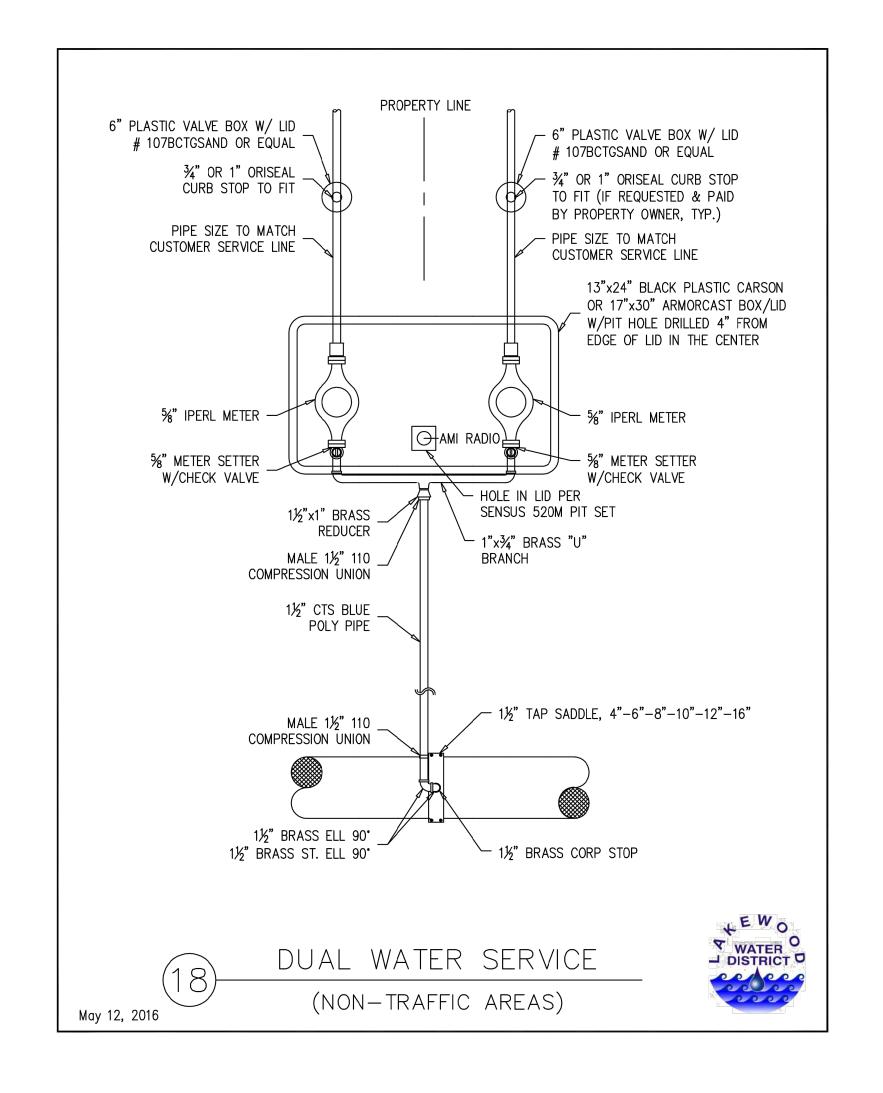


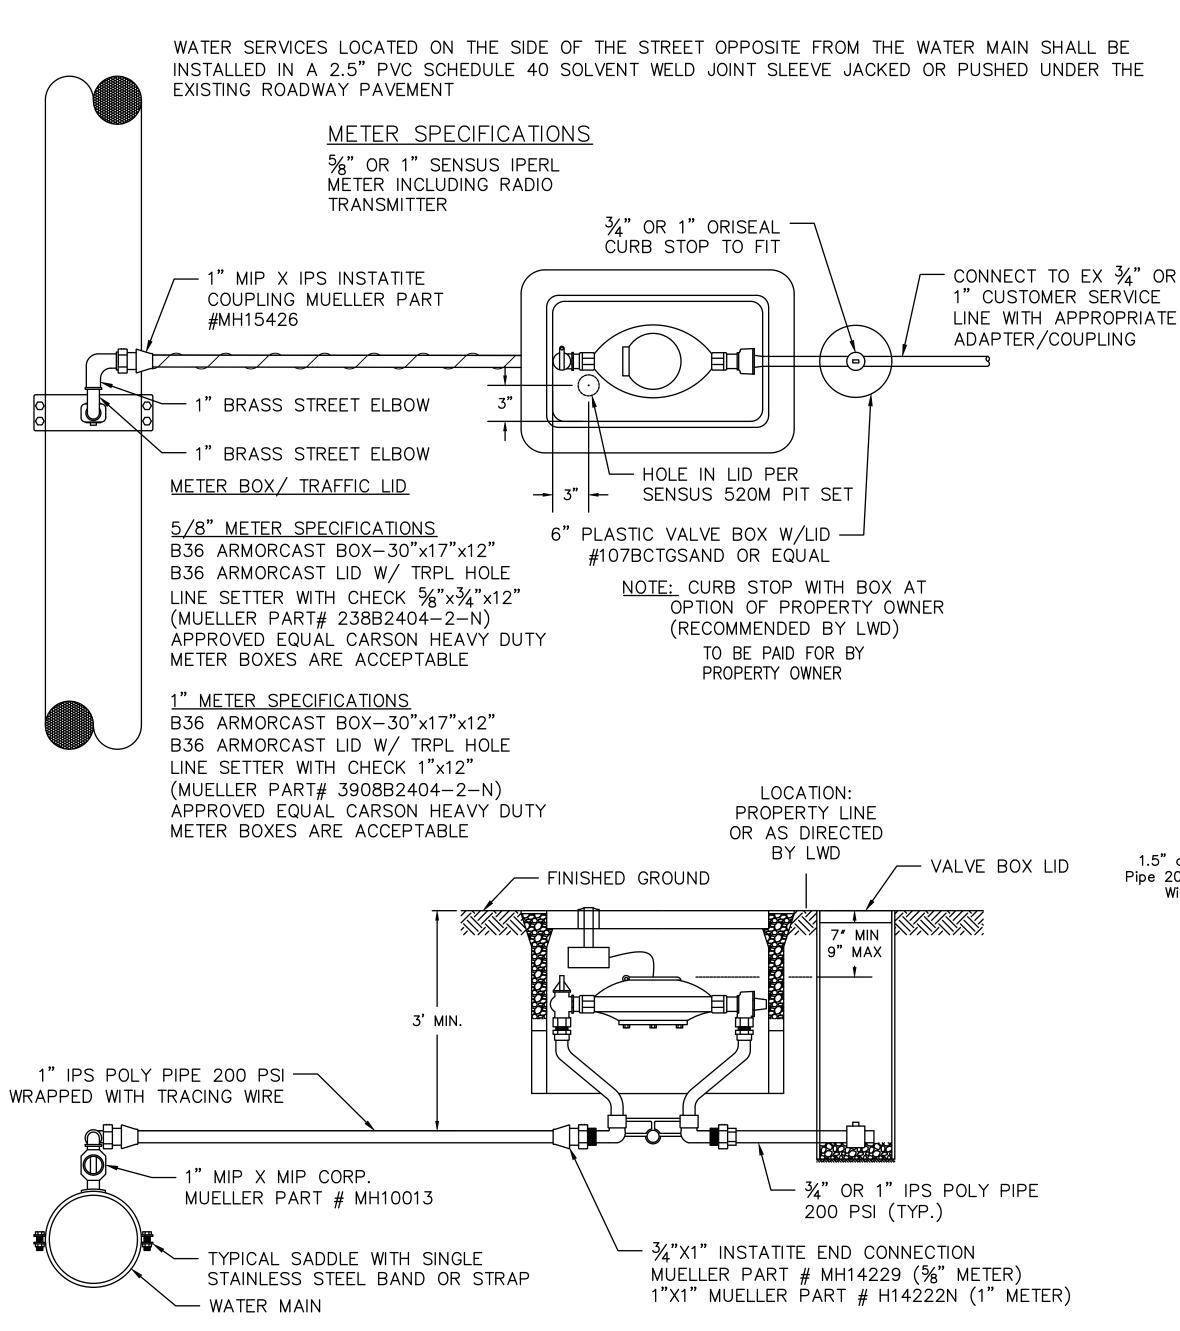
LAKEWOOD WATER DISTRICT

GRAVELLY LAKE DRIVE
WATER MAIN REPLACEMENT
LAKEWOOD, WASHINGTON

WATER MAIN PLAN AND PROFILE GRAVELLY LAKE DR SW

DRAWING NO. 18 OF 21





Water services located on the side of the street opposite from the water main shall be installed in a 2.5" (1.5" Service) or 3" (2" Service) PVC schedule 40 solvent weld joint sleeve jacked or pushed under the existing roadway pavement Connect to ex 1.5" OR 2" customer — METER SPECIFICATIONS

1½ or 2 Sensus OmniC2 service line with appropriate adapter/coupling Meter including radio 1  $\frac{1}{2}$ " or 2" Oriseal Curb Stop to fit transmitter Pipe size to match ex customer service line size, contractor to field verify Reinstall ex 1½" or — 2" customer meter 1.5" or 2" Angle Meter Check Valve and radio transmitter in new meter box 1.5" or 2" Brass Male 10 comp. union Model# 15428 w/stiffener 1.5" or 2" Brass Elbow 1.5" or 2" Brass Elbow — Hole in lid per SENSUS 520M PIT SET 6" plastic valve box — Meter Box/ Traffic Lid w/Lid #107BCTGSAND or equal 1.5 or 2" Meter Specifications B36 Armorcast box -30"x17"x12" Note: curb stop with box at B36 Armorcast lid w/trpl hole option of property owner All above lids must have TRPL hole for meter (recommended by LWD) Approved equal Carson heavy duty meter boxes are Location: property line or as directed / Valve — Finished ground Box Lid by LWD 7" min. 9" max. 1.5" or 2" CTS Poly -Pipe 200 PSI wrapped With tracing wire 1.5" or 2" 1 ½ " or 2" CTS Poly Pipe 200 PSI (TYP.) -1.5 or 2" MIP x MIP Corp. Mueller Part #H-9969 — 1.5"or 2" X12"Brass Nipple Typical Saddle with single stainless steel band or strap — 1.5" or 2" Brass Elbow ── Water main 1.5" or 2" Brass Street Elbow

TYPICAL WATER SERVICE FOR 1.5" AND 2" ASSEMBLY

TYPICAL WATER SERVICE FOR A 5/8" AND 1" ASSEMBLY

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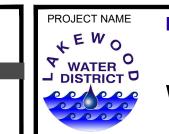
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ATH	$\triangle$	REVISIONS	DATE	BY	DESIGNED Y. MAHMOODI
-					DRAWN
/SD0					Y. MAHMOODI CHECKED
N: N					R. RAYMOND
AYOL					APPROVED J. WRIGHT

ONE INCH AT FULL SCALE. IF NOT, SCALE ACCORDINGLY PS4104017-WSD01-03 216-4104-017 EBRUARY 2021







**LAKEWOOD WATER DISTRICT** 

**GRAVELLY LAKE DRIVE** WATER MAIN REPLACEMENT LAKEWOOD, WASHINGTON

LAKEWOOD WATER DISTRICT **DETAILS** 

DRAWING NO. 19 OF 21

WSD1

NOTES:

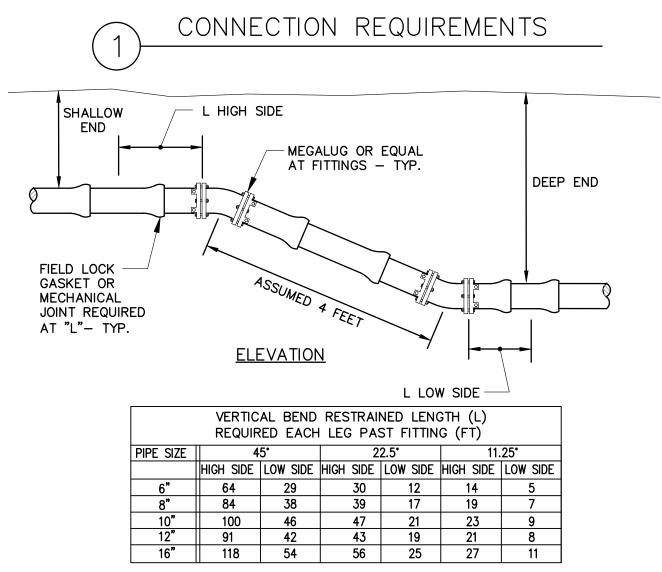
TAPPED CONNECTIONS NOT ALLOWED WITHOUT SPECIFIC APPROVAL FROM THE DISTRICT. NO CONNECTION WILL BE ALLOWED UNTIL ALL PRESSURE TESTING COMPLETED, AND SATISFACTORY BACTERIOLOGICAL TEST RECEIVED. SEE CROSS CONNECTION CONTROL SECTION IN SPECIFICATIONS. TAPPING SLEEVE TO BE STAINLESS STEEL FOR AC PIPE AND EPOXY COATED STEEL FOR DUCTILE OR CAST IRON PIPE. CLOSEST EDGE OF TAPPING SLEEVE MUST BE 3' (MIN.) FROM COUPLING ON AC PIPE.

SEE DETAILS FOR VALVE BOX, THRUST BLOCKING. PIPE AND FITTING RESTRAINT REQUIREMENTS BACKFILL PER JURISDICTIONAL REQUIREMENTS WHEN IN ASPHALT. ALL OTHER AREAS PER THE STANDARD SPECIFICATIONS.

TEMP BLOW OFF'S MUST BE PROTECTED FROM DAMAGE. PLACE IN TRAFFIC BOX IF REQUIRED. WATER OUTAGE ONLY ALLOWED TUESDAY THROUGH THURSDAY 9:00AM TO 3:00PM. (7) WORKING DAYS NOTICE REQUIRED.

ALL MJ JOINTS TO BE MEGALUG OR EQUAL.


SIMILAR TEMP B.O. REQUIREMENTS FOR TAPPED CONNECTIONS. LOCATE BLOW OFF OUT OF ASPH. WHEN POSSIBLE. ALL FITTINGS AND PIPE SHALL BE STERILE SWABBED. CONNECTION SHALL BE INSPECTED FOR VISUAL LEAKAGE UNDER FULL LINE PRESSURE PRIOR TO BACKFILL.




#### **NOTES:**

- RESTRAINED LENGTH SHALL BE ADJUSTED IF CONDITIONS DIFFER FROM ASSUMPTIONS.
- IF RESTRAINED LENGTH SHOWN IS NOT ACHIEVABLE, THRUST BLOCKS SHALL ALSO BE
- USED. CONTACT DISTRICT FOR THRUST BLOCKING DETAIL. ALL PIPE BETWEEN VERTICAL BENDS SHALL BE RESTRAINED.
- RESTRAINED LENGTHS CAN BE ADJUSTED WITH SITE SPECIFIC SOILS INFORMATION,
- ENGINEER DESIGN AND DISTRICT APPROVAL. 90° VERTICAL BENDS ARE NOT ALLOWED.
- MULTIPLE FITTINGS IN MULTIPLE PLANES SHALL BE DESIGNED AND STAMPED ON AN INDIVIDUAL BASIS BY A PROFESSIONAL ENGINEER LICENSED IN THE STATE OF
- **ASSUMPTIONS:**
- TEST PRESSURE 200 PSI.
- LAYING CONDITION 3. SAND-SILT SOIL DESIGNATION.
- SHALLOW END COVER ON 6-10" DIA. AT 3 FEET; COVER ON 12-16" DIA. AT 4 FEET. LENGTH BETWEEN FITTINGS ASSUMED TO BE 4 FEET SO KNOWN LENGTH IS 2 FEET.
- SAFETY FACTOR 1.5
- VALUES DEVELOPED WITH DIPRA THRUST RESTRAINT CALCULATOR.
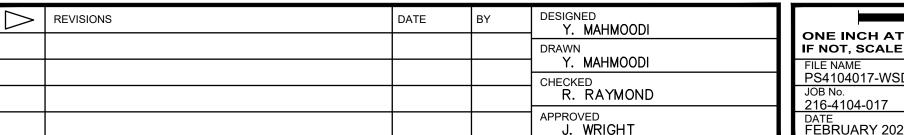
# VERTICAL BEND RESTRAINT



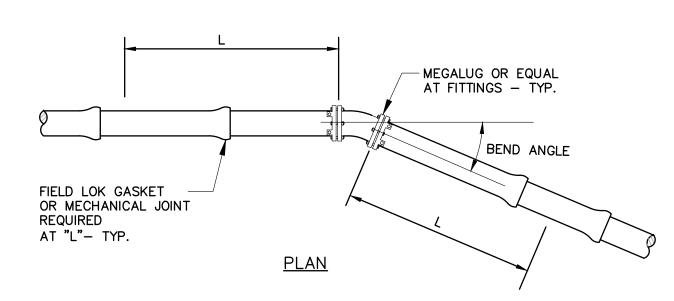
ONE INCH AT FULL SCALE IF NOT, SCALE ACCORDINGLY PS4104017-WSD01-03 FEBRUARY 2021



HORIZONTAL BEND RESTRAINED LENGTH (L) REQUIRED EACH LEG PAST FITTING (FT)							
PIPE SIZE   TEE OR PLUG   90°   45°   22.5°   11.25							
6"	79	38	16	8	4		
8"	103	50	21	10	5		
10"	124	59	25	12	6		
12"	113	54	23	11	6		
16"	145	68	29	14	7		

- RESTRAINED LENGTH SHALL BE ADJUSTED IF CONDITIONS DIFFER FROM ASSUMPTIONS. IF RESTRAINED LENGTH SHOWN IS NOT ACHIEVABLE, THRUST BLOCKS SHALL ALSO BE
- USED. SEE DETAIL 3.
- RESTRAINED LENGTHS CAN BE ADJUSTED WITH SITE SPECIFIC SOILS INFORMATION, ENGINEER DESIGN AND DISTRICT APPROVAL.
- MULTIPLE FITTINGS IN MULTIPLE PLANES SHALL BE DESIGNED AND STAMPED ON AN INDIVIDUAL BASIS BY A PROFESSIONAL ENGINEER LICENSED IN THE STATE OF WASHINGTON.
- <u> ASSUMPTIONS:</u>
- TEST PRESSURE 200 PSI. LAYING CONDITION 3.
- SAND-SILT SOIL DESIGNATION.
- COVER ON 6-10" DIA. AT 3 FEET; COVER ON 12-16" DIA. AT 4 FEET. SAFETY FACTOR 1.5
- VALUES DEVELOPED WITH DIPRA THRUST RESTRAINT CALCULATOR.


# HORIZONTAL BEND RESTRAINT

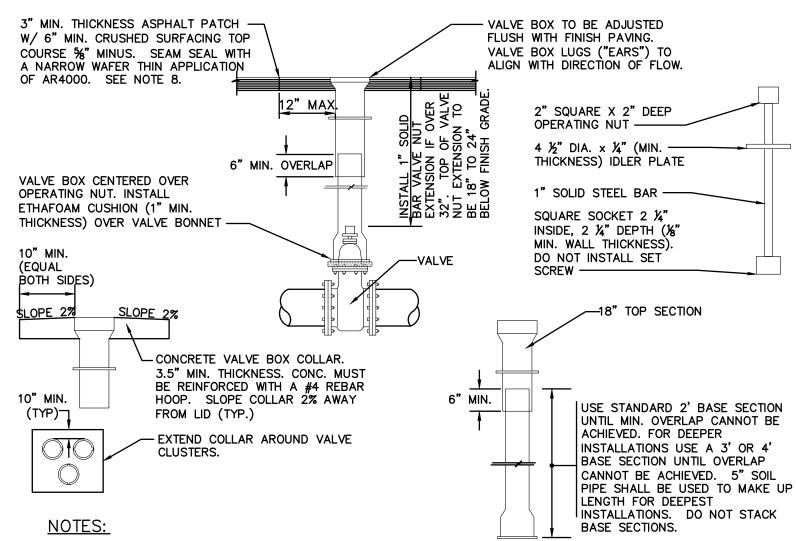


#### 1. VALVE BOX TO BE 045/046 - SEATTLE/TACOMA TOP AND LID.

- 2. VALVE BOX LIDS TO BE 4" DEEP IN TRAFFIC AREAS AND A MIN. OF 3" IN OTHER LOCATIONS. LOCKING
- VALVE BOX LIDS (AMPRO STYLE 940) REQUIRED IF LIDS WILL NOT STAY PUT DUE TO TRAFFIC. 3. SAWCUT VALVE BOX COMPONENTS. BROKEN OR JAGGED VALVE BOX SECTIONS NOT ACCEPTABLE.
- 4. OVERLAY ADJUSTMENT RINGS NOT ALLOWED, UNLESS APPROVED BY THE DISTRICT.
- 5. VALVE BOX COLLARS REQUIRED IF VALVE BOX OUT OF PAVING. COLLARS TO BE FLUSH WITH FINISH SURFACE. SLOPE COLLARS AWAY FROM LID @ 2% (TYP.)
- 6. VALVE BOX LIDS TO BE PAINTED (2) COATS SAFETY YELLOW PAINT.
- 7. VALVE BOX COLLAR REQUIRED WHEN VALVE BOX OUTSIDE OF PAVING.
- 8. VALVE BOXES SHALL BE ADJUSTED AFTER PAVING AND PATCHED AS SHOWN ABOVE. VALVES CONNECTED TO THE EXISTING SYSTEM SHALL BE MADE ACCESSIBLE AT ALL TIMES.
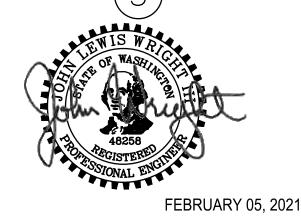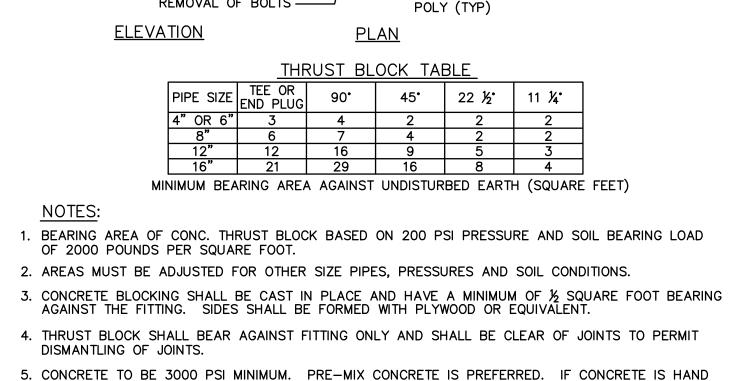
# VALVE BOX INSTALLATION







<u>PLUGGED TEE</u>

- UNDISTURBED

- 20 LB. BUILDING

PAPER OR 4 MIL

EARTH

HORIZONTAL BEND

6. CONTRACTOR SHALL INSTALL BLOCKING ADEQUATE TO WITHSTAND FULL TEST PRESSURE AS WELL AS TO CONTINUOUSLY WITHSTAND OPERATING PRESSURE UNDER ALL CONDITIONS OF SERVICE.

MIXED THE PROPORTIONS SHALL BE IN ACCORDANCE WITH THE SPECIFICATIONS. COMPRESSIVE

TESTS OF "HAND MIXED" CONCRETE MAY BE REQUIRED. PRE-INSPECTION OF BLOCKING AREA

7. SEE STANDARD PLAN NO. 2 FOR PIPE AND FITTING RESTRAINT REQUIREMENTS.

REQUIRED PRIOR TO PLACEMENT OF CONCRETE.

— STEEL PLATE.

FOR BOLT

REMOVAL

\* USE 12" OR

- 3000 PSI CONCRETE

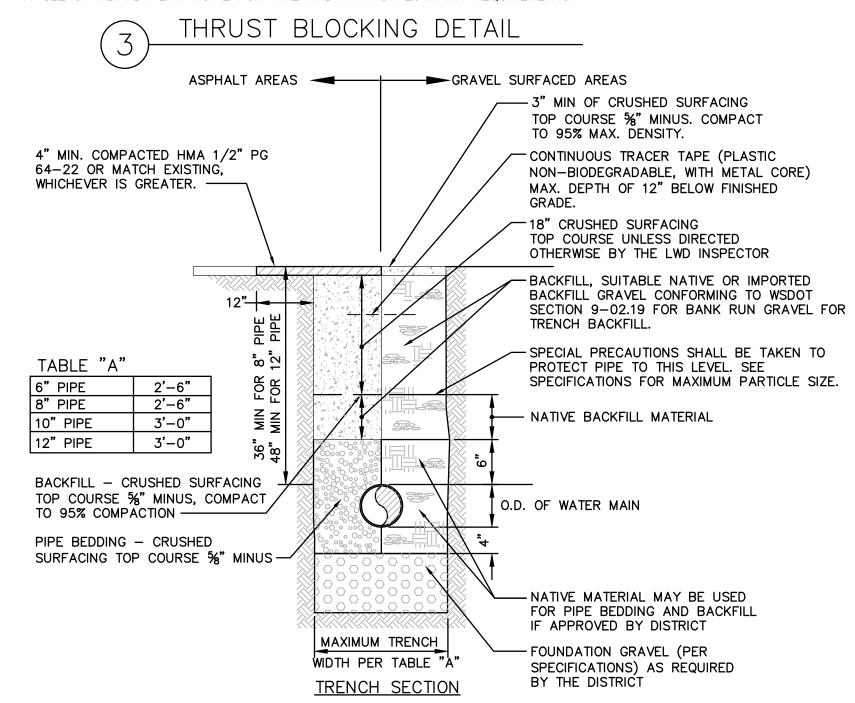
FORMED TO ALLOW FOR

REMOVAL OF BOLTS -

L/2, WHICHEVER IS GREATER.

CROSS WITH PLUG

FORM TO ALLOW



### NOTES:

WATER

→ DISTRICT □

ee eee

- 1. BEDDING REQUIRED ONLY IF DIRECTED BY THE DISTRICT DUE TO NATIVE SOIL CONDITIONS. BEDDING SHALL BE %" CRUSHED SURFACING IF NATIVE MATERIAL IS JUDGED UNSUITABLE BY THE DISTRICT. BEDDING UNDER ASPHALT OR CONCRETE PAVEMENT AREAS SHALL BE CRUSHED ROCK 1/2" MINUS.
- 2. PUMPING SOILS SHALL BE REMOVED FROM THE TRENCH BACKFILL IMMEDIATELY.

LAKEWOOD WATER DISTRICT

**GRAVELLY LAKE DRIVE** 

WATER MAIN REPLACEMENT

LAKEWOOD, WASHINGTON

- 3. TEMPORARY PATCH TO BE BACKFILLED AND COMPACTED TO EXISTING GROUND LINE AND PATCHED WITH CRUSHED ROCK SURFACING OR HMA 1/2" PG 64-22. TEMPORARY PATCH SHALL BE 2" THICK OR AS DIRECTED BY LWD INSPECTOR.
- 4. BACKFILL MATERIAL PLACED IN 6" LIFTS AND COMPACTED TO 95% MAXIMUM DENSITY. BACKFILL OF THE TOP 18" SHALL BE CRUSHED ROCK %" MINUS UNDER ASPHALT OR CONCRETE PAVEMENT AND NATIVE MATERIAL IN GRAVEL AREAS IF APPROVED BY THE DISTRICT.





LAKEWOOD WATER DISTRICT **DETAILS** 

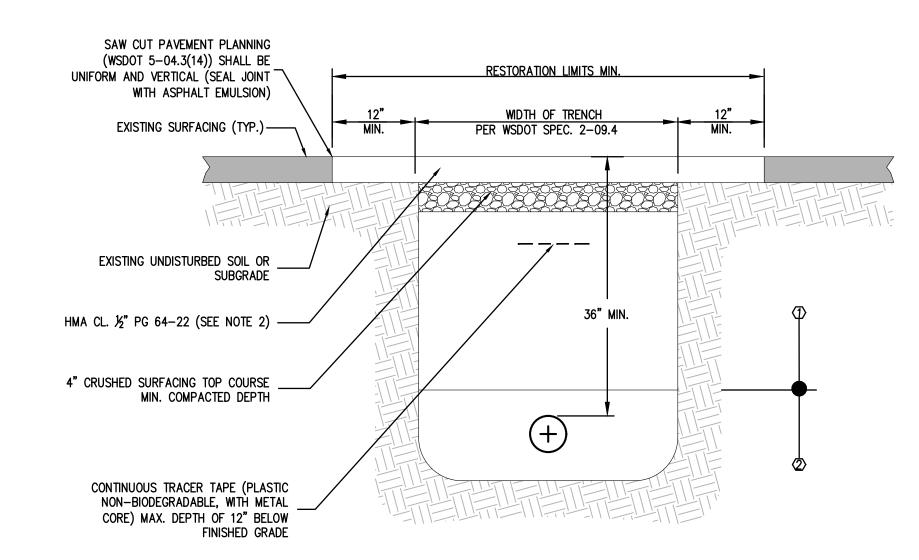
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WSD2

DRAWING NO.

LOCATE BOLLARDS 3' MINIMUM FROM HYDRANT DO NOT BLOCK HYDRANT PORTS.





**RESTORATION GENERAL NOTES:** 1. MATERIALS AND CONSTRUCTION REQUIREMENTS SHALL BE PER LATEST EDITION OF WSDOT STANDARD SPECIFICATIONS FOR ROAD,

BRIDGE, AND MUNICIPAL CONSTRUCTION UNLESS OTHERWISE NOTED. 2. COMPACTED HMA DEPTH SHALL BE 3" MINIMUM OR AS SHOWN IN

PLANS OR PERMIT, WHICHEVER IS GREATER, AND SHALL BE COMPACTED TO 92% OF RICE DENSITY.

**DETAIL GENERAL NOTES:** 1. ALL PATCHES ACROSS CITY STREETS SHALL CONFORM TO THIS

PER ASTM 1557.

**BACKFILL COMPACTION LEGEND** (1) BACKFILL MATERIAL SHALL BE PLACED IN 6" LIFTS AND COMPACTED TO MINIMUM OF 95% MAXIMUM DENSITY OF THE MODIFIED PROCTOR

② BEDDING MATERIAL SHALL BE PLACED IN 4" LIFTS AND COMPACTED TO MINIMUM OF 95% MAXIMUM DENSITY OF THE MODIFIED PROCTOR PER ASTM 1557.

# (11) CITY OF LAKEWOOD TRENCH PATCH DETAIL

$\triangle$	REVISIONS	DATE	BY	DESIGNED Y. MAHMOODI	
				DRAWN	
				Y. MAHMOODI CHECKED	
				R. RAYMOND	
				APPROVED J WRIGHT	

ONE INCH AT FULL SCALE. IF NOT, SCALE ACCORDINGLY PS4104017-WSD01-03 JOB No. 216-4104-017 FEBRUARY 2021



# **Parametrix** ENGINEERING . PLANNING . ENVIRONMENTAL SCIENCES 1019 39TH AVENUE SE, SUITE 100 | PUYALLUP, WA 98374 P 253.604.6600 WWW.PARAMETRIX.COM






**GRAVELLY LAKE DRIVE** WATER MAIN REPLACEMENT LAKEWOOD, WASHINGTON

LAKEWOOD WATER DISTRICT **DETAILS** 

DRAWING NO. 21 OF 21

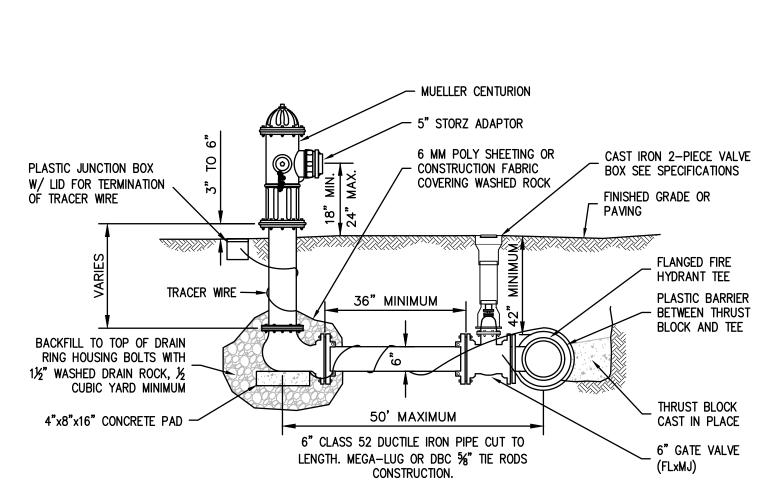
WSD3



- 1. ANY HYDRANT SETBACK LONGER THAN ONE FULL LENGTH OF PIPE THAT REQUIRES A BELL AND SPICKET WILL NEED A FIELD LOCK GASKET, AND MAY REQUIRE A THRUST BLOCK AT THE DIRECTION OF THE INSPECTOR.
- 2. MAINTAIN MINIMUM 3' RADIUS UNOBSTRUCTED WORKING AREA AROUND HYDRANT INCLUDING FUTURE IMPROVEMENTS.



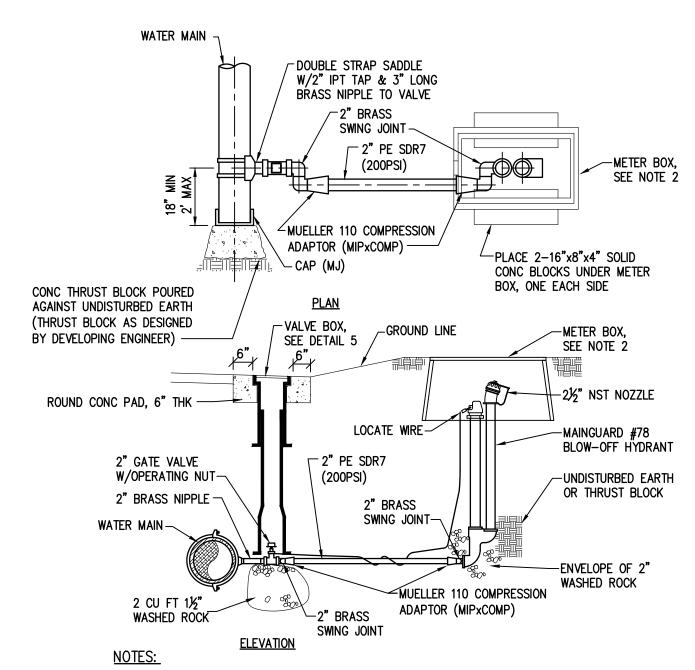
NOTE: CONTRACTOR SHALL RESTORE ALL DISTURBED AREAS BEYOND THE SCOPE OF THE ROADWAY AND SHOULDER IMPROVEMENTS TO THEIR EXISTING CONDITION OR BETTER. HYDROSEED ALL GRASS AREAS DISTURBED.



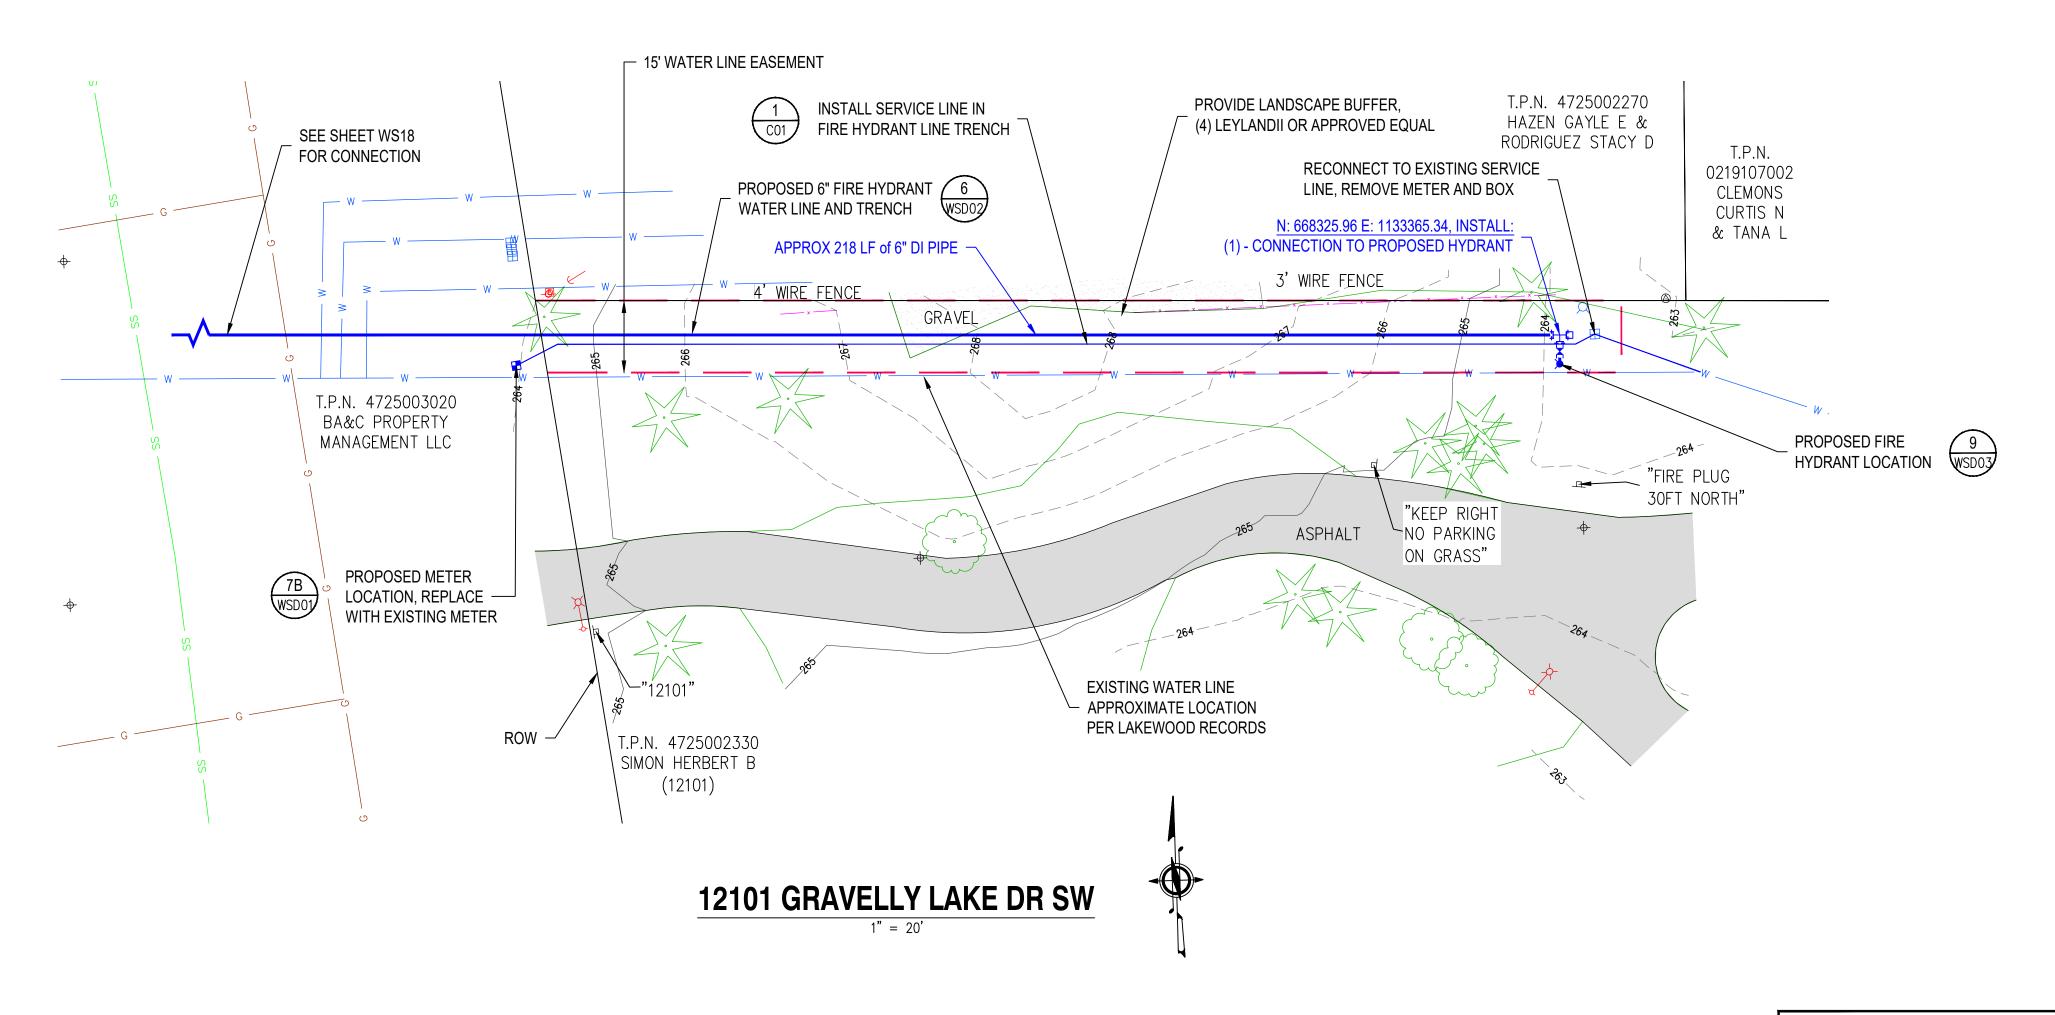- 1. BLOW-OFF HYDRANTS SHALL BE #78 MAINGUARD HYDRANT (THE KUPFERLE FOUNDRY CO).
- 2. SET UNDERGROUND IN ARMORCAST B36 W/ LID OR EQUIVALENT CARSON HD BOX & LID, (30"x17"x12").
- 3. THE OUTLET SHALL ALSO BE BRONZE AND BE 2-1/2" NST.
- 4. HYDRANTS SHALL BE LOCKABLE TO PREVENT UNAUTHORIZED USE.
- 5. LOCATE WIRE SHALL BE 10 GAUGE WIRE FROM 2" GV TO METER BOX W/ 6" MIN EXPOSED WITHIN BOX.
- 6. THRUST BLOCKS TO BE DETERMINED BY LWD INSPECTOR.









# **NOTES**

EXACT LOCATION FOR FIRE HYDRANT AND METER SHALL BE DETERMINED BY LAKEWOOD WATER DISTRICT INSPECTOR.

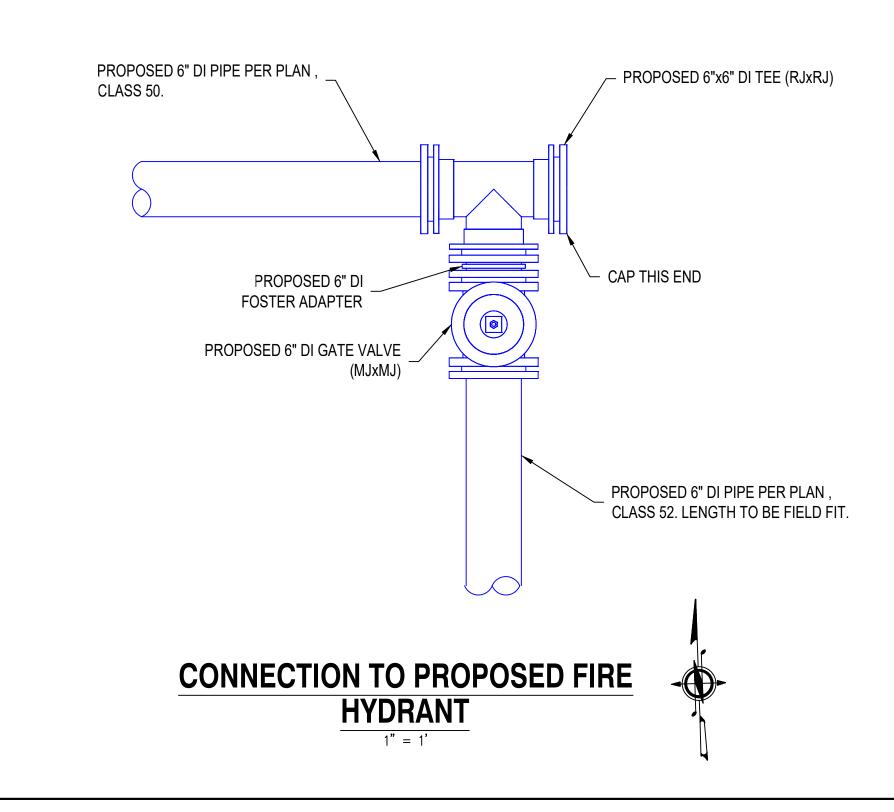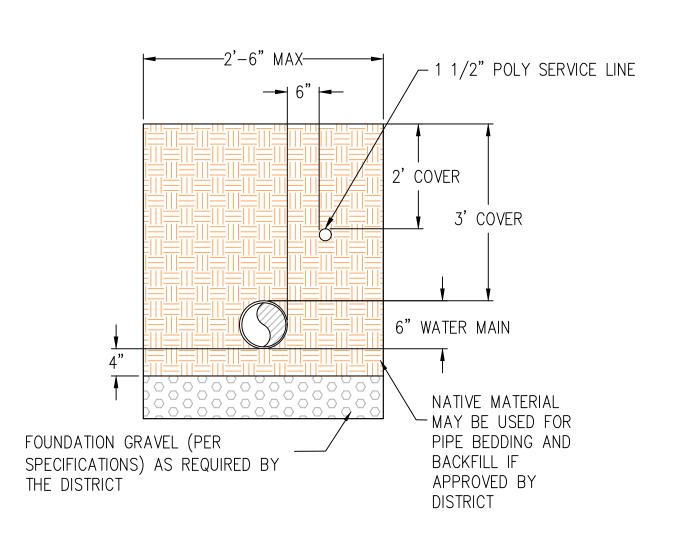IN LIEU OF FLANGES ON DUCTILE IRON FITTINGS AND VALVES, FOSTER ADAPTORS MANUFACTURED BY INFACT CORPORATION, OR APPROVED EQUAL, WILL BE USED TO ALLOW MECHANICAL JOINT RESTRAINT.






JOINT TRENCH SECTION





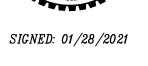



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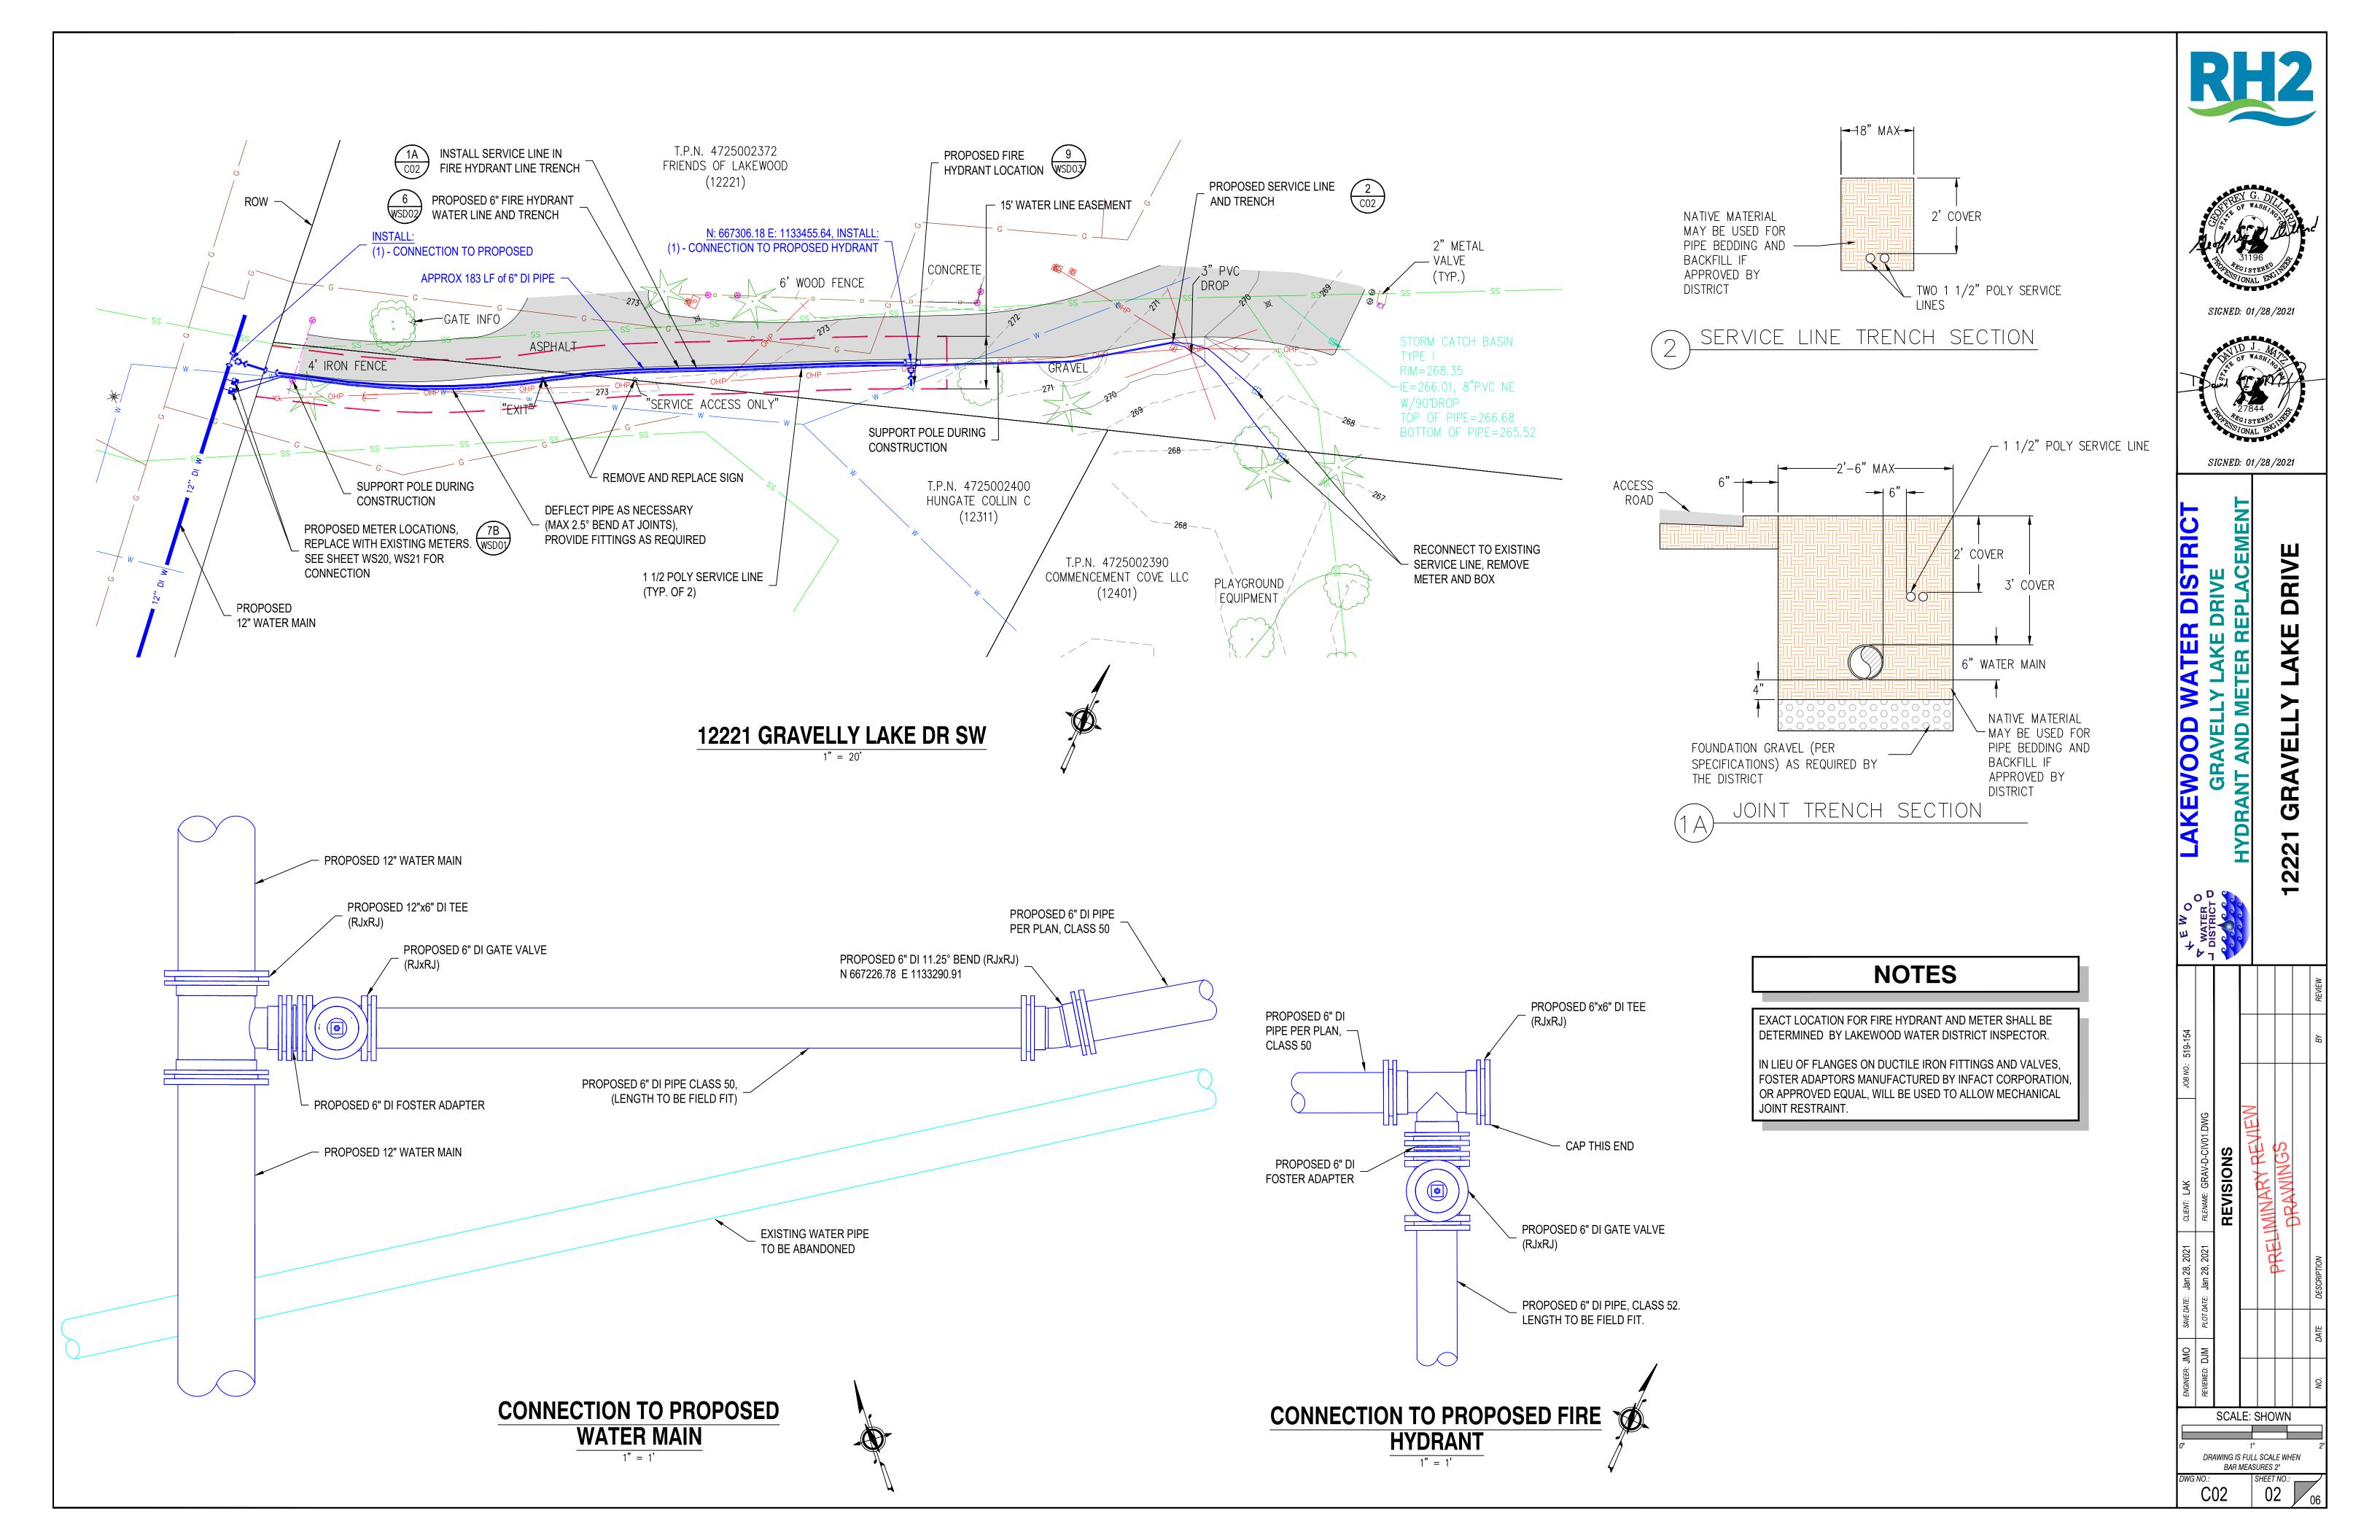
DRIVE GRAVELLY LAK
HYDRANT AND METER **GRAVELLY** 

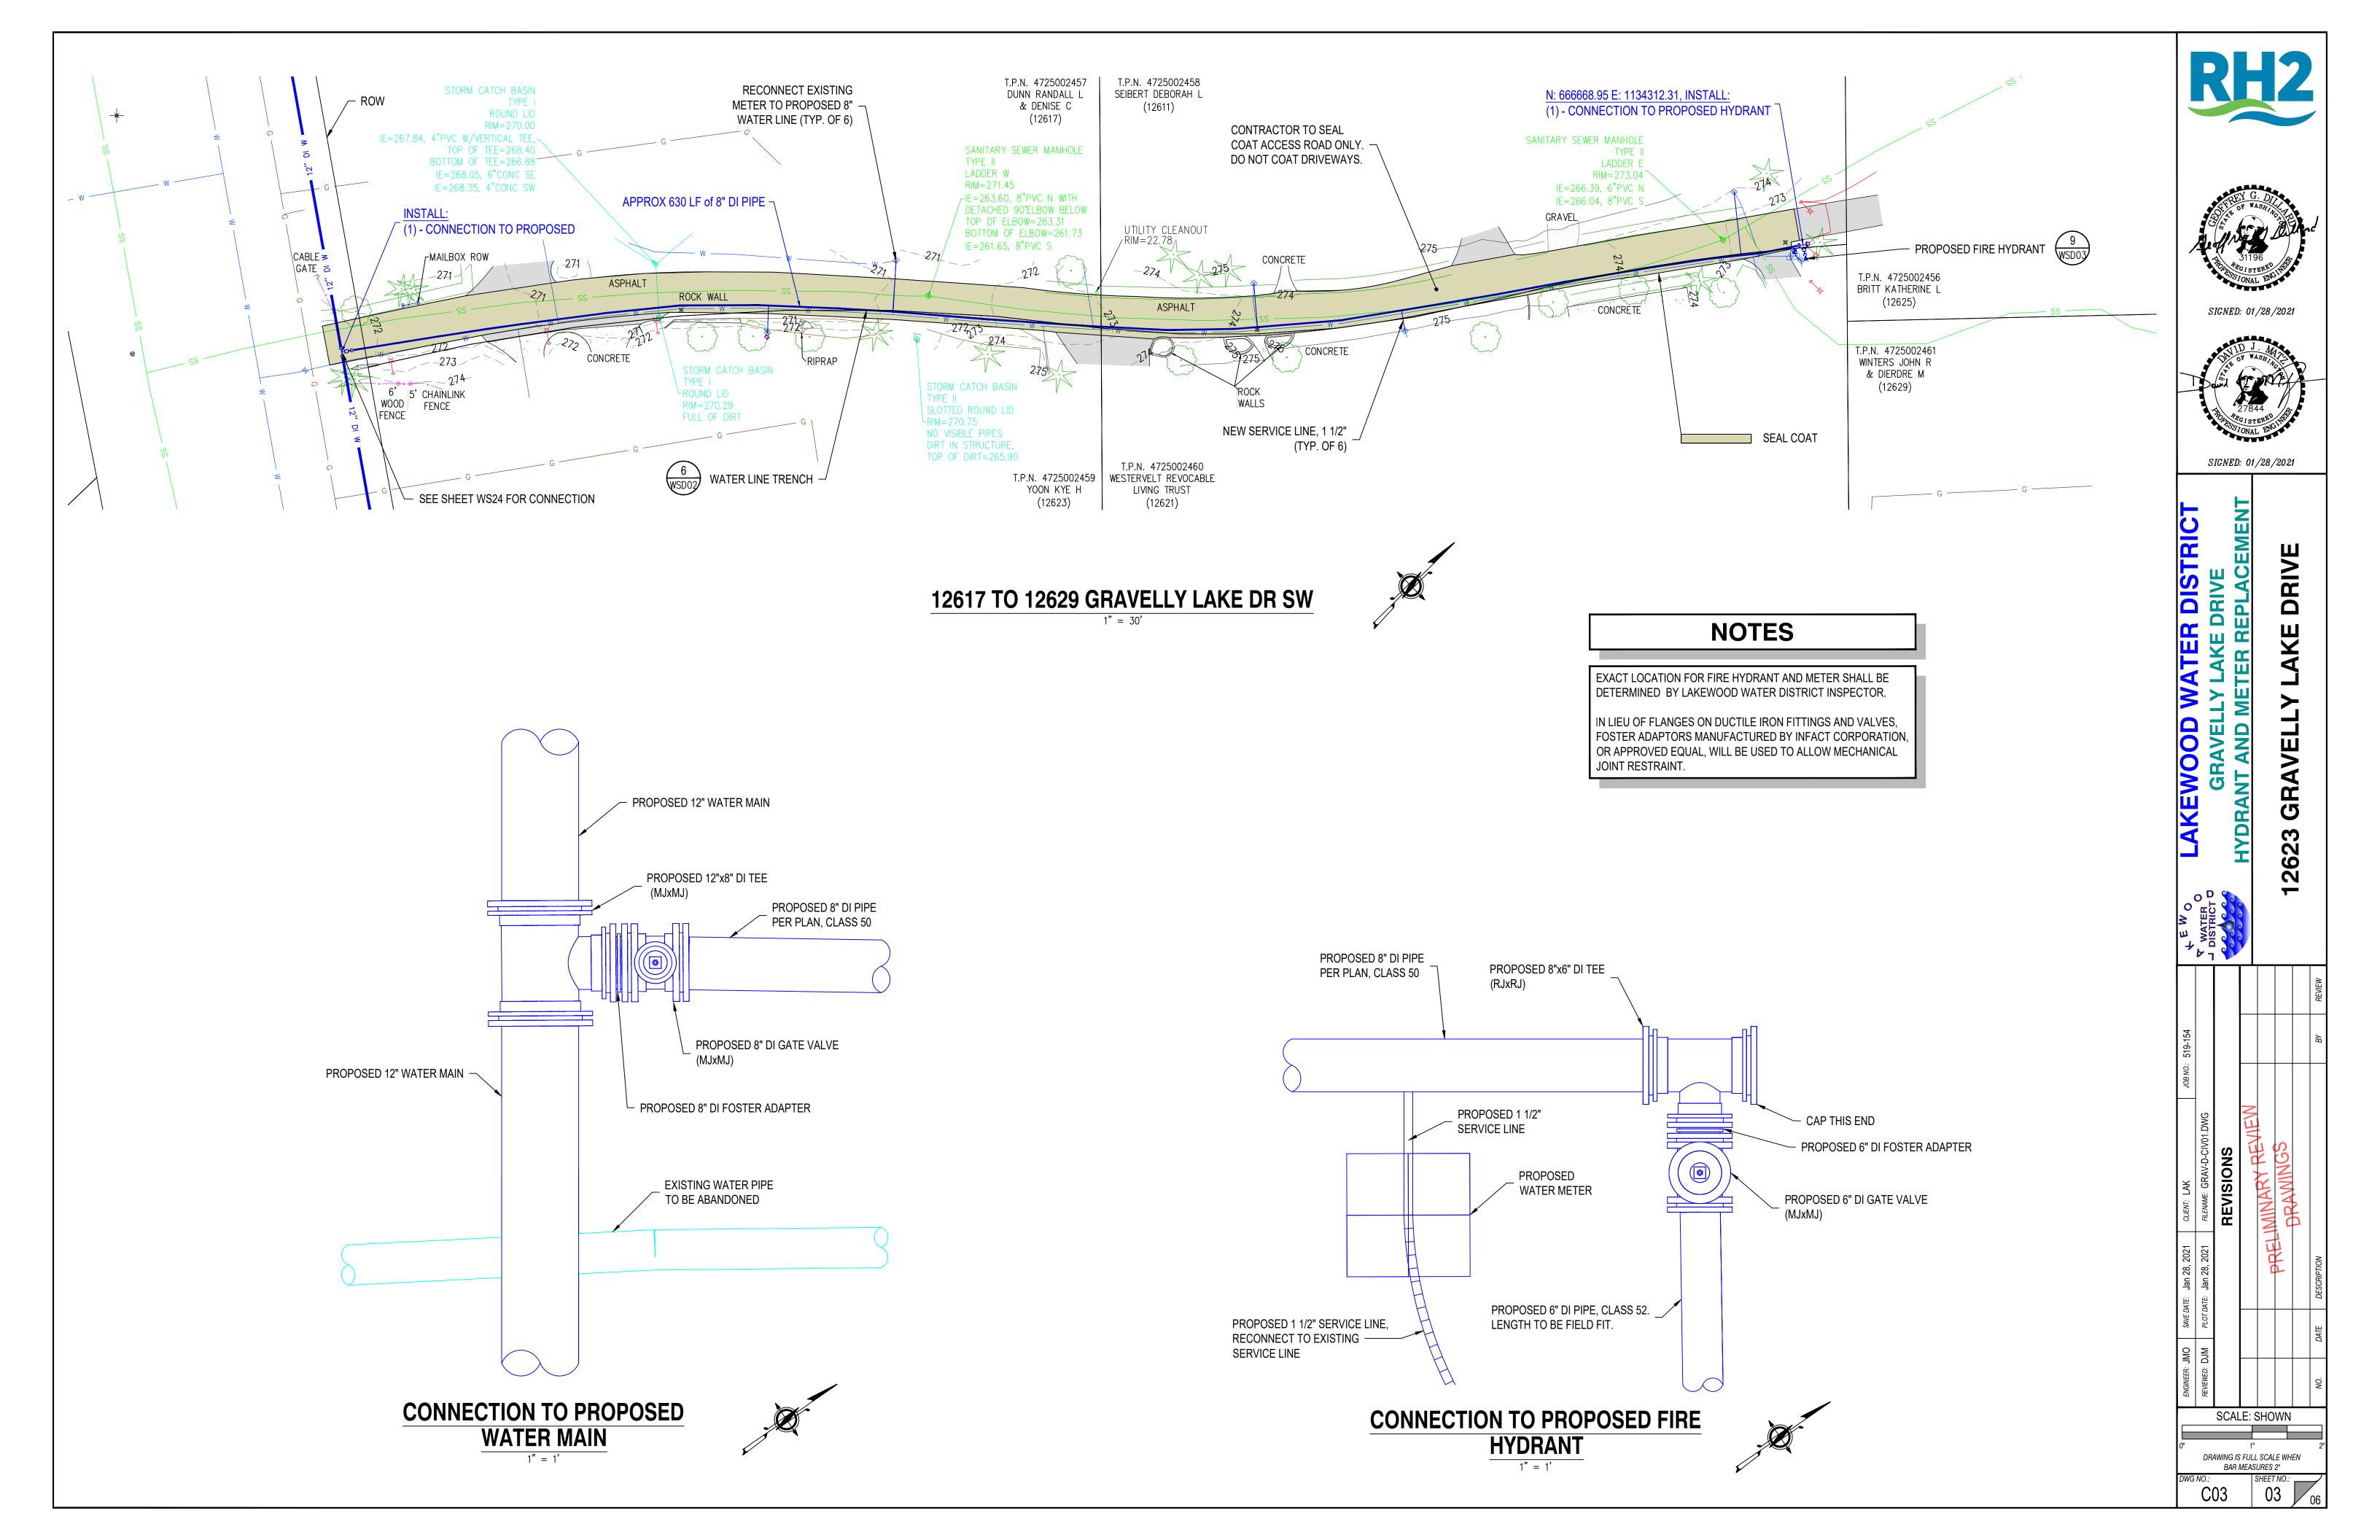
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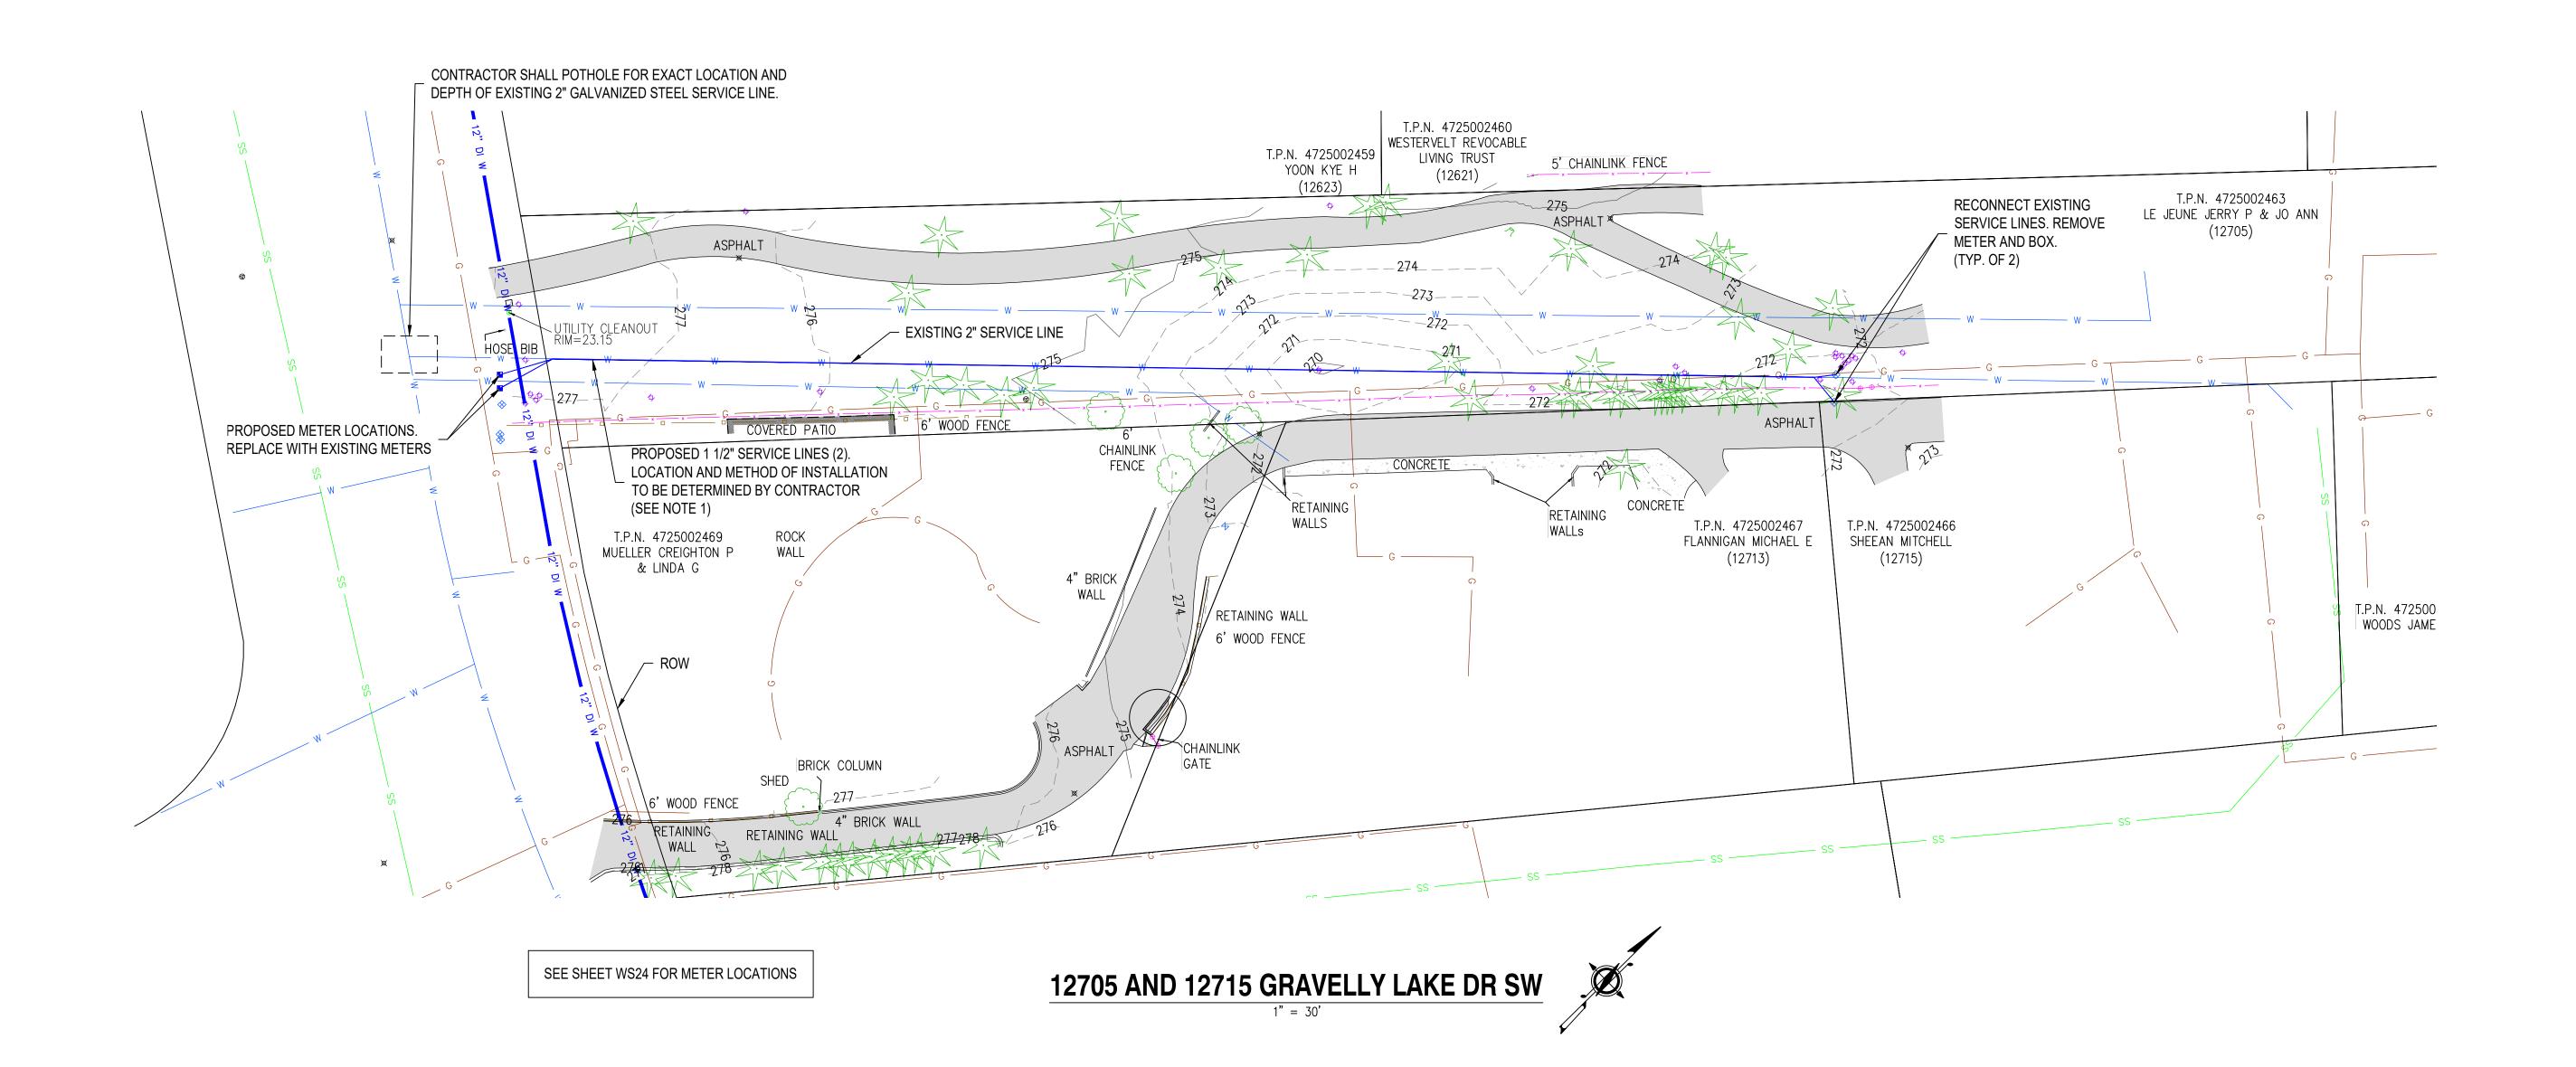
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# **NOTES**

- 1) CONTRACTOR SHALL INSTALL NEW 1 1/2" HIGH DENSITY POLYETHYLENE (HDPE, OR APPROVED EQUAL) LINE SERVICES TO 12705 AND 12715 EXISTING METER LOCATION BY EITHER DIRECTIONAL DRILLING, PIPE BURSTING (EXISTING 2" LINE) OR APPROVED CONSTRUCTION METHOD.
- 2) CONTRACTOR SHALL PROVIDE TEMPORARY OVERLAND SERVICE (MIN 2" DIAMETER) TO 12705 AND 12715 CONNECTIONS PRIOR TO ANY SERVICE DISRUPTION. MUST MAINTAIN WATER SERVICE TO CUSTOMERS AT ALL TIMES.
- 3) CONTRACTOR MUST NOTIFY LWD AND PROPERTY OWNERS 48 HOURS PRIOR TO ANY WORK ON THEIR PROPERTY.
- 4) 12705 HAS AN EXTENSIVE LANDSCAPE IRRIGATION SYSTEM THROUGHOUT PROPERTY. LINES HAVE NOT BEEN SHOWN. EXACT LOCATION OF LINES IS UNKNOWN.
- 5) EXACT LOCATION FOR METER SHALL BE DETERMINED BY LWD INSPECTOR.





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M PLOT DATE: Jan 28, 2021 CLIENT: LAK JOB NO:: 519-154

REVISIONS

REVISIONS

PRELIMINARY REVIEW

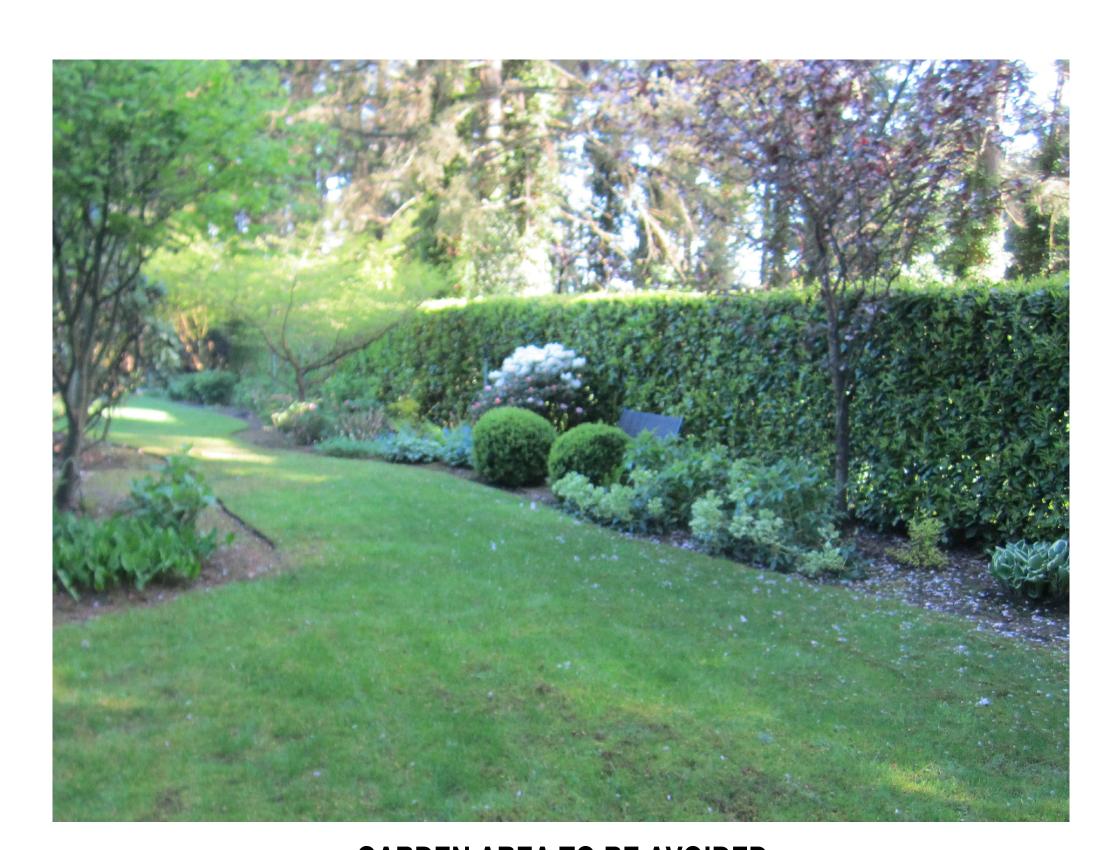
PARELIMINARY REVIEW

BAY REVIEW

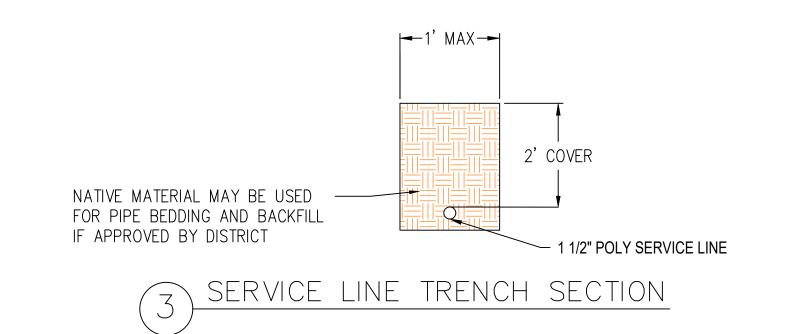
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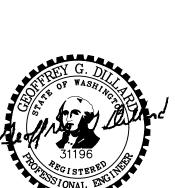
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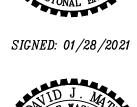



GARDEN AREA TO BE AVOIDED









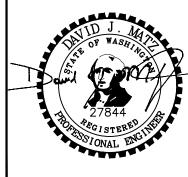

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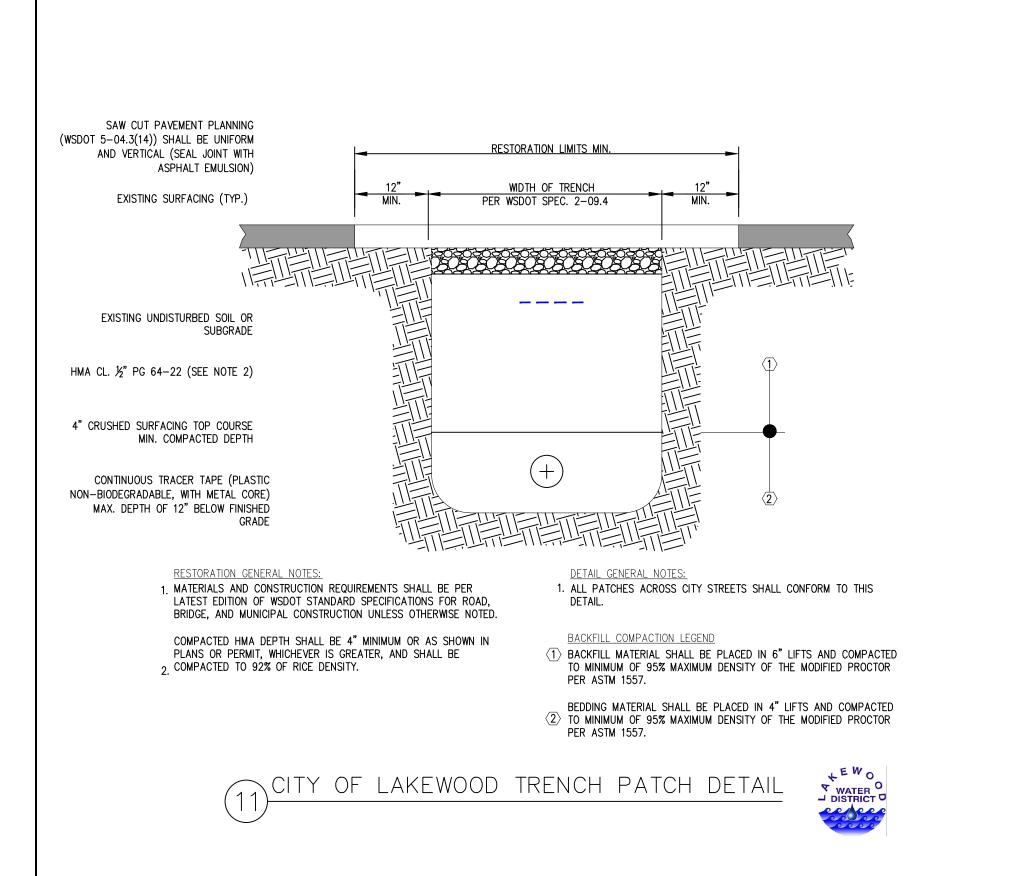
ACEMENT


DRANT AND METER REPLACEM

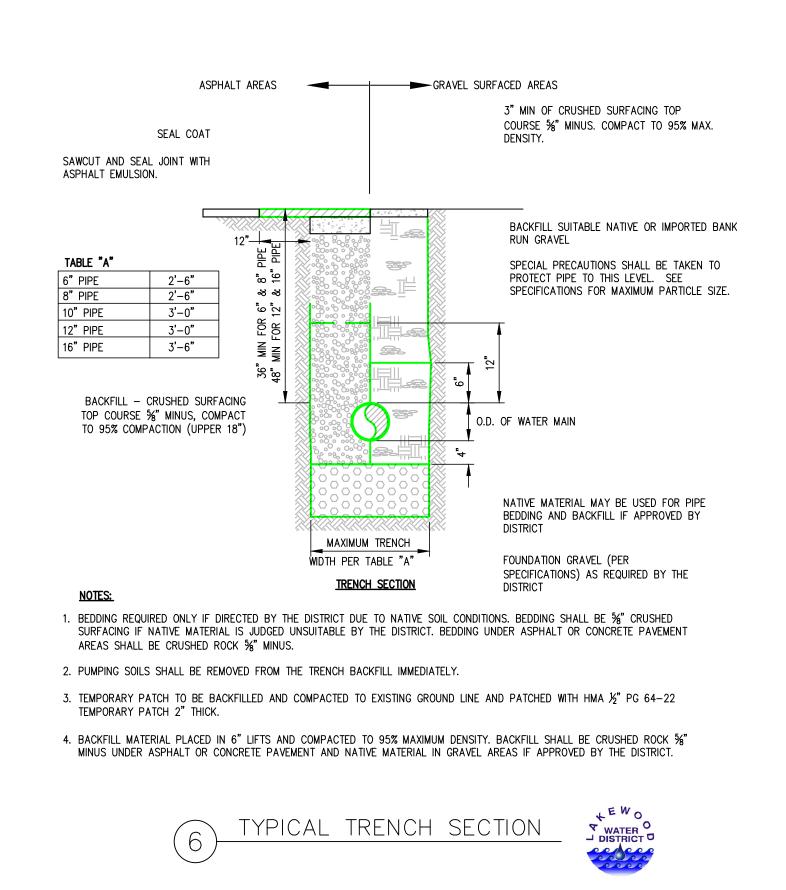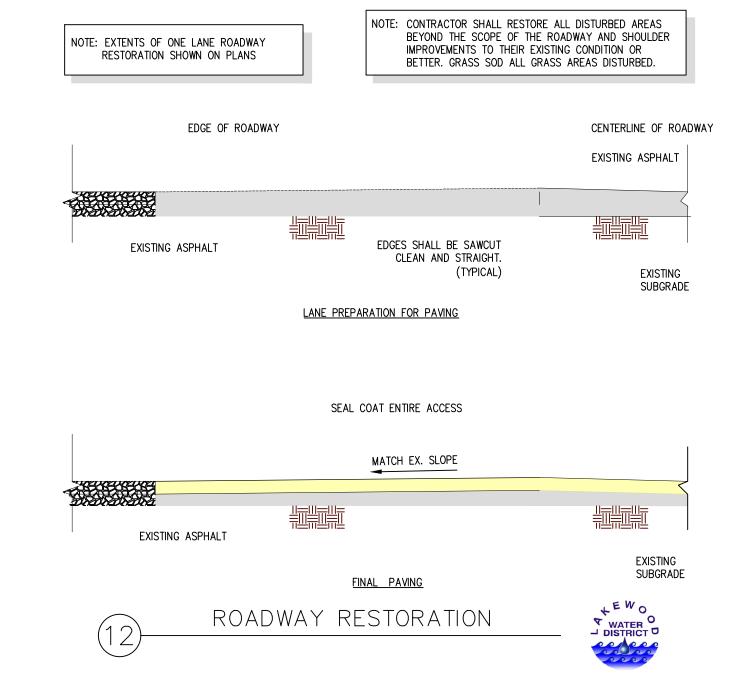
3 GRAVELLY LAKE DRIVE

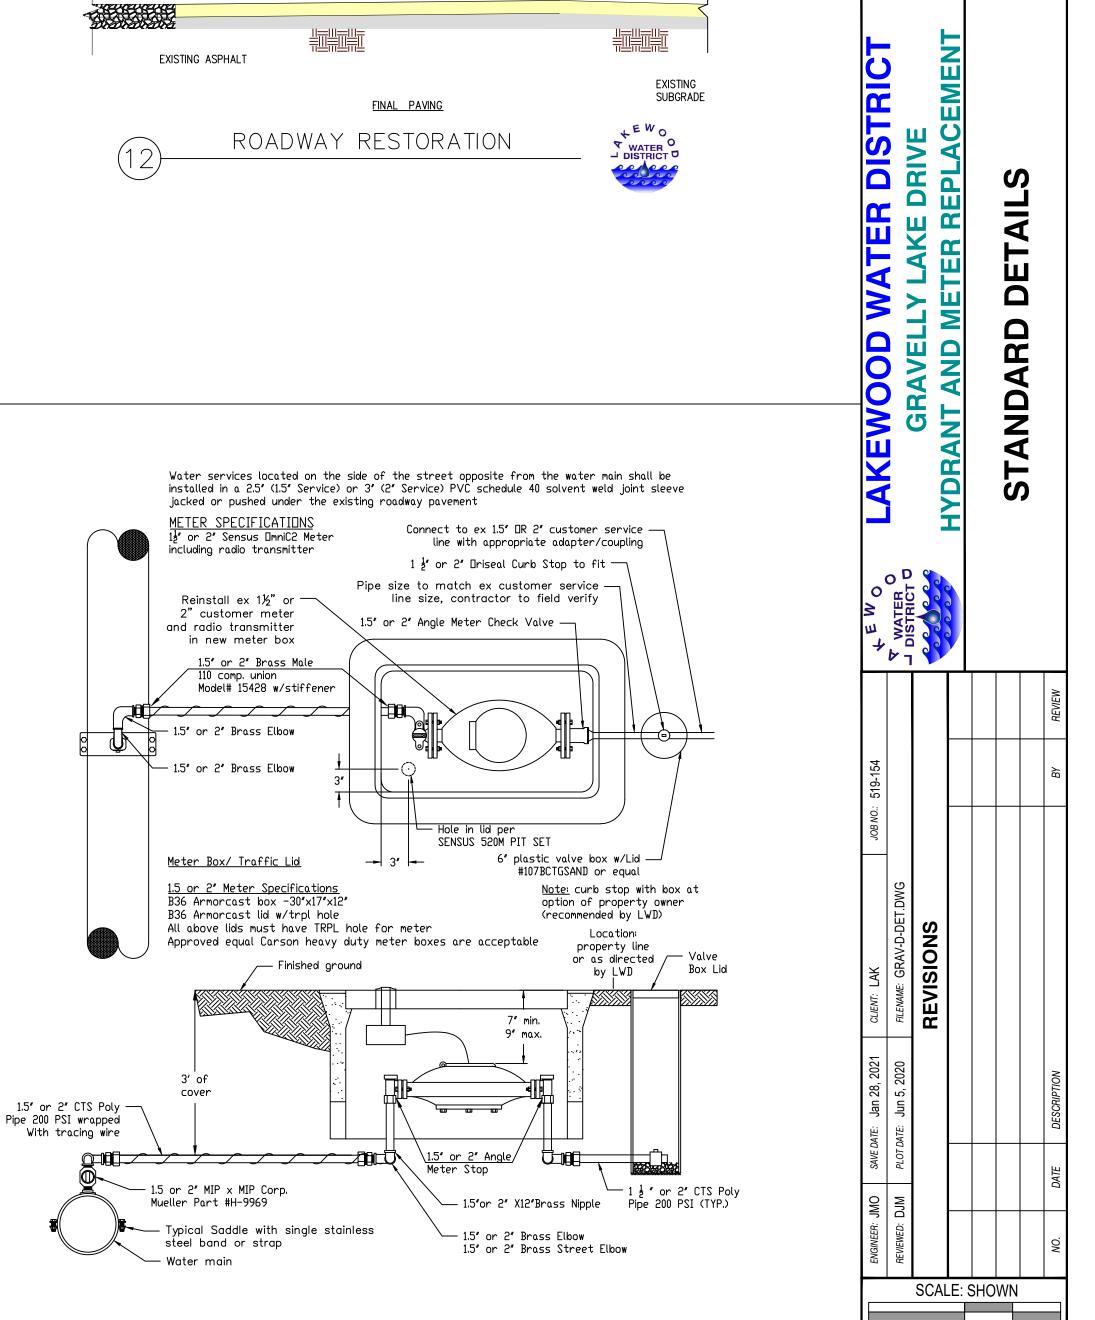
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JOB NO.: 519-154							
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ENGINEER: JMO	REVIEWED: DJM						NO.
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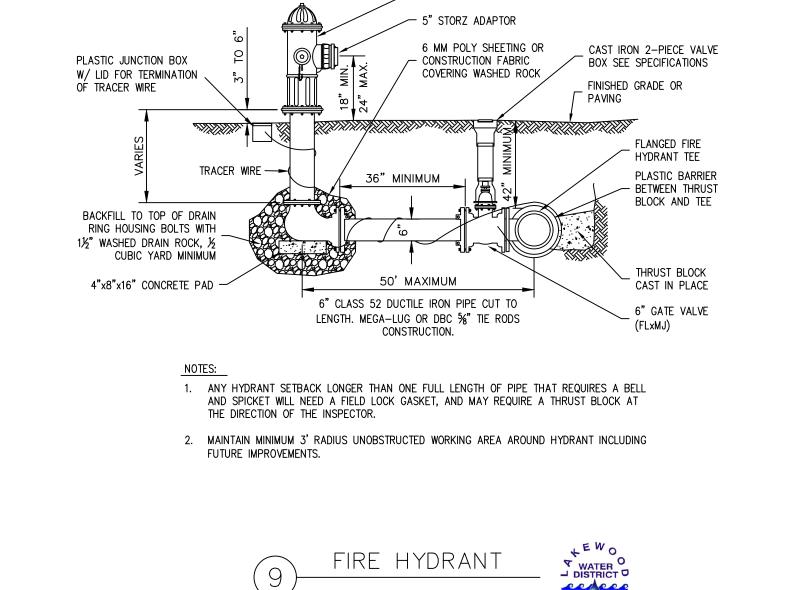


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