BCRA 2106 Pacific Avenue, Suite 300 Tacoma, Washington 98402 (253) 627-4367

Wards Lake Park Phase 1 & 2 Improvements

City of Lakewood Parks and Recreation

ADDENDUM NO. 1

November 13, 2024


This Addendum forms a part of the Contract Documents and modifies the original Contract Documents dated October 29, 2024 as noted below. Acknowledge receipt of this Addendum In the space provided on the Bid Form. Failure to do so may subject Bidder to disqualification.

This Addendum is issued to all known Plan Holders.

This Addendum consists of [4] pages plus attachments.

ATTACHMENTS

NOTE: Addendum changes to the Drawings are issued on full size drawing sheets; these changes are noted by a cloud drawn around the change and a revision number in a triangle as follows:

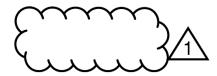

- 1. Revised Bid Form (2 pages)
- 2. Revised Specification Section 31 1000 Site Clearing (6 pages)
- 3. Revised Specification Section 32 3300 Site Furnishings (10 pages)
- 4. Revised Drawing Sheet C-510 (1 page)
- 5. Revised Drawing Sheet C-512 (1 page)
- 6. Revised Drawing Sheet L-102 (1 page)
- 7. Revised Drawing Sheet L-102.1 (1 page)
- 8. Revised Drawing Sheet L-103 (1 page)
- 9. Revised Drawing Sheet L-103.1 (1 page)
- 10. Revised Drawing Sheet L-104 (1 page)
- 11. Revised Drawing Sheet L-104.1 (1 page)
- 12. Revised Drawing Sheet L-109.1 (1 page)
- 13. Revised Drawing Sheet L-110 (1 page)
- 14. Revised Drawing Sheet L-111 (1 page)
- 15. Revised Drawing Sheet L-112 (1 page)
- 16. Boundary and Topographic Survey (6 pages)

QUESTIONS AND CLARIFICATIONS

1. The project shall comply with WSDOT Standard Specification 1-08.1 with relation to self-performance requirements.

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- 2. There is no mandatory or aspirational percentage goal for inclusion of DBE/MBE/WBE/SBE participation.
- 3. No CAD files will be provided, bidding and construction will be based off of the Contract Documents.
- 4. The boundary and topographic survey has been included with this addendum.
- 5. All proposed work is taxable.
- 6. The bird blind will be contractor furnished and contractor installed. Vector files will be provided to the Contractor, detailing the artistic cutouts, prior to construction. No specific method of fabrication of the panels is required but the finished product should contain clean and crisp cutouts and not result in the discoloration of the metal.
- 7. The pump track shall be precast concrete and conform to the specifications provided in section 32 3300 2.02.B.
- 8. Detail 6 on Sheet C-501 shall apply to the protection of existing trees onsite to be protected and preserved.
- 9. No modification to the bid opening date or time is proposed.

SPECIFICATIONS

BID FORM

REVISE Completion Time paragraph one to read,

"Bidder agrees to achieve Substantial Completion in accordance with the Contract Documents within <u>280</u> calendar days from the date provided on the Physical Notice to Proceed letter and Final Completion shall be achieved within 30 calendar days from Substantial Completion."

REVISE Physical Notice to Proceed to read,

"The Physical Notice to Proceed will be issued on Monday, September 3, 2024."

SECTION 31 1000 - SITE CLEARING

SUPPLEMENT 3.05.C with the following sections,

"1. The Contractor shall familiarize themselves with the site prior to the commencement of construction to accurately assess debris present onsite.

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2. The clearing of debris shall be performed throughout the course of construction, as needed, at the Contractor's expense."

SECTION 32 3300 - SITE FURNISHINGS

REPLACE 2.02.B.2.c. with the following,

"c. Precast reinforced C35/45 concrete with sandblasted and Sika impregnated riding surface."

REMOVE 2.02.B.2.d

REMOVE 2.02.B.2.e

SUPPLEMENT 2.02.D.b with the following section,

"9) Panel shall be 24" x 36" and a minimum of 1/2" in thickness."

DRAWINGS

(This narrative includes a brief description of addendums items. All clouded items on the addendum sheet to be included in the project bid.)

SHEET C-510 - CIVIL DETAILS

REVISE detail 1 to remove the reference to powder coating finish

SHEET C-512 - CIVIL DETAILS

REVISE detail 1 to clarify post connection details and remove the reference to powder coating finish.

SHEET L-102 - LANDSCAPE PLAN

REVISE plans to provide Bid Additive 03 delineation.

SHEET L-102.1 - NOTES & SCHEDULES

REVISE plant symbol in legend.

SHEET L-103 - LANDSCAPE PLAN

REVISE plans to provide Bid Additive 03 delineation.

SHEET L-103.1 - NOTES & SCHEDULES

REVISE plant symbol in legend.

SHEET L-104 - LANDSCAPE PLAN

REVISE plans to provide Bid Additive 03 delineation.

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SHEET L-104.1 - NOTES & SCHEDULES

REVISE plant symbol in legend.

SHEET L-109.1 - NOTES & SCHEDULES

REVISE plant symbol in legend.

SHEET L-110 - SCH A - NOTES & MASTER SCHEDULES

REVISE plant symbol in legend.

SHEET L-111 - SCH B - NOTES & MASTER SCHEDULES

REVISE plant symbol in legend.

SHEET L-112 - BID ADDITIVE MASTER PLANT LIST

REVISE plant symbol in legend.

Approved Substitutions:

The following manufacturers are acceptable subject to their ability to provide products conforming to the requirements of the Drawings and Specifications. (Inclusion in this list does not necessarily constitute approval of these manufacturer's <u>standard</u> products.)

Section	Item	Manufacturer(s) Approved
N/A	None	N/A

END OF ADDENDUM NO. 1

BID FORM

TO: City of Lakewood, City Clerk's Office

ADDRESS: 6000 Main Street SW, Lakewood, WA 98499-5027

PROPOSAL TO LAKEWOOD CITY COUNCIL, LAKEWOOD, WASHINGTON

PROJECT: Wards Lake Park Phase 1 & 2 Improvements

City Project No. 301.0020

Bidder			
Address			
Date			
Contractor's State L	ic. #		

Bidders Declaration of Understanding

The Bidder, in compliance with the City's Advertisement for Bids and Instructions for Bidders for Wards Lake Park Phase 1 & 2 Improvements having examined the specifications, drawings, related documents, and the site of the proposed work, and being familiar with all of the conditions surrounding the work of the proposed project including the availability of material and labor, hereby proposes to furnish all labor, materials, tools, expendable equipment, affidavits of prevailing wages paid, utility and transportation services, and incidentals, necessary to perform the complete contract, in a workmanlike manner, and as required by and in strict conformance with the Project Manual, Addenda and Plans, all for the rates and lump sum prices listed below. These prices shall cover all expenses incurred in performing the work required under the contract documents, for which this bid is a part.

The City will award the project based upon the lowest responsive bidder total of Base Bid.

Completion Time

Bidder agrees to achieve Substantial Completion in accordance with the Contract Documents within <u>280</u> calendar days from the date provided on the Physical Notice to Proceed letter and Final Completion shall be achieved within 30 calendar days from Substantial Completion.



Procurement Notice to Proceed,

The Contractor shall begin construction planning and procure materials within ten (10) calendar days after receipt of Procurement Notice to Proceed. Physical work on the Project Site shall not occur till the Physical Notice to Proceed is issued to the Contractor.

Physical Notice to Proceed

The Physical Notice to Proceed will be issued on Monday, January 6, 2024.



Over-Water Work

The Over-Water Work is required to be completed in accordance with and within the work window provided in the projects Hydraulic Permit Approval (HPA), included in the appendix of these Contract Documents.

Liquidated Damages

It is further understood and agreed that the City may deduct liquidated damages from payments due or to become due the Contractor in the amount set forth in WSDOTTSS Section 1-08.9 for each working day in

excess of the Two Hundred Eighty (280) calendar days stipulated in the paragraph above.

It is agreed that liquidated damages, in the amount of $\underline{\$2,200.00}$, shall be levied for each and every calendar day by which the completion of the work is delayed beyond the time fixed for Substantial Completion or extension of the contract date.

The liquidated damages do not include, and are in addition to, damages from the costs for legal expense, administrative and court costs incurred beyond contract completion date. The cost of additional administrative surveillance, legal expense, and court costs beyond contract completion date shall be billed the contractor at standard billing rates for said services then in effect.

Prevailing Wages

This Project is subject to Prevailing Wages. The Bidder agrees to pay to labor not less than the hourly minimum rates of wages and fringe benefits determined by the State of Washington Department of Labor and Industries or, if applicable, the U.S. Secretary of Labor, whichever is the higher rate.

Change Orders

Written "Change Orders" will be issued formalizing and authorizing changes.

SECTION 31 1000

SITE CLEARING

PART 1 GENERAL

1.01 RELATED DOCUMENTS

- A. Drawings and general provisions of the Contract, including General Conditions, Supplementary Conditions and Divisions 00 and 01 Specification Sections, apply to work of this section
- B. Refer to Section 00 3100 for the following related reports available to bidders:
 - Geotechnical Engineering Services for Phase 1 and Phase 2 by GeoEngineers, dated November 14, 2022 and January 30, 2024 for information on existing site conditions. Report is included for reference only related to existing site and soil conditions. Specific requirements related to the site and soils requirements for this project are shown on the Drawings and included in the Project Manual.
 - 2. Construction Stormwater Pollution Prevention Plan prepared by BCRA, dated March 7, 2024.

1.02 SECTION INCLUDES

- A. Tree and Shrub Removal.
- B. Stripping and Removal of the following:
 - 1. Topsoil.
 - 2. Sod.
 - Debris.
 - 4. Organic-Bearing Topsoil.
- C. Removal of Existing:
 - 1. Asphalt Pavement.
 - Concrete Pavement.
 - 3. Concrete Curbs.
 - Miscellaneous Concrete Elements.

1.03 PROJECT CONDITIONS

- A. Contractor is responsible for visiting the site prior to bid to understand the site conditions and scope of clearing work required to accommodate the work of this project.
- B. Conform to applicable regulations relating to environmental requirements and disposal of debris.
- C. On-site burning of site clearing debris is not allowed.
- D. Existing site subgrade soils may be moisture sensitive. Operating equipment on subgrade that has moisture content over optimum for achieving specified compaction could result in a soft, mushy subgrade that will require drying out and recompaction or excavation and removal from the site at Contractor's expense. It shall be the contractor's responsibility to schedule work to be accomplished when weather and site conditions are dry and take any measures necessary to protect site soils from becoming unusable or over optimum moisture content or import suitable materials.
- E. Control the flow, collection, channeling and discharge of water on site to prevent damage to subsoil and excavations, to prevent off-site damage of any type and to conform to all ordinances and laws. Do not allow water to stand in any area where the building or pavement is to be constructed.
- F. Protect above and below-grade utilities, refer to Section 02 1725 for requirements related to existing utilities.
- G. Tree and Shrub Protection: Protect existing trees and shrubs not scheduled for removal from damage during clearing and grubbing work.
- H. Existing Improvements: Provide protection necessary to prevent damage to existing improvements not indicated for removal. Restore damaged improvements to their original condition.
- I. Protect bench marks, survey control points, existing structures, sidewalks, paving and curbs from excavating equipment and vehicular traffic.
- J. Traffic: Conduct site clearing operations to ensure minimum interference with roads, streets, walks and other adjacent occupied or used facilities.

1.04 SAFETY CONSIDERATIONS

- A. The Contractor is solely responsible for developing a safety plan to protect workers and the public from injury or harm conforming to all Local, State and Federal requirements and for executing and enforcing it on the Project site.
 - 1. Contractor shall consult with their own Geotechnical Engineering expert for determining soil classification relative to safe sloping of soils.

- 2. Determine safe excavation and dewatering methods, monitor excavations and earthwork operations for safety concerns and provide shoring and other protection as required to protect workers.
- 3. It is not the intent of the Construction Documents to dictate any unsafe construction means or methods; determine means and methods of construction conforming to their safety plan as required to construct work shown on the Contract Documents.

1.05 DOMESTIC PRODUCTS

A. Products shall comply with the requirements of the "Build America, Buy America Act", term effective as of January 13, 2023; refer also to RCO Grant Agreements included in the appendices of the Project Manual for additional information.

PART 2 PRODUCTS

2.01 NOT USED

PART 3 EXECUTION

3.01 COORDINATION

A. Review, coordinate and accommodate work of other sections that interface with, affect or are affected by the work of this section so as to facilitate the execution of the overall work of this project in a coordinated and efficient manner.

3.02 PROTECTION PRIOR TO SITE CLEARING

- A. Do not start any clearing work until installation of erosion and sediment control provisions specified in Section 31 2500 Erosion and Sediment Control, the Stormwater Pollution Prevention Plan Report and as shown on the Drawings, have been installed.
 - Monitor water runoff from the site continuously during clearing work and implement any temporary erosion and sediment control measures on-site to mitigate / prevent turbid water runoff from leaving the site in conformance with Washington State Department of Ecology and City of Lakewood regulations.
- B. Locate, identify and protect existing underground and overhead utilities from damage, refer to Section 02 1725 for requirements regarding existing utilities. Pothole utilities to verify location. Existing utilities shall be located and marked in the field before the Contractor begins excavating.
- C. Tree and Shrub Protection: Prior to start of any work flag each existing tree and shrub in the vicinity of the clearing area that is not scheduled for removal and install 6-inch wide construction ribbon around each tree / shrub.

D. Protect benchmarks, survey control joints and existing structures from damage or displacement. Said benchmark or control points shall be restored by a Professional Land Surveyor licensed to practice in the State of Washington, in accordance with standard of professional practice and State regulations.

3.03 PREPARATION

A. Lay out the limits of disturbance accurately on the site and mark clearly for maximum visibility by equipment operators during clearing operations.

3.04 CLEARING AND GRUBBING

- A. Remove trees, stumps and shrubs within limits of disturbance, unless otherwise noted. Remove main root balls, tap roots and root systems, including those that extend deeper than topsoil stripping depths.
- B. Clear all vegetation and deadwood, including roots within the limits of disturbance, unless otherwise noted.
- C. Remove invasive plant species on within the limits of disturbance.
 - 1. Invasive species include: English Holly, English Ivy, Himalayan Blackberry, English and Portuguese Laurel, Scotch Broom.
 - 2. Refer to Invasive Species Management Plan prepared by Bartlett, dated April 01, 2022, included in the appendicies of the Project Manual for removal guidance.
- D. Where existing trees are indicated to remain, stop topsoil stripping at the tree dripline or further distance away to prevent damage to the root system.
- E. Dispose of removed materials offsite at a Contractor provided and permitted disposal site.
- F. Open burning of waste material is not allowed.
- G. Asphalt / concrete pavement within the limits of disturbance, as indicated on the Drawings, shall be removed down to subgrade.

3.05 STRIPPING AND REMOVAL

- A. Strip off and remove a minimum of 6-inches of all sod and organic topsoil to limits of grading exposing undisturbed native subgrade soil that is free of any organic material including roots.
 - 1. Coordinate with geotechnical report recommendations. Stripping depth may exceed 6 inches in some instances.

B. Topsoil may be stockpiled on-site for re-use as fill in landscaping areas if it meets the definition of Satisfactory Fill per Section 31 2000 - Earthwork. Topsoil may also be stockpiled and amended to meet soil restoration requirements with approval by the Landscape Architect after review of a soil test. Refer to soil restoration and site preparation requirements on the Landscape Plans.

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- C. Remove exposed boulders and any debris encountered from site.
 - 1. The Contractor shall familiarize themselves with the site prior to the commencement of construction to accurately assess debris present onsite.
 - 2. The clearing of debris shall be performed throughout the course of construction, as needed, at the Contractor's expense.



A. Schedule Geotechnical Engineer to inspect the exposed subgrade soils after stripping and removal has been completed but prior to any earthwork being started. Give Engineer at least 3 days advanced notice for each site visit.

- 1. Geotechnical Engineer shall inspect subgrade soils and determine if they are free of organic material and suitable for earthwork to proceed.
- 2. If Geotechnical Engineer determines that any subgrade soils still contain organic material or are otherwise unsuitable, strip off and remove the unsuitable soils as required by Geotechnical Engineer.

3.07 PROTECTION AFTER SITE CLEARING

- A. Protecting Subgrade:
 - 1. Protect newly exposed subgrade from damage due to water, traffic, freezing and erosion. Plan work so that subgrade is not left open and exposed to wet weather and construction traffic.
 - 2. Contractor is responsible for planning and overseeing the work so that exposed subgrade is protected from becoming soft, yielding or unsuitable after being exposed, requiring over-excavation and structural fill.
- B. Utilities: Refer to Section 02 1725 for requirements related to existing utilities. The Contractor shall protect all private and public utilities from damage. Adequate provisions shall be made for maintaining all electrical and other underground facilities encountered during construction. Structures which have been disturbed or damaged by the Contractor shall be satisfactorily restored, unless shown for demolition, upon completion of the work.
- C. Pavement: The Contractor shall protect from damage all street pavement or paved areas on streets leading to site.



- D. Access Streets and Roadways: Provide wheel cleaning stations to clean wheels and undercarriage of trucks before leaving site, as necessary, to prevent dirt from being carried onto public streets. If streets are fouled, they must be cleaned immediately in conformance with the City of Lakewood, Washington State Department of Ecology and all governing requirements and regulations.
- E. Repair and / or replacement of damaged facilities shall be accomplished at the Contractor's expense.

3.08 CLEAN-UP

- A. Remove any dirt and debris from streets and pavements, dry sweep affected areas clean.
- B. Clean out and remove any dirt, silt or debris that is carried offsite or into any storm drainage system by water runoff resulting from clearing work on this site.
- C. Shape earthwork to blend naturally into surroundings.

3.09 FIELD QUALITY CONTROL

- A. Contractor Quality Control: Employ / assign quality control personnel to monitor the work of this section for conformance to the requirements of the Contract Documents and to good construction practices.
 - 1. Contractor is solely responsible for managing and controlling the quality of the work and conformance with the requirements of the Contract Documents.

END OF SECTION

SECTION 32 3300

SITE FURNISHINGS

PART 1 GENERAL

1.01 RELATED DOCUMENTS

A. Drawings and general provisions of the Contract, including General Conditions, Supplementary Conditions and Divisions 00 and 01 Specification Sections, apply to work of this section

1.02 SUMMARY

- A. General: All site furnishings shall be constructed and installed as shown on drawings and per manufacturer's recommendations.
- B. Workmanship: Workmanship shall be of acceptable quality and performed to the satisfaction of the Owner's Representative.

1.03 SECTION INCLUDES

- A. Trash / Recycling Receptacles.
- B. Site Benches.
- C. Site Picnic Tables, Cluster Seating.
- D. Site Picnic Tables, Bench Style.
- E. Site Bicycle Racks.
- F. Pet Waste Receptacle
- G. Water Pump.
- H. Drinking Fountain
- I. Precast Cement Concrete Pump Track.
- J. Non-Slip Treads.
- K. Park Map

1.04 REFERENCES

- A. References shall be the edition current as of the date of the Contract Documents.
- B. ADA Standards 2010 ADA Standards for Accessible Design.

1.05 SUBMITTALS

- A. Refer to Section 01 3300 for submittal procedures.
- B. Product Data: Submit manufacturer's product literature describing each product, features and options. Include manufacturer's installation instructions.
- C. Submit shop drawings for all items requiring fabrication and/or assembly.

1.06 DELIVERY, STORAGE AND HANDLING

A. Deliver and store in conformance with manufacturer's recommendations.

1.07 PRE-INSTALLATION CONFERENCE

- A. Prior to start of the precast cement concrete pump track installation, Contractor shall schedule a pre-installation conference at the job site to review the project conditions and installation requirements.
- B. Persons attending pre-installation conference shall include the Contractor, precast cement concrete pump track installer, earth work subcontractor, precast cement concrete pump track manufacturer's designated field service representative, Civil Engineer, and Owner Representative(s).

1.08 DOMESTIC PRODUCTS

A. Products shall comply with the requirements of the "Build America, Buy America Act", term effective as of January 13, 2023; refer also to RCO Grant Agreements included in the appendices of the Project Manual for additional information.

PART 2 PRODUCTS

2.01 OWNER-FURNISHED / CONTRACTOR-INSTALLED (OFCI) SITE FURNISHINGS

- A. Trash / Recycling Receptacle
 - 1. Manufacturer / Product: Wabash Valley, 32 *Gallon Receptacle- Diamond* (model #: LR300D).
 - 2. Specifications:
 - a. Mounting: Surface mounted.
 - b. Color: Green.

B. Site Benches

- 1. Manufacturer / Product: Wabash Valley, 6' Bench With Back #SG306D and 6' Bench Without Back #SG307D.
- Specifications:

- a. Site Bench, With Back
 - 1) Size: 6' bench.
 - 2) Style: Bench with Back
 - 3) Mounting: Surface mounted.
 - 4) Color: Green.
- b. Site Bench, Without Back
 - 1) Size: 6' bench.
 - 2) Style: Bench Without Back.
- c. Mounting: Surface mounted.
 - 1) Color: Green.
- C. Site Picnic Tables, Cluster Seating
 - 1. Manufacturer / Product: Columbia Cascade, 2056-8484-P Parkway Integral Table and Seats and 2057-8484-ADA-P Parkway Accessible Integral Table with Three Seats.
 - 2. Specifications:
 - a. Site Picnic Table, no accessibility:
 - 1) Size: 6'-11 1/2" x 6'-11 1/2".
 - 2) Mounting: Pedestal Mount.
 - 3) Finish: Black Powder Coating.
 - b. Site Picnic Table, accessibility:
 - 1) Size: 5'-1" x 4'-3 3/4".
 - 2) Mounting: Pedestal Mount.
 - 3) Finish: Black Powder Coating.
- D. Site Picnic Tables, Bench Style
 - 1. Manufacturer / Product: Wabash Valley, 6' Table #SG106D and 8' ADA Table #SG115D.
 - 2. Specifications:

- a. Site Picnic Table, no accessibility
 - 1) Size: 6' Table.
 - 2) MountingFree Standing.
 - 3) Color: Green.
- b. Site Picnic Table, accessiblity
 - 1) Size: 8' ADA Table.
 - 2) MountingFree Standing.
 - 3) Color: Green.

E. Site Bicycle Racks

- 1. Manufacturer / Product: DuMor, Inc., Bike Racks 125-30.
- 2. Specifications:
 - a. Capacity: 7 bicycles.
 - b. Size: 62 1/2" long.
 - c. Mounting: Surface Mounted.

F. Water Pump

- 1. Manufacturer / Product: Bison Pumps, Cadrom Creek Water Pump, Pump-n-Play Standard Playground Water Pump with Hand Pump and Water Tank is the basis of design and the standard of quality, function, performance and appearance required for this project.
 - a. Products by other manufacturers may be acceptable, subject to their ability to meet or exceed this standard and provide products conforming with the requirements of the Drawings and this Specification.
 - b. Substitutions: Refer to Section 01 6000 for substitution procedures and requirements. Proposed substitutions must match specified product performance and colors.

2. Specifications:

- a. Construction: Stainless Steel.
- b. Size: 53-1/2" tall from the base of the tank to the top of the handle, 40-1/8" from base of tank to bottom of spigot.

c. Connection: 3/4" pressurized water line.

G. Water Fountain

- 1. Manufacturer / Product: Most Dependable Fountains, Inc., *350 SMSS Pet Fountain*.
- 2. Specifications:
 - a. Color: Green.
 - b. Configuration: Pet Fountain

2.02 CONTRACTOR-FURNISHED / CONTRACTOR-INSTALLED (CFCI) SITE FURNISHINGS

- A. Pet Waste Receptacle
 - 1. Manufacturer / Product: Pet Waste Eliminator, Superior Pet Waste Eliminator Station (SKU: E3) is the basis of design and the standard of quality, function, performance and appearance required for this project.
 - a. Products by other manufacturers may be acceptable, subject to their ability to meet or exceed this standard and provide products conforming with the requirements of the Drawings and this Specification.
 - b. Substitutions: Refer to Section 01 6000 for substitution procedures and requirements. Proposed substitutions must match specified product performance and colors.
 - 2. Specifications:
 - a. Color: Green.
- B. Precast Cement Concrete Pump Track
 - 1. Manufacturers / Products: Parkitect; Version 3.5 Modular Cement Concrete Pump Track, layout and configuration as shown on the Contract Documents, is the basis of design and the standard of quality, function, performance, and details required for this project.
 - a. Products by other manufacturers may be acceptable, subject to their ability to meet or exceed this standard and provide products conforming to the requirements of the Drawings and Specifications.
 - b. Substitutions: Refer to Section 01 6000 for substitution procedures and requirements.
 - 2. Specifications:

- a. Track Width = 1.710 mm
- b. Precast modules shall have rounded edged to prevent chipping.
 - 1) Minimum edge radius = 45 mm.
- c. Precast reinforced C35/45 concrete with sandblasted and Sika impregnated riding surface.



C. Non-Slip Treads

- 1. Manufacturer / Product: HandiTreads, *Non-Slip Aluminum Treads* is the basis of design and the standard of quality, function, performance and appearance required for this project.
 - a. Products by other manufacturers may be acceptable, subject to their ability to meet or exceed this standard and provide products conforming with the requirements of the Drawings and this Specification.
 - b. Substitutions: Refer to Section 01 6000 for substitution procedures and requirements. Proposed substitutions must match specified product performance and colors.

2. Specifications:

- a. Material: Aluminum
- b. Finish: Black Powder Coating
- c. Dimensions: 48" long, 3.75" wide
- d. Attachment Type: Mechanical anchors
- e. Code Compliance: ADA Compliant

D. Park Map

1. Map Panel

- a. Manufacturer / Product: Fossil Industries, Inc., *CHPL Graphic Panel* is the basis of design and the standard of quality, function, performance and appearance required for this project.
 - Products by other manufacturers may be acceptable, subject to their ability to meet or exceed this standard and provide products conforming with the requirements of the Drawings and this Specification.

2) Substitutions: Refer to Section 01 6000 for substitution procedures and requirements. Proposed substitutions must match specified product performance and colors.

b. Specifications:

- 1) Artwork as provided in Contract Documents.
- 2) Graphics panels must be LEED, GREENGUARD and FSC Certified and be manufactured as Custom High Pressure Laminate (CHPL). CHPL graphic sign material is composed of several layers of phenolic resin impregnated kraft filler paper, a digitally imaged graphic, a layer of melamine resin, surfaced by a layer of translucent exterior UV / graffiti overlay protection. The entire panel, including exterior overlay, must be bonded under heat and extreme pressure to form a composite panel. The finish must be smoothly textured with reflectivity of 30 + or 5 gloss units.
- 3) The CHPL graphics must be warranted for a minimum of 10 years against fading, de-lamination and weather deterioration. There should be no warranty requirements for an annual application of water sealant, no exclusions for panels used in "extreme temperatures" and no clause that warranties can can be denied due to "improper maintenance".
- 4) Panels must be able to be cleaned with any solvent and not restrict use of products containing lacquer thinner or acetone.
- 5) All cutting and finishing to be done using a CNC router.
- 6) Graphics must be made using 12-Color High Definition printing technology.
- 7) Vendor shall provide a sample from a supplied file to confirm quality.
- 8) Panels must be entirely made in the U.S.A.
- 9) Panel shall be 24" x 36" and a minimum of 1/2" in thickness.



2. Panel Support

a. Map Panel

- 1) Manufacturer / Product: Fossil Industries, Inc., *SPG1212 Pedestal* is the basis of design and the standard of quality, function, performance and appearance required for this project.
 - a) Products by other manufacturers may be acceptable, subject to their ability to meet or exceed this standard and provide products conforming with the requirements of the Drawings and this Specification.
 - b) Substitutions: Refer to Section 01 6000 for substitution procedures and requirements. Proposed substitutions must match specified product performance and colors.

2) Specifications:

a) Type: Angled Mount

b) Mounting: Ground Mount

c) Mounting Plate Size: 12" x 12"

d) Color: Black

E. Fasteners

- Anchor bolts, fasteners, fittings and hardware: shall be stainless steel, or Manufacturer's standard, corrosion-resistant-coated or non-corrodible materials; commercial quality, tamperproof, vandal and theft-resistant, concealed, recessed and capped or plugged.
- 2. Separation from concrete pavement surface with neoprene or stainless steel bottom plate.

PART 3 EXECUTION

3.01 COORDINATION

A. Review, coordinate and accommodate work of other sections that interface with, affect or are affected by the work of this section so as to facilitate the execution of the overall Work of this project in a coordinated and efficient manner.

3.02 EXAMINATION – GENERAL

A. Examine the areas and conditions where site furnishings are to be installed and notify the Contractor of conditions detrimental to the proper and timely installation and completion of the work.

B. Do not proceed with the work until unsatisfactory conditions have been corrected by the Contractor in a manner acceptable and to the satisfaction of the Engineer and Owner.

3.03 INSTALLATION - GENERAL

- A. Refer to applicable details and plans for layout and installation.
- B. Install rigid, plumb and true to lines and levels shown. Stake out all elements called for in this section for approval by Engineer or authorized representative. All work shall be of the highest quality.
- C. Unless otherwise indicated, install all equipment specified by name / manufacturer as per manufacturer's recommendations.

3.04 INSTALLATION – TRASH / RECYCLING RECEPTACLES

A. Install trash / recycling receptacles level, plumb and in proper alignment, bolt securely to concrete walk with stainless steel anchor bolts, in accordance with manufacturer's installation instructions.

3.05 INSTALLATION – PET WASTE RECEPTACLES

A. Install pet waste receptacles level, plumb and in proper alignment in accordance with manufacturer's installation instructions.

3.06 INSTALLATION - SITE BENCHES

A. Install site benches level, plumb and in proper alignment, bolt securely to concrete walk with stainless steel anchor bolts, in accordance with manufacturer's installation instructions.

3.07 INSTALLATION - SITE PICNIC TABLES, CLUSTER SEATING

A. Install tables and seating level, plumb and in proper alignment, bolt securely to concrete walk with stainless steel anchor bolts, in accordance with manufacturer's installation instructions.

3.08 INSTALLATION - SITE PICNIC TABLES, BENCH STYLE

A. Install tables and seating at locations shown on the Drawings. Install using provided mounting kits in strict accordance with the manufacturer's written directions.

3.09 INSTALLATION – SITE BICYCLE RACKS

A. Install per manufacturer's installation instructions. Installation shall be plumb and true.

3.10 INSTALLATION – PLAYGROUND WATER PUMP

A. Playground water pump shall be installed as indicated on approved submittals as recommended and in strict accordance with manufacturer's written directions and as indicated on the Drawings and specified herein.

3.11 INSTALLATION - PRECAST CEMENT CONCRETE PUMP TRACK

A. Precast cement concrete pump track shall be installed as indicated on approved submittals as recommended and in strict accordance with manufacturer's written directions and as indicated on the Drawings and specified herein.

3.12 INSTALLATION - NON-SLIP TREADS

A. Install per manufacturer's installation instructions.


3.13 INSTALLATION - PARK SIGN

A. Install per manufacturer's installation instructions.

3.14 FIELD QUALITY CONTROL

- A. Contractor Quality Control: Employ / assign quality control personnel to monitor the work of this section for conformance to the requirements of the Contract Documents and to good construction practices.
 - 1. Contractor is solely responsible for managing and controlling the quality of the work and conformance with the requirements of the Contract Documents.

END OF SECTION

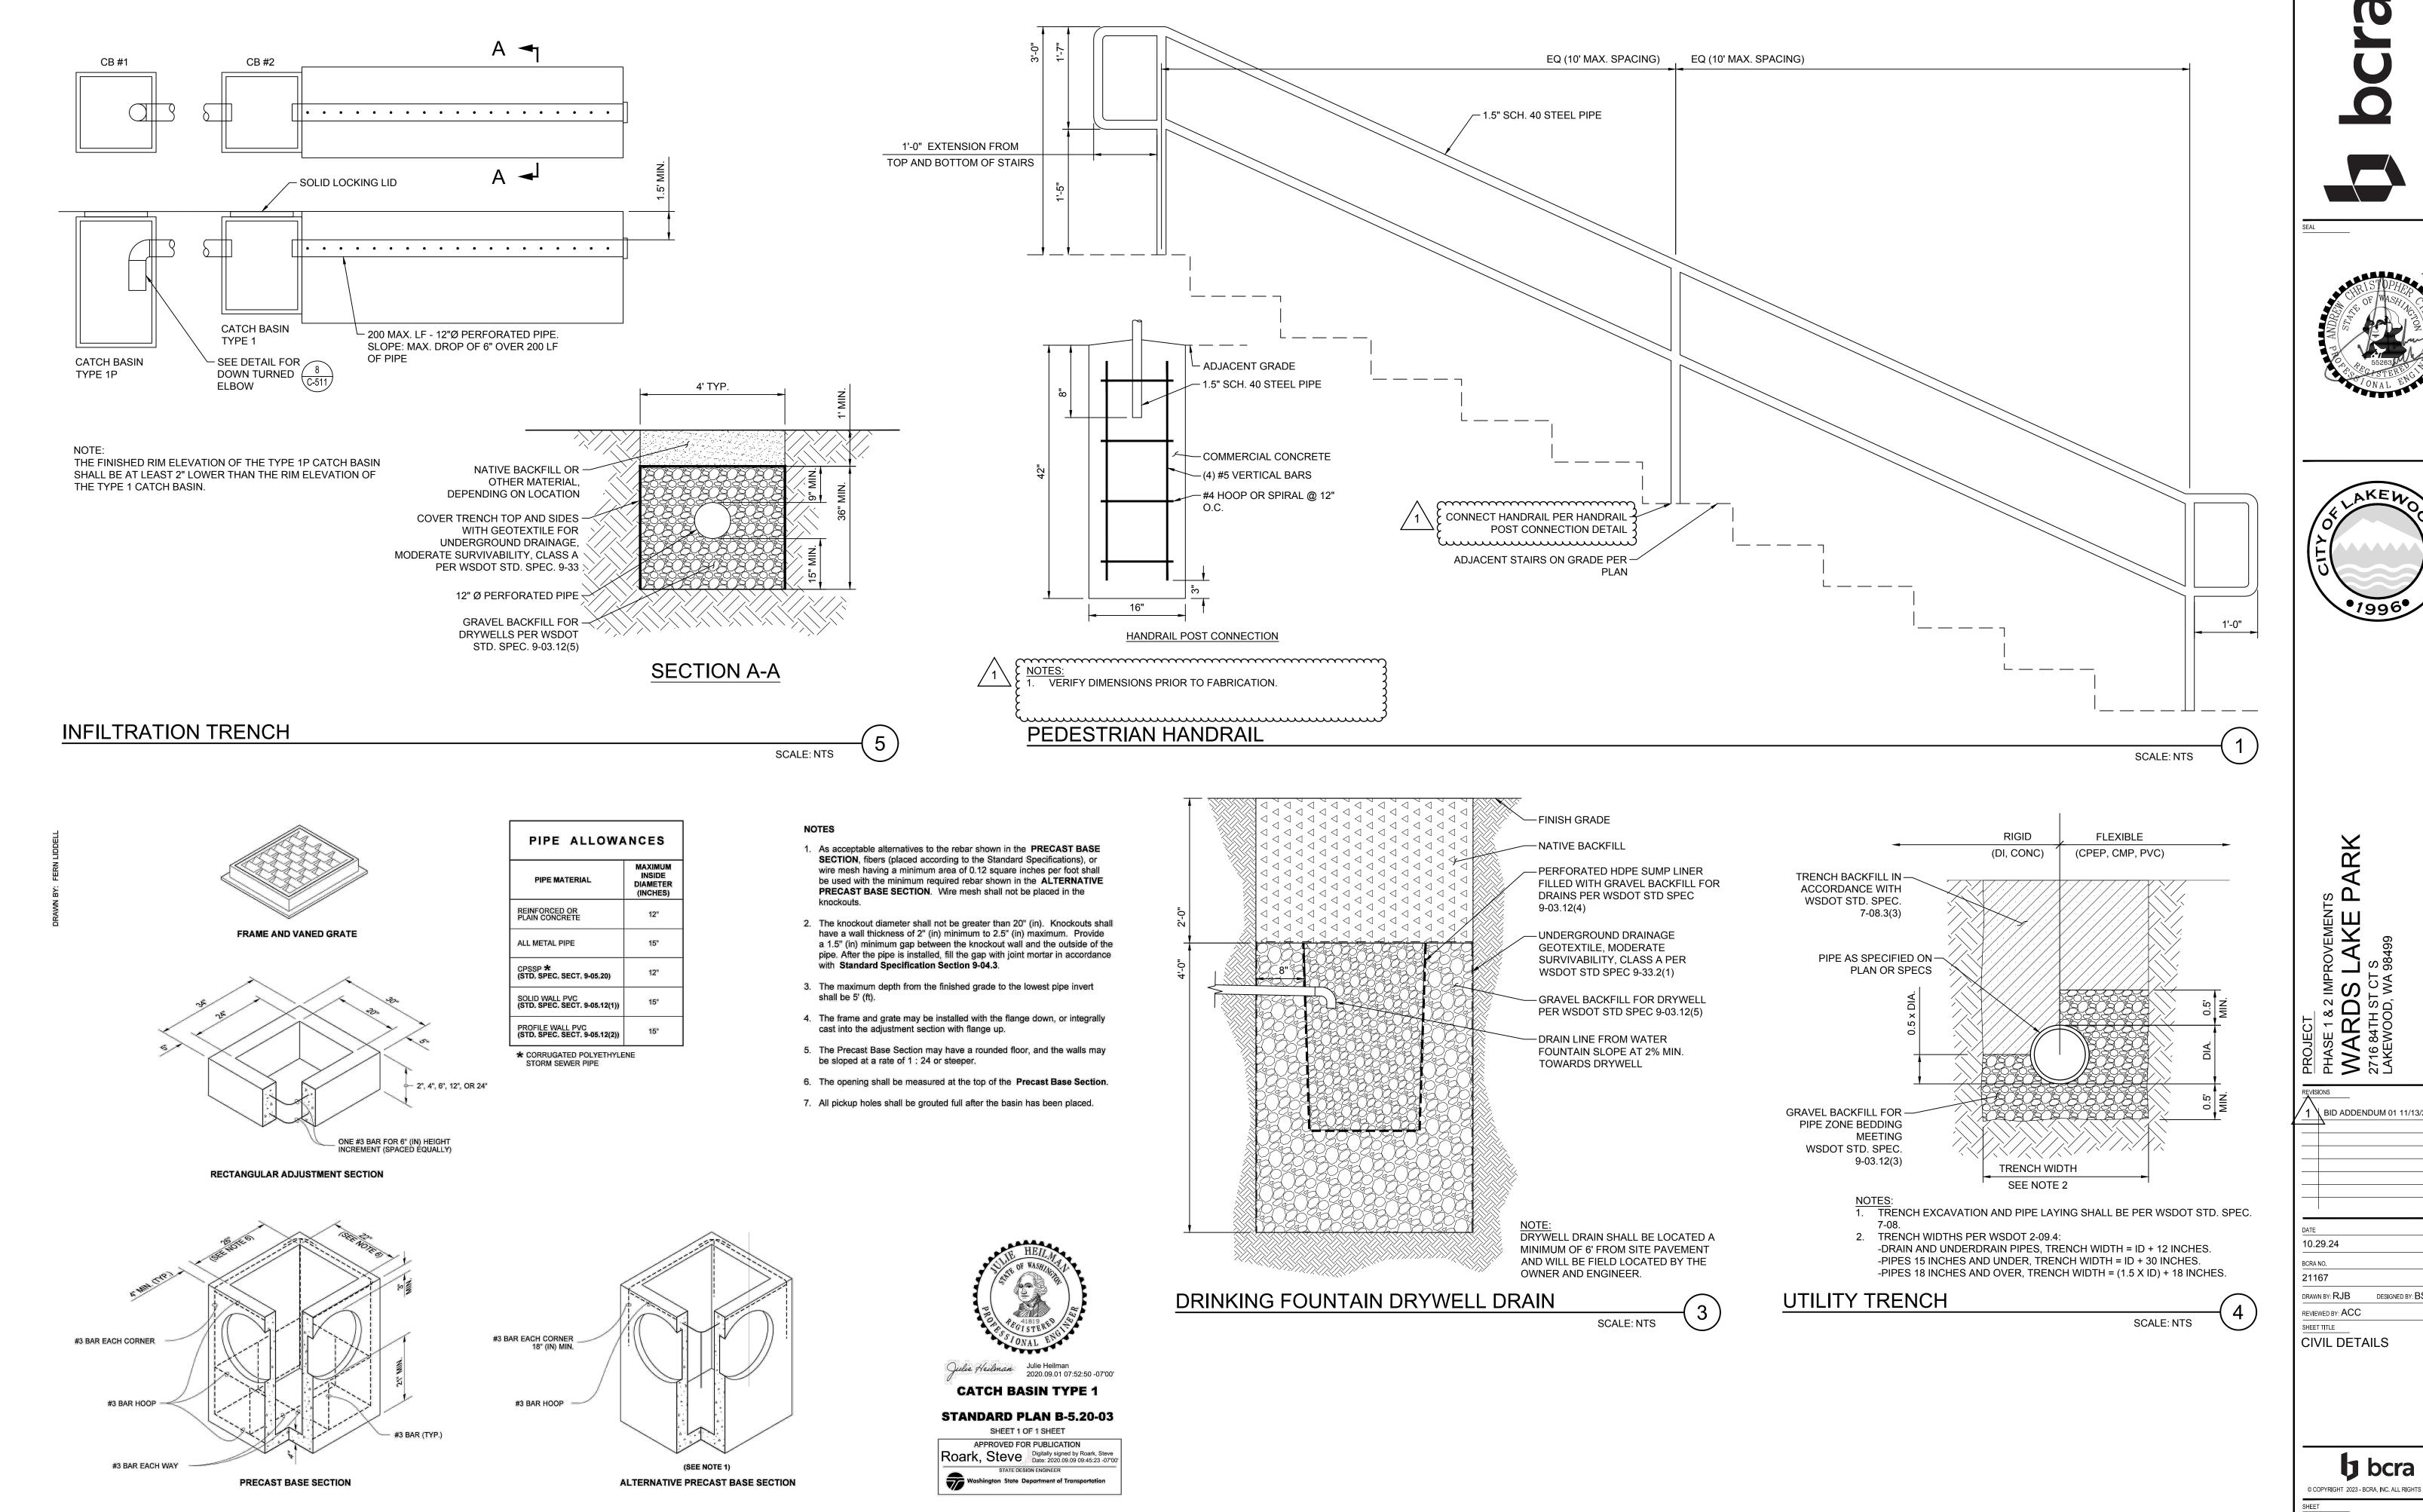

SCALE: NTS

CATCH BASIN TYPE 1







1 \ BID ADDENDUM 01 11/13/24


DESIGNED BY: BS


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√_ (1) #4 X 2'-0" PLAN VIEW HANDRAIL POST CONNECTION

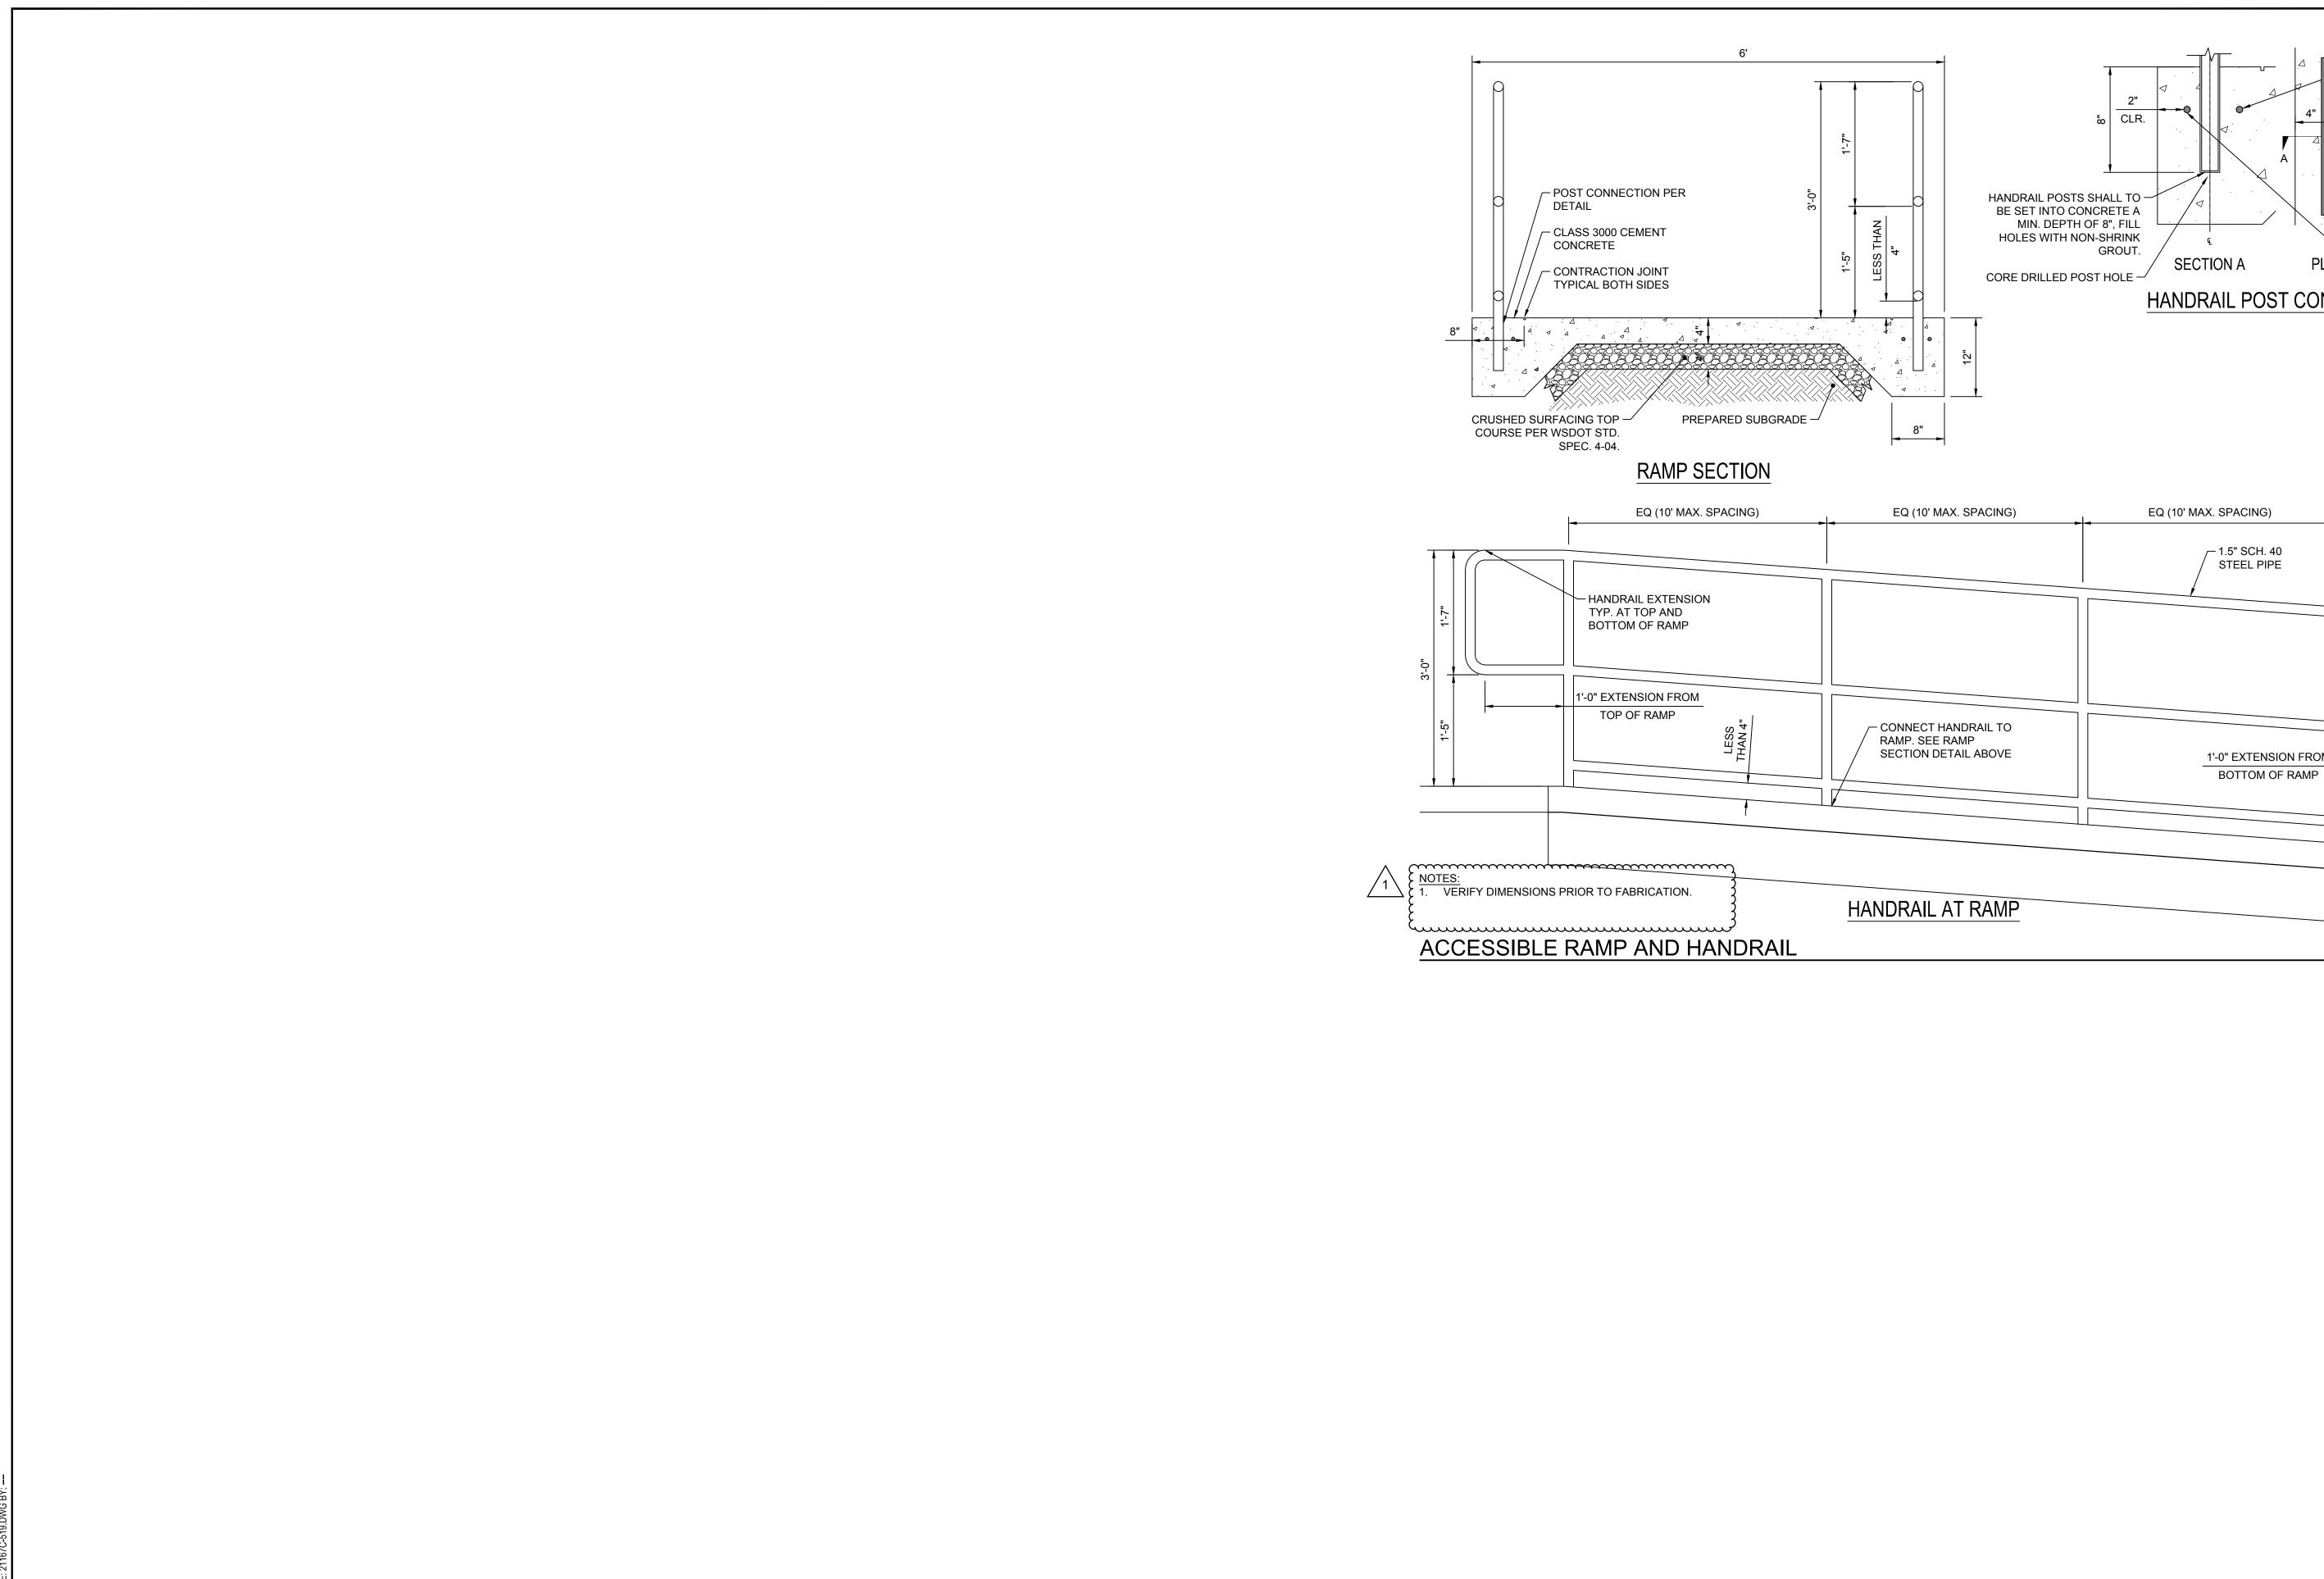



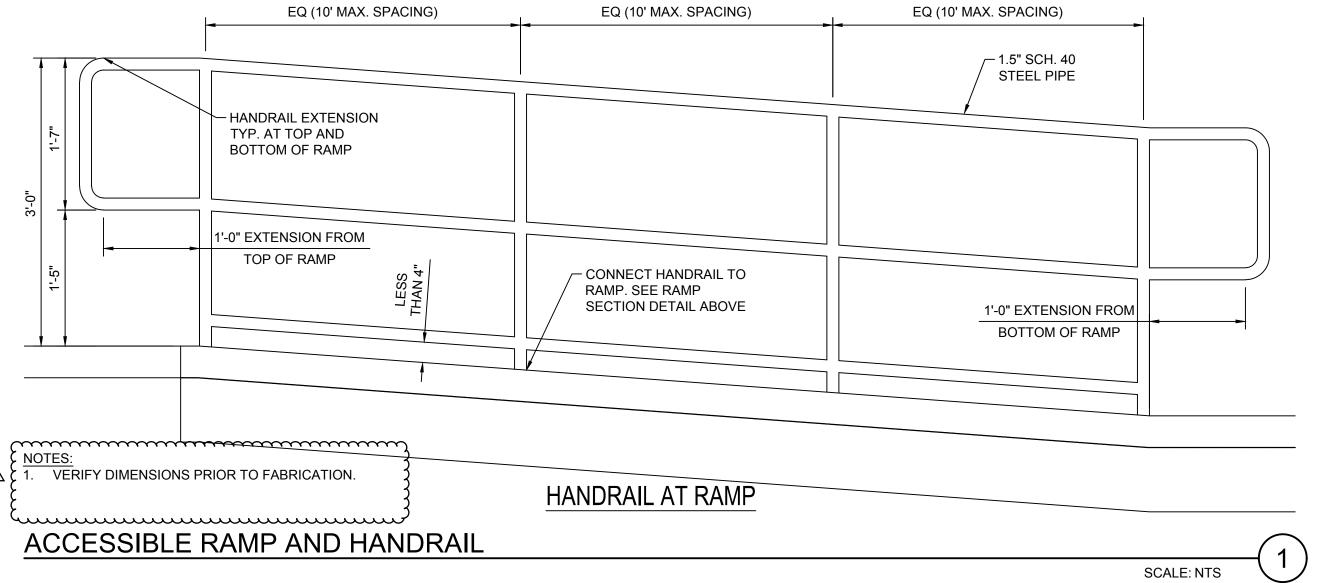

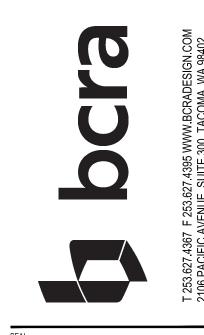

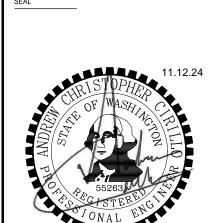

1 BID ADDENDUM 01 11/13/24


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21167 DRAWN BY: RJB

SHEET TITLE

CIVIL DETAILS

b bcra

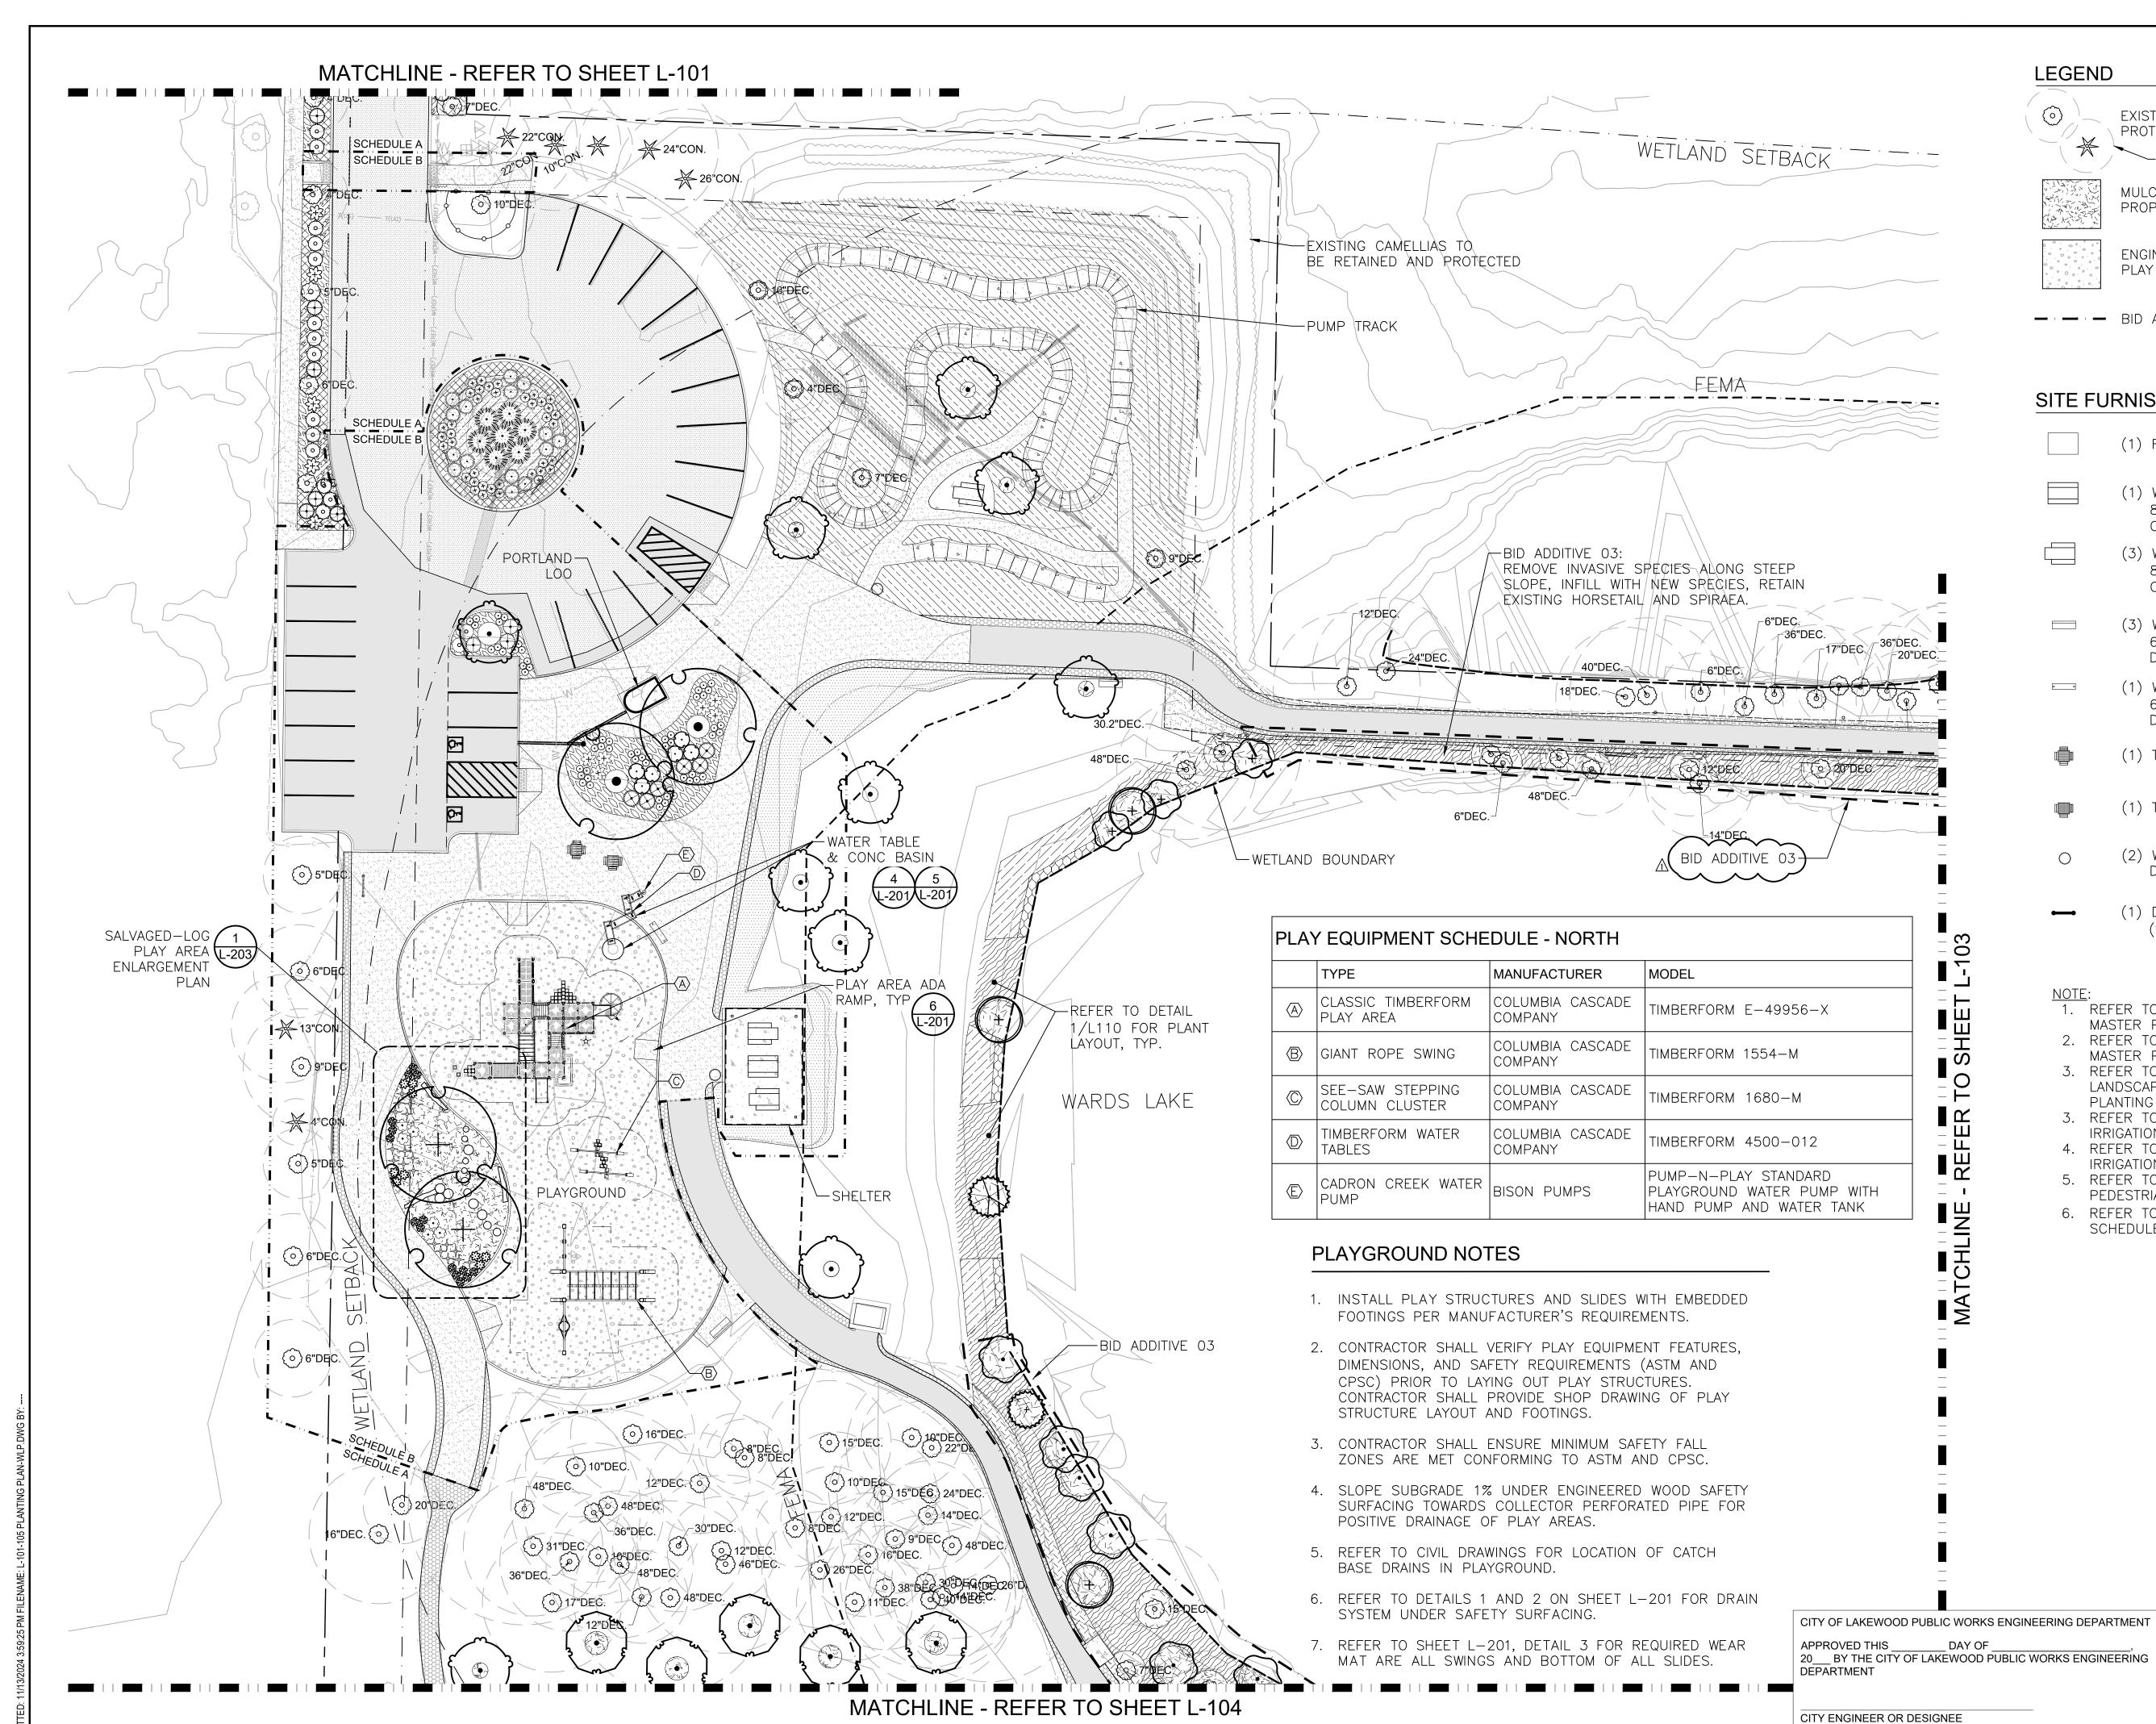


LEGEND




EXISTING TREES TO BE PROTECTED & RETAINED



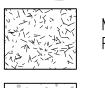

MULCH AROUND EXISTING & PROPOSED TREES

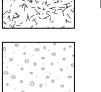

ENGINEERED WOOD FIBER PLAY SURFACING





SITE FURNISHINGS LEGEND L-102


- (1) RELOCATED EXISTING PICNIC TABLE
- (1) WABASH VALLEY, SIGNATURE COLLECTION 8' TABLE, 3/8" LEGS, DIAMOND, COLOR: GREEN
 - (3) WABASH VALLEY, SIGNATURE COLLECTION 8' ADA TABLE, 2 3/8" LEGS, DIAMOND, COLOR: GREEN
 - (3) WABASH VALLEY, SIGNATURE COLLECTION 6' BENCH W/ BACK, SURFACE MOUNT, DIAMOND, CÓLOR: GREEN
 - (1) WABASH VALLEY, SIGNATURE COLLECTION 6' BENCH W/OUT BACK, SURFACE MOUNT, DIAMOND, COLOR: GREEN
- (1) TABLE WITH FOUR SEATS, 4' X 4'
- (1) TABLE WITH THREE SEATS, 4' X 4'
- (2) WABASH 32 GALLON RECEPTACLE, DIAMOND, COLOR: GREEN
 - (1) DUMOR 125-30 BIKE RACK (SURFACE MOUNT)

- 1. REFER TO SHEET L-110 FOR SCH-A:
- MASTER PLANT & SEED SCHEDULES. 2. REFER TO SHEET L-111 FOR SCH-B: MASTER PLANT & SEED SCHEDULES.
- 3. REFER TO L-200 SERIES DRAWINGS FOR LANDSCAPE DETAILS, HARDSCAPE & PLANTING DETAILS.
- 3. REFER TO L-300 SERIES DRAWINGS FOR IRRIGATION.
- 4. REFER TO L-400 SERIES FOR
- IRRIGATION DETAILS 5. REFER TO CIVIL FOR VEHICLE AND
- PEDESTRIAN PAVING. 6. REFER TO SHEET L-102.1 FOR PLANT

SCHEDULES FOR THIS SHEET.

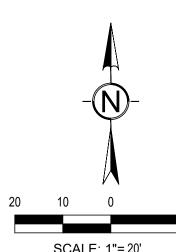

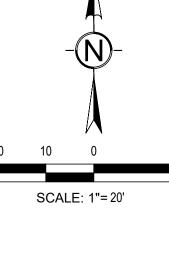

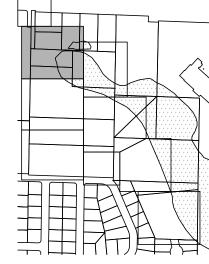

Know what's below.

Call before you dig.

L-102 BID SET

bcra

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PROJECT
PHASE 1 & 2
WARRD
2716 84TH ST
LAKEWOOD, 1

11-14-24

21167

DRAWN BY: PS

REVIEWED BY: 10

LANDSCAPE PLAN

SHEET TITLE

↑ | ADDENDUM 1, 11.14.2024

DESIGNED BY: PS, PG

DIANT SCHEDIII E I 102 SCH A

PLANT :	SCHE	EDULE L-102 SCH-A		
SYMBOL	QTY	BOTANICAL / COMMON NAME	SIZE	
TREES				
+	2	ALNUS RUBRA RED ALDER	1 GAL, 12" HT	
	9	CORNUS NUTTALLII 'EDDIE'S WHITE WONDER' EDDIE'S WHITE WONDER DOGWOOD	3" CAL, BRANCHING AT 6 FT	
	1	PICEA SITCHENSIS SITKA SPRUCE	1 GAL	
	5	QUERCUS GARRYANA OREGON WHITE OAK	5 GAL, 4 – 6 FT HT	
	3	SALIX HOOKERIANA DUNE WILLOW	1 GAL, 12" HT	
<u>SHRUBS</u>				
£	5	AZALEA X 'HINO—CRIMSON' HINO—CRIMSON KURUME AZALEA	2 GAL	
\oplus	6	AZALEA X 'GIRARD'S FUCHSIA' GIRARD'S FUCHSIA AZALEA	2 GAL	
\odot	14	PINUS MUGO 'PUMILIO' DWARF MUGO PINE	2 GAL, 12" SPREAD	
SYMBOL	<u>QTY</u>	BOTANICAL / COMMON NAME	SIZE/SPACING	SPACING
GROUND CO	OVERS			
	52	AJUGA REPTANS 'CATLIN'S GIANT' CATLIN'S GIANT CARPET BUGLE	4" POT	18" o.c.
	53	FRAGARIA CHILOENSIS BEACH STRAWBERRY	4" POT	18" o.c.
A	78	RUBUS CALYCINOIDES 'EMERALD CARPET' EMERALD CARPET CREEPING BRAMBLE	4" POT	18" o.c.

PLANT MIX & SEED MIX SCHEDULE L-102 SCH-A

SHORELINE - NATIVE SHRUB MIX	1,078 SF
CORNUS SERICEA / RED TWIG DOGWOOD	8
HOLODISCUS DISCOLOR / OCEANSPRAY	8
LONICERA INVOLUCRATA / TWINBERRY	5
MYRICA GALE / SWEETGALE	3
ROSA NUTKANA / NOOTKA ROSE	5
RUBUS PARVIFLORUS / THIMBLEBERRY	8
SPIRAEA DOUGLASII / WESTERN SPIREA	5
SYMPHORICARPOS ALBUS / COMMON WHITE SNOWBERRY	10
SHORELINE - NATIVE RUSH MIX CLUSTER SAME SPECIES IN GROUPS OF 5 TO 12	158 SF
JUNCUS EFFUSUS SPP. PACIFICUS / PACIFIC RUSH	54
SCHOENOPLECTUS ACUTUS / HARDSTEM BULRUSH	54
SCHOENOPLECTUS TABERNAEMONTANI / SOFTSTEM BULRU	
LAWN SEED MIX	1,806 SF
IRRIGATED AREA	
TRAIL BUFFER - NATIVE SEED MIX	306 SF
SUNMARK "STREAMBANK PLUS MIX"	
APPLICATION RATE: 1.5 LBS/1000 SF	
ZZ CHORELINE LOW OROW MATIVE MIX	4 004 01
SHORELINE - LOW GROW NATIVE MIX	1,291 SF
//I NDD Y EIRCIN CINNNARK NIVINE W/VIED (111VIIIA WIA	\triangle 1
1. APPLY FIRST:: SUNMARK "NATIVE WATER QUALITY MIX" APPLICATION RATE OF 21.69 LBS / ACRE	
APPLY FIRST:: SUNMARK NATIVE WATER QUALITY MIX APPLICATION RATE OF 21.69 LBS / ACRE. 2. ALLOW ABOVE MIX TO GROW FOR 1 WEEK.	
APPLICATION RATE OF 21.69 LBS / ACRE.	
APPLICATION RATE OF 21.69 LBS / ACRE. 2. ALLOW ABOVE MIX TO GROW FOR 1 WEEK.	
APPLICATION RATE OF 21.69 LBS / ACRE. 2. ALLOW ABOVE MIX TO GROW FOR 1 WEEK. 3. THE APPLY SUNMARK "WETLAND PRAIRIE MIX" AT RATE	

SEE SHEET L-110 FOR SCH-A: MASTER PLANT & SEED SCHEDULES
 REFER TO DETAIL 1, L-110 FOR SAMPLE LAYOUT: SHORELINE -

SUNMARK "SUPREME PLUS MIX"

NATIVE SHRUB MIX

APPLICATION RATE: 4 LBS / 1000 SF

PLANT SCHEDULE L-102 SCH-B

SYMBOL	QTY	BOTANICAL / COMMON NAME	SIZE	
TREES				
	\			
(2	BETULA NIGRA RIVER BIRCH	2" CAL	
2 5	V			
£ 3	4	CORNUS NUTTALLII 'EDDIE'S WHITE	7" OAL DDANGLUNG AT C FT	
	I	WONDER' EDDIE'S WHITE WONDER DOGWOOD	3" CAL, BRANCHING AT 6 FT	
0				
•	2	QUERCUS PHELLOS WILLOW OAK	3" CAL, BRANCHING AT 6 FT	
7 2	J	WILLOW OAK		
CUIDUDO				
SHRUBS ∰	6	AZALEA X 'HINO-CRIMSON' HINO-CRIMSON KURUME AZALEA	2 GAL	
\oplus	9	AZALEA X 'GIRARD'S FUCHSIA' GIRARD'S FUCHSIA	2 GAL	
Solution Services	 15	CORNUS SERICEA KELSEYI	2 GAL	
A Connection	••••	KELSEY'S DWARE RED TWIG DOGWOOD		
	2	PINUS MUGO 'PUMILIO' DWARF MUGO PINE	2 GAL, 12" SPREAD	
\odot	6	RIBES SANGUINEUM RED_FLOWFRING_CURRANT	2 GAL, 15" HT	
	7	SALIX PURPUREA 'CANYON BLUE' ARCTIC BLUE PURPLE OSIER WILLOW	3 GAL	
}	38	SPIRAEA BETULIFOLIA 'TOR'	2 GAL {	
∆ € ⊕		WHITE-FROST™ BIRCHLEAF-SPIREA VACCINIUM OVATUM	5 GAL	
\bigotimes	O	EVERGREEN HUCKLEBERRY	J GAL	
FERNS/GROUNDC		RENNIALS BOUTELOUA GRACILIS 'BLONDE AMBITION'		
+	18	BLONDE AMBITION BLUE GRAMA	2 GAL	
\$	9	EPIMEDIUM X 'AMBER QUEEN' AMBER QUEEN BARRENWORT	1 GAL	
	59	IRIS TENAX OREGON IRIS	BULB	
*	15	STACHYS BYZANTINA 'BIG EARS' BIG EARS LAMB'S EAR	1 GAL	
SYMBOL	QTY	BOTANICAL / COMMON NAME	SIZE/SPACING	SPACING
GROUND COVERS				
	256	FRAGARIA CHILOENSIS BEACH STRAWBERRY	4" POT	18" o.c.
	144	RUBUS CALYCINOIDES 'EMERALD CARPET' EMERALD CARPET CREEPING BRAMBLE	4" POT	18" o.c.

BID ADDITIVE #03: PLANT SCHEDULE L-102

SYMBOL QTY BOTANICAL / COMMON NAME SIZE



BID ADDITIVE #03: PLANT MIX & SEED MIX SCHEDULE L-102

SHORELINE - NATIVE SHRUB MIX CORNUS SERICEA / RED TWIG DOGWOOD	1,896 SF 1 4
12/374	• •
HOLODISCUS DISCOLOR / OCEANSPRAY	14
LONICERA INVOLUCRATA / TWINBERRY	9
MYRICA GALE / SWEETGALE	5
ROSA NUTKANA / NOOTKA ROSE	9
RUBUS PARVIFLORUS / THIMBLEBERRY	14
SPIRAEA DOUGLASII / WESTERN SPIREA	9
SYMPHORICARPOS ALBUS / COMMON WHITE SNOWBERF	RY 18

TRAIL BUFFER - NATIVE SEED MIX	306 S
TRAIL BUFFER - NATIVE SEED MIX SUNMARK "STREAMBANK PLUS MIX" APPLICATION RATE: 1.5 LBS/1000 SF	
APPLICATION RATE: 1.5 LBS/1000 SF	


NOTE:


- 1. SEE SHEET L-112 FOR BID ADDITIVE #03 MASTER PLANT &
- SEED SCHEDULE

 2. REFER TO DETAIL 1, L—112 FOR SAMPLE LAYOUT: SHORELINE —
 NATIVE SHRUB MIX





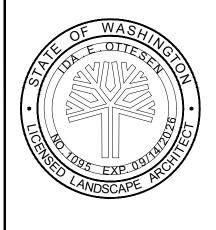

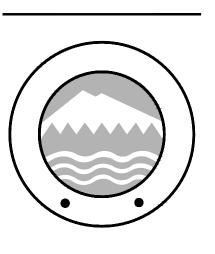

REVIS	ONS			
$\underline{\Lambda}$	ADDEN	DUM	1, 11	.14.202

21167 DRAWN BY: PS DESIGNED BY: PS, PG SHEET TITLE

NOTES & SCHEDULES

11-14-24

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CITY OF LAKEWOOD PUBLIC WORKS ENGINEERING DEPARTMENT

APPROVED THIS _____ ____ DAY OF _ 20___ BY THE CITY OF LAKEWOOD PUBLIC WORKS ENGINEERING DEPARTMENT

CITY ENGINEER OR DESIGNEE



Know what's **below.**

Call before you dig.

LEGEND



EXISTING TREES TO BE PROTECTED & RETAINED

TREE DRIP LINE



MULCH AROUND EXISTING & PROPOSED TREES


- BID ADDITIVE

SITE FURNISHINGS LEGEND L-103

(1) RELOCATED EXISTING PICNIC TABLE

(1) WABASH VALLEY, SIGNATURE COLLECTION 6' BENCH W/ BACK, SURFACE MOUNT, DIAMOND, CÓLOR: GREEN

(1) WABASH 32 GALLON RECEPTACLE, DIAMOND, COLOR: GREEN

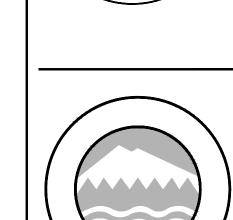

- 1. REFER TO SHEET L-110 FOR SCH-A: MASTER PLANT & SEED SCHEDULES.
- 2. REFER TO SHEET L-111 FOR SCH-B:
- MASTER PLANT & SEED SCHEDULES. 3. REFER TO L-200 SERIES DRAWINGS FOR LANDSCAPE DETAILS, HARDSCAPE & PLANTING DETAILS.
- 3. REFER TO L-300 SERIES DRAWINGS FOR IRRIGATION.
- 4. REFER TO L-400 SERIES FOR IRRIGATION DETAILS
- 5. REFER TO CIVIL FOR VEHICLE AND PEDESTRIAN PAVING.
- 6. REFER TO SHEET L-103.1 FOR PLANT
- SCHEDULES FOR THIS SHEET. 7. FIELD VERIFY CONNECTOR PATH LAYOUT. FLAG LAYOUT OF PATH FOR APPROVAL BY OWNER PRIOR TO CONSTRUCTION OF PATH.
- MULCH DEPTH TO BE 6 INCHES. 8. REFER TO THE FOLLOWING REPORT FOR REQUIRED PRUNING OF TREE 484 (NEAR EXISTING PICNIC TABLE). "WARDS LAKE PARK IMPROVEMENT PROJECT: TREE RISK ASSESSMENT AND PROTECTION" DATED JUNE 21, 2022, BY URBAN FORESTRY SERVICES BARTLETT CONSULTING. NOTE: PRUNING IS REQUIRE EVEN THOUGH AT RISK PICNIC TABLE WILL BE MOVED OR REMOVED.



↑ | ADDENDUM 1, 11.14.2024

TE				
1-1	14-24			

21167 DRAWN BY: PS DESIGNED BY: PS, PG

REVIEWED BY: 10 SHEET TITLE

LANDSCAPE PLAN

b bcra

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BID SET

CITY OF LAKEWOOD PUBLIC WORKS ENGINEERING DEPARTMENT APPROVED THIS ___ DAY OF _ 20___ BY THE CITY OF LAKEWOOD PUBLIC WORKS ENGINEERING DEPARTMENT

SCALE: 1"= 20'


CITY ENGINEER OR DESIGNEE





PLANT SCHEDULE L-103 SCH-A

QTY BOTANICAL / COMMON NAME SIZE

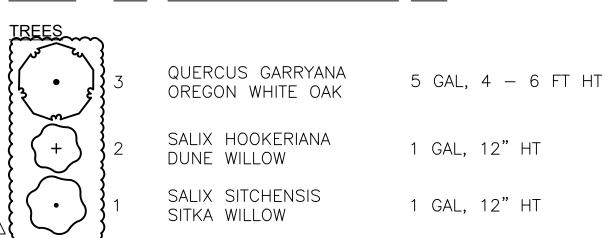

PLANT MIX & SEED MIX SCHEDULE L-103 SCH-A

SHORELINE - NATIVE SHRUB MIX	822 SF
CORNUS SERICEA / RED TWIG DOGWOOD	6
HOLODISCUS DISCOLOR / OCEANSPRAY	6
LONICERA INVOLUCRATA / TWINBERRY	5
MYRICA GALE / SWEETGALE	2
ROSA NUTKANA / NOOTKA ROSE	5
RUBUS PARVIFLORUS / THIMBLEBERRY	7
SPIRAEA DOUGLASII / WESTERN SPIREA	5
SYMPHORICARPOS ALBUS / COMMON WHITE SNOWBERRY	9

92 SF TRAIL BUFFER - NATIVE SEED MIX SUNMARK "STREAMBANK PLUS MIX" APPLICATION RATE: 1.5 LBS/1000 SF

NOTE:

1. SEE SHEET L-110 FOR SCH-A: MASTER PLANT & SEED SCHEDULES 2. REFER TO DETAIL 1, L-110 FOR SAMPLE LAYOUT: SHORELINE -NATIVE SHRUB MIX

BID ADDITIVE #03: PLANT SCHEDULE L-103

SYMBOL QTY BOTANICAL / COMMON NAME SIZE



BID ADDITIVE #03: PLANT MIX & SEED MIX SCHEDULE L-103

SHORELINE - NATIVE SHRUB MIX	4,596 SF
CORNUS SERICEA / RED TWIG DOGWOOD	34
HOLODISCUS DISCOLOR / OCEANSPRAY	34
LONICERA INVOLUCRATA / TWINBERRY	23
MYRICA GALE / SWEETGALE	11
ROSA NUTKANA / NOOTKA ROSE	24
RUBUS PARVIFLORUS / THIMBLEBERRY	34
SPIRAEA DOUGLASII / WESTERN SPIREA	23
SYMPHORICARPOS ALBUS / COMMON WHITE SNOWBERRY	48
SHORELINE - NATIVE RUSH MIX CLUSTER SAME SPECIES IN GROUPS OF 5 TO 12	175 SF
JUNCUS EFFUSUS SPP. PACIFICUS / PACIFIC RUSH	60
SCHOENOPLECTUS ACUTUS / HARDSTEM BULRUSH	60
SCHOENOPLECTUS TABERNAEMONTANI / SOFTSTEM BULRUSH	


EROSION CONTROL SEED MIX	33 SF
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TRAIL BUFFER - NATIVE SEED MIX	385 SI
SUNMARK "STREAMBANK PLUS MIX" APPLICATION RATE: 1.5 LBS/1000 SF	
APPLICATION RATE: 1.5 LBS/1000 SF	


SHORELINE - LOW GROW NATIVE MIX	298 S
SHORELINE - LOW GROW NATIVE MIX 1. APPLY FIRST:: SUNMARK "NATIVE WATER QUALITY MIX" AT APPLICATION RATE OF 21.69 LBS / ACRE. 2. ALLOW ABOVE MIX TO GROW FOR 1 WEEK. 3. THE APPLY SUNMARK "WETLAND PRAIRIE MIX" AT RATE OF 43.66 LBS / ACRE.	
APPLICATION RATE OF 21.69 LBS / ACRE.	
2. ALLOW ABOVE MIX TO GROW FOR 1 WEEK.	
3. THE APPLY SUNMARK "WETLAND PRAIRIE MIX" AT RATE	
OF 43.66 LBS / ACRE.	

- 1. SEE SHEET L-112 FOR BID ADDITIVE #03 MASTER PLANT &
- SEED SCHEDULE

 2. REFER TO DETAIL 1, L-112 FOR SAMPLE LAYOUT: SHORELINE NATIVE SHRUB MIX



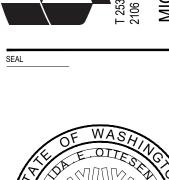

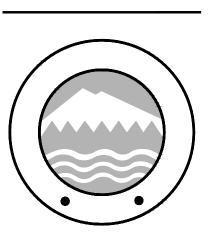

11-14-24 21167 DRAWN BY: PS DESIGNED BY: PS, PG

SHEET TITLE NOTES & SCHEDULES


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CITY OF LAKEWOOD PUBLIC WORKS ENGINEERING DEPARTMENT


APPROVED THIS _____ ___ DAY OF _ 20___ BY THE CITY OF LAKEWOOD PUBLIC WORKS ENGINEERING DEPARTMENT


CITY ENGINEER OR DESIGNEE

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11-14-24 DESIGNED BY: PS, PG DRAWN BY: PS REVIEWED BY: 10 SHEET TITLE

LANDSCAPE PLAN
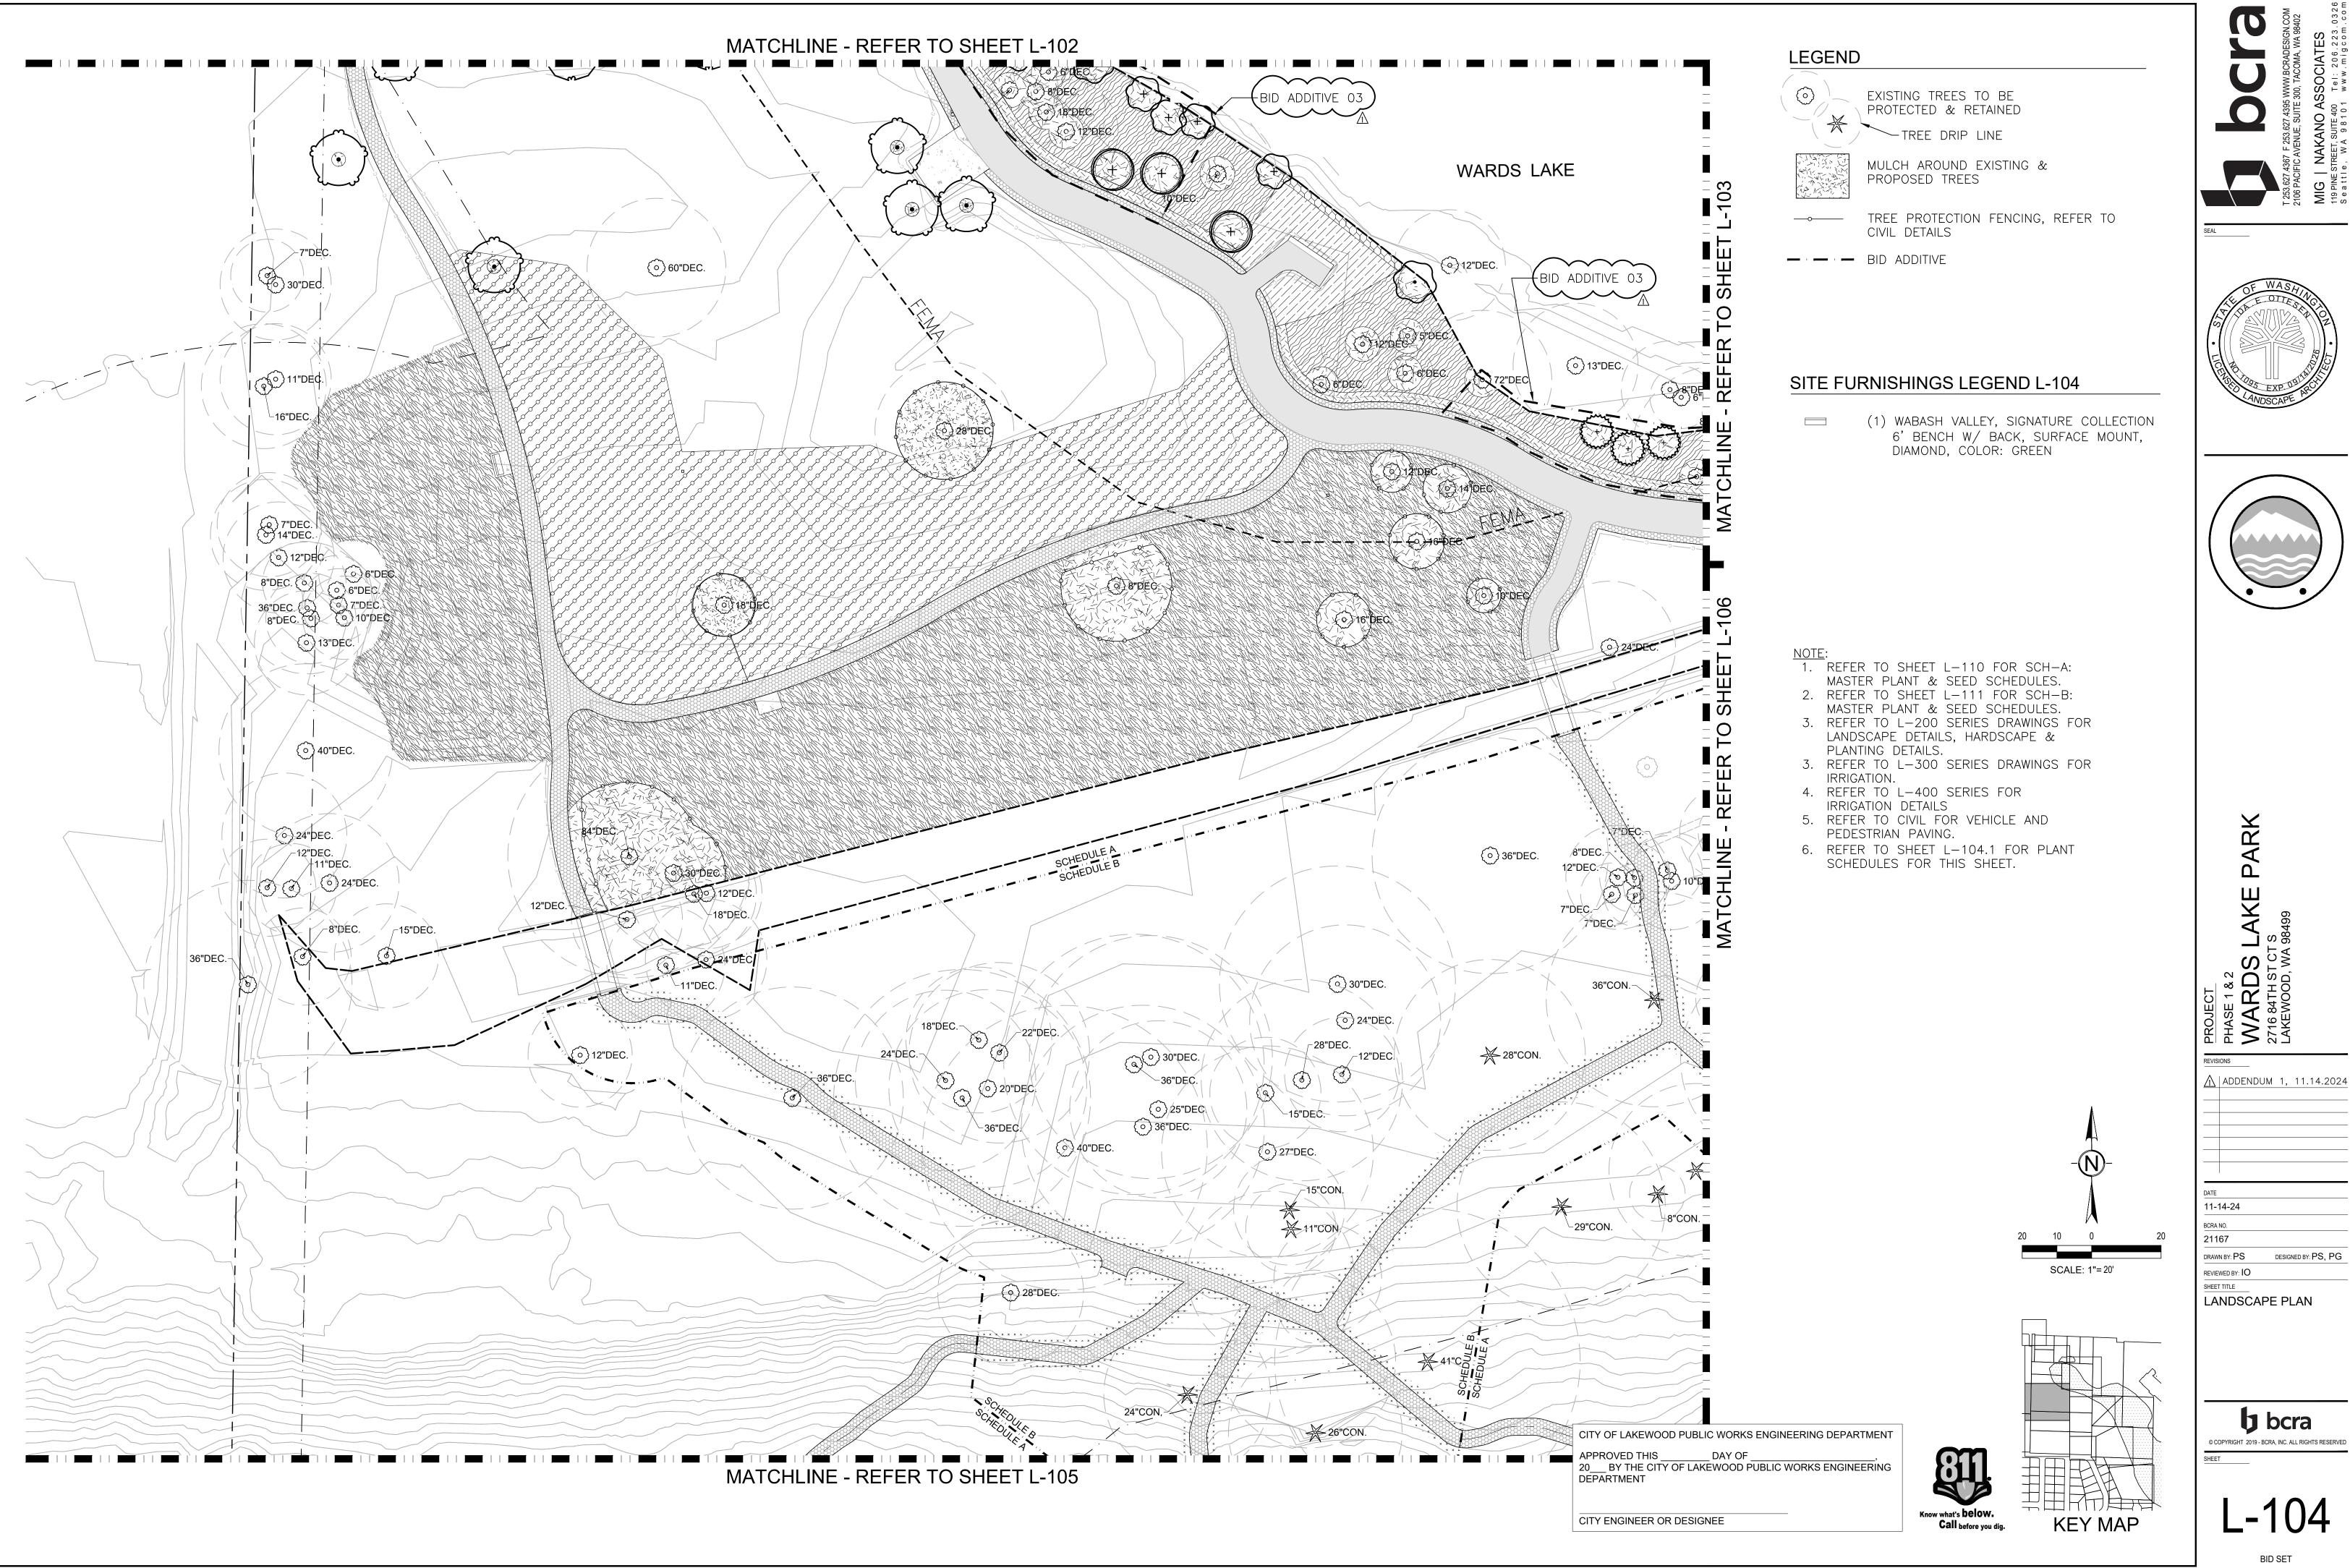
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BID SET

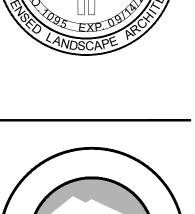PLANT SCHEDULE L-104 SCH-A BASE BID

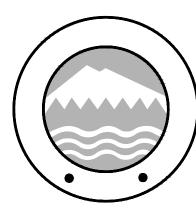SYMBOL	QTY	BOTANICAL / COMMON NAME	SIZE
TREES +	1	ALNUS RUBRA RED ALDER	1 GAL, 12" HT
	5	CORNUS NUTTALLII 'EDDIE'S WHITE WONDER' EDDIE'S WHITE WONDER DOGWOOD	3" CAL, BRANCHING AT 6 FT
+	1	SALIX HOOKERIANA DUNE WILLOW	1 GAL, 12" HT
	1	SALIX SITCHENSIS SITKA WILLOW	1 GAL, 12" HT

PLANT MIX & SEED MIX SCHEDULE L-104 SCH-A

SHORELINE - NATIVE SHRUB MIX CORNUS SERICEA / RED TWIG DOGWOOD HOLODISCUS DISCOLOR / OCEANSPRAY LONICERA INVOLUCRATA / TWINBERRY MYRICA GALE / SWEETGALE ROSA NUTKANA / NOOTKA ROSE RUBUS PARVIFLORUS / THIMBLEBERRY SPIRAEA DOUGLASII / WESTERN SPIREA SYMPHORICARPOS ALBUS / COMMON WHITE SNOWBERRY	1,438 SF 10 10 7 4 7 11 7
SHORELINE - NATIVE RUSH MIX CLUSTER SAME SPECIES IN GROUPS OF 5 TO 12 JUNCUS EFFUSUS SPP. PACIFICUS / PACIFIC RUSH SCHOENOPLECTUS ACUTUS / HARDSTEM BULRUSH SCHOENOPLECTUS TABERNAEMONTANI / SOFTSTEM BULRUSH	108 SF 37 37 38
TRAIL BUFFER - NATIVE SEED MIX SUNMARK "STREAMBANK PLUS MIX"	254 SF

MEADOW - SEED MIX:	20,529
SUNMARK "NATIVE MEADOW MIX"	
MEADOW - SEED MIX: SUNMARK "NATIVE MEADOW MIX" APPLICATION RATE: 1LB/1000 SF	

12,453 SF

88	NATIVE GRASSLAND MIX
800	NATIVE GRASSLAND MIX SUNMARK "NATIVE GRASSLANDS MIX" APPLICATION RATE: 1.0 LBS/1000 SF
	APPLICATION RATE: 1.0 LBS/1000 SF

APPLICATION RATE: 1.5 LBS/1000 SF

SHORELINE - LOW GROW NATIVE MIX	838 SF
SHORELINE - LOW GROW NATIVE MIX 1. APPLY FIRST:: SUNMARK "NATIVE WATER QUALITY MIX" AT APPLICATION RATE OF 21.69 LBS / ACRE. 2. ALLOW ABOVE MIX TO GROW FOR 1 WEEK. 3. THE APPLY SUNMARK "WETLAND PRAIRIE MIX" AT RATE	
APPLICATION RATE OF 21.69 LBS / ACRE.	
2. ALLOW ABOVE MIX TO GROW FOR 1 WEEK.	
3. THE APPLY SUNMARK "WETLAND PRAIRIE MIX" AT RATE	
OF 43.66 LBS / ACRE.	

NOTE:

SEE SHEET L-110 FOR SCH-A: MASTER PLANT & SEED SCHEDULES
 REFER TO DETAIL 1, L-110 FOR SAMPLE LAYOUT: SHORELINE -NATIVE SHRUB MIX

BID ADDITIVE #03: PLANT SCHEDULE L-104

SYMBOL QTY BOTANICAL / COMMON NAME SIZE ALNUS RUBRA RED ALDER



BID ADDITIVE #03: PLANT MIX & SEED MIX SCHEDULE L-104


SHORELINE - NATIVE SHRUB MIX	1,387 S
CORNUS SERICEA / RED TWIG DOGWOOD	10
HOLODISCUS DISCOLOR / OCEANSPRAY	10
LONICERA INVOLUCRATA / TWINBERRY	7
MYRICA GALE / SWEETGALE	3
ROSA NUTKANA / NOOTKA ROSE	7
RUBUS PARVIFLORUS / THIMBLEBERRY	10
SPIRAEA DOUGLASII / WESTERN SPIREA	7
SYMPHORICARPOS ALBUS / COMMON WHITE SNOWBERRY	14


TRAIL BUFFER - NATIVE SEED MIX	447 SF
TRAIL BUFFER - NATIVE SEED MIX SUNMARK "STREAMBANK PLUS MIX"	
APPLICATION RATE: 1.5 LBS/1000 SF	

- 1. SEE SHEET L-112 FOR BID ADDITIVE #03 MASTER PLANT &
- SEED SCHEDULE

 2. REFER TO DETAIL 1, L-112 FOR SAMPLE LAYOUT: SHORELINE NATIVE SHRUB MIX



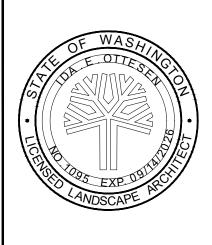

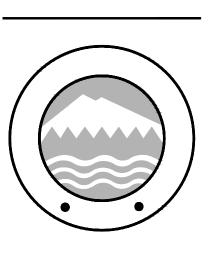

11-14-24 21167 DRAWN BY: PS DESIGNED BY: PS, PG

SHEET TITLE NOTES & SCHEDULES

bcra

CITY OF LAKEWOOD PUBLIC WORKS ENGINEERING DEPARTMENT

APPROVED THIS _____ DAY OF _____,
20___ BY THE CITY OF LAKEWOOD PUBLIC WORKS ENGINEERING
DEPARTMENT

CITY ENGINEER OR DESIGNEE

Know what's below.

Call before you dig.

PLANT SCHEDULE L-109 SCH-B

SYMBOL	QTY	BOTANICAL / COMMON NAME	SIZE	
TREES				
	1	ACER CIRCINATUM 'PACIFIC FIRE' PACIFIC FIRE VINE MAPLE	6'-7' HT, MULTISTEM, B&B	
+	4	ALNUS RUBRA RED ALDER	1 GAL, 12" HT	
	3	ALNUS RUBRA RED ALDER	2" CAL, 10'-12' HT, B&B	
	3	CORNUS NUTTALLII 'EDDIE'S WHITE WONDER' EDDIE'S WHITE WONDER DOGWOOD	3" CAL, BRANCHING AT 6 FT	
SHRUBS				
\bigcirc	10	HOLODISCUS DISCOLOR OCEANSPRAY	1 GAL	
O	10	MAHONIA AQUIFOLIUM OREGON GRAPE	1 GAL	
©	8	PAXISTIMA MYRSINITES OREGON BOXWOOD	2 GAL, 12" HT	
①	18	SPIRAEA BETULIFOLIA 'TOR'	2 GAL	
\odot	70	WHITE FROST™ BIRCHLEAF SPIREA SYMPHORICARPOS ALBUS COMMON WHITE SNOWBERRY	1 GAL	
FERNS/GROUND	COVER/	PERENNIALS		
*	7	CAMASSIA LEICHTLINII GREAT CAMAS	BULB	
$\mathbb{A}^{\left\{ \odot\right\} }$	55	IRIS TENAX OREGON IRIS	BULB	
- 	129	MAHONIA REPENS CREEPING MAHONIA	1 GAL	
SYMBOL	<u>QTY</u>	BOTANICAL / COMMON NAME	SIZE/SPACING	SPACING

4" POT

1 GAL

18" o.c.

18" o.c.


PLANT MIX & SEED MIX SCHEDULE L-109 SCH-B

IRRIGATED AREA	9,067 SF
EROSION CONTROL SEED MIX	5,990 SF
MEADOW - SEED MIX: SUNMARK "NATIVE MEADOW MIX" APPLICATION RATE: 1LB/1000 SF	2,071 SF

NOTE: SEE SHEET L-111 FOR SCH-B: MASTER PLANT & SEED SCHEDULES

T 253.627.4367 F 253.627.2106 PACIFIC AVENUE, SI



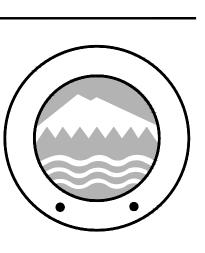

ADS LAKE PARK

REVISIONS

ADDENDUM 1, 11.14.2024

DATE
11-14-24
BCRA NO.

BCRA NO.
21167
DRAWN BY: PS DESIGNED BY: PS, PG

SHEET TITLE
NOTES & PLANT

SCHEDULE

5 bcra
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L-109.1

SCH-A: MASTER PLANT MIX & SEED MIX SCHEDULE

SHORELINE - NATIVE SHRUB MIX CORNUS SERICEA / RED TWIG DOGWOOD HOLODISCUS DISCOLOR / OCEANSPRAY	3,146 SF 22 22	1 GAL, FACW 1 GAL, FACU	18% @ 60" oc 18% @ 60" oc
LONICERA INVOLUCRATA / TWINBERRY	16	1 GAL, FAC	12% @ 60" oc
MYRICA GALE / SWEETGALE ROSA NUTKANA / NOOTKA ROSE	8 16	1 GAL, OBL 1 GAL, FAC	4% @ 48" oc 8% @ 48" oc
RUBUS PARVIFLORUS / THIMBLEBERRY	24	1 GAL, FACU	12% @ 48" oc
SPIRAEA DOUGLASII / WESTERN SPIREA	16	1 GAL, FACW	12% @ 60" oc
SYMPHORICARPOS ALBUS / COMMON WHITE SNOWBERRY	31	1 GAL, FACU	16% @ 48" oc
SHORELINE - NATIVE RUSH MIX CLUSTER SAME SPECIES IN GROUPS OF 5 TO 12	266 SF		
JUNCUS EFFUSUS SPP. PACIFICUS / PACIFIC RUSH	91	10 CU IN PLUG	33% @ 12" oc
SCHOENOPLECTUS ACUTUS / HARDSTEM BULRUSH	91	10 CU IN PLUG	33% @ 12" oc
SCHOENOPLECTUS TABERNAEMONTANI / SOFTSTEM BULRUSH	93	10 CU IN PLUG	34% @ 12" oc

1,806 SF

3,210 SF

315 SF

20,529 SF

12,453 SF

8,508 SF

	NAIN/
 IRRIGATED	

ld APPLICATION RATE: 3 LBS / 1000 SF

īĦ	DOG PARK	SWALE				
	SUNMARK	"SHADE	TOLERANT	BIO-FILTER	MIXTURE"	

TRAIL BUFFER - NATIVE SEED MIX SUNMARK "STREAMBANK PLUS MIX" APPLICATION RATE: 1.5 LBS/1000 SF	
SUNMARK "STREAMBANK PLUS MIX"	
APPLICATION RATE: 1.5 LBS/1000 SF	

MEADOW -	SEED MIX	<u>(:</u>	
SUNMARK	"NATIVE	MEADOW	MIX"

APPLICATION RATE: 1LB/1000 SF

50	NATIVE GR	<u>ASSLAND</u>	MIX			
808	SUNMARK	"NATIVE	GRAS	SLANDS	MI)	X"
	NATIVE GR SUNMARK APPLICATION	ON RATE:	1.0	LBS/10	00	SF

SHORELINE - LOW GROW NATIVE MIX	2,129 SF
SHORELINE - LOW GROW NATIVE MIX 1. APPLY FIRST:: SUNMARK "NATIVE WATER QUALITY MIX" AT APPLICATION RATE OF 21.69 LBS / ACRE. 2. ALLOW ABOVE MIX TO GROW FOR 1 WEEK. 3. THE APPLY SUNMARK "WETLAND PRAIRIE MIX" AT RATE OF 43.66 LBS / ACRE.	
APPLICATION RATE OF 21.69 LBS / ACRE.	
2. ALLOW ABOVE MIX TO GROW FOR 1 WEEK.	
3. THE APPLY SUNMARK "WETLAND PRAIRIE MIX" AT RATE	
OF 43.66 LBS / ACRE.	

PUMP TRACK AREA - SEED MIX	
PUMP TRACK AREA - SEED MIX SUNMARK "SUPREME PLUS MIX" APPLICATION RATE: 4 LRS / 1000 S	
APPLICATION RATE: 4 LBS / 1000 S	F

APPLICATION RATE: 4 LBS / 1000 SF

SEE SHEET L-112 FOR BID ADDITIVE #03 MASTER PLANT & SEED SCHEDULE

MASTER LEGEND

EXISTING RHODODENDRON SHRUBS TO BE PROTECTED AND RETAINED



PROTECTED & RETAINED TRFF DRIP LINE

EXISTING TREES TO BE



MULCH AROUND EXISTING & PROPOSED TREES

ENGINEERED WOOD FIBER



PLAY SURFACING



2"-4" RIVER ROCK SURFACING



——x — POST AND RAIL FENCE, REFER TO CIVIL DETAILS

> TREE PROTECTION FENCING, REFER TO CIVIL DETAILS

- BID ADDITIVE

SCH-A: MASTER SITE FURNISHINGS SCHEDULE

(2) RELOCATED EXISTING PICNIC TABLE

(1) WABASH VALLEY, SIGNATURE COLLECTION 8' ADA TABLE, 2 3/8" LEGS, DIAMOND, COLOR: GREEN

(6) WABASH VALLEY, SIGNATURE COLLECTION 6' BENCH W/ BACK, SURFACE MOUNT, DIAMOND, COLOR: GREEN

(4) WABASH 32 GALLON RECEPTACLE, DIAMOND, COLOR: GREEN

(1) SUPERIOR PET WASTE ELIMINATOR STATION ITEM SKU: E3

(1) PET FOUNTAIN, REFER TO CIVIL

TREE MAINTENANCE AND PRUNING:

TREES RECOMMENDED FOR MAINTENANCE AND APPROVED BY THE OWNER, SHALL BE PRUNED FOR DEADWOOD, LOW HANGING LIMBS, AND PROPER BALANCE, AS RECOMMENDED FOR SAFETY, CLEARANCE, OR AESTHETICS. ALL PRUNING SHALL BE DONE BY AN INTERNATIONAL SOCIETY OF ARBORICULTURE CERTIFIED ARBORIST. ANSI A300 AMERICAN STANDARDS FOR PRUNING SHALL BE USED. LIMBS OF RETAINED TREES WITHIN 10 FEET OR LESS, OF ANY POWER LINE, DEPENDING ON POWER LINE VOLTAGE, MAY ONLY BE PRUNED BY A UTILITY CERTIFIED ARBORIST. THIS PRUNING MUST BE COORDINATED WITH THE LOCAL POWER COMPANY, AS THEY MAY PREFER TO PROVIDE THIS PRUNING.

SAMPLE LAYOUT: SHORELINE - NATIVE SHRUB MIX

SHORELINE SHRUB MIX UPHILL SIDE LAKE SIDE

THE CONTRACT IS TO PROVIDE THE PLANT QUANTITIES SHOWN IN THE PLANT SCHEDULES. PLANT QUANTITIES FOR AREAS HATCHED W/ THE 'SHORELINE NATIVE SHRUB MIX' ARE BASED ON THIS SAMPLE PLANTING LAYOUT

PLANT QUANTITIES FOR 840 S.F.AREA

SAMPLE 840 S.F. PLANTING ZONE

SYMBOL	<u>QTY</u>	BOTANICAL NAME	<u>SIZE</u>	REMARKS
SHRUBS				
+	6	CORNUS SERICEA	1 GAL	FACW
\bigcirc	6	HOLODISCUS DISCOLOR	1 GAL	FACU
\odot	4	LONICERA INVOLUCRATA	1 GAL	FAC
₩	2	MYRICA GALE	1 GAL	OBL
0	4	ROSA NUTKANA	1 GAL	FAC
(+)	6	RUBUS PARVIFLORUS	1 GAL	FACU
	4	SPIRAEA DOUGLASII	1 GAL	FACW
\bigcirc	8	SYMPHORICARPOS ALBUS	1 GAL	FACU

GENERAL GUIDELINES: SHORELINE PLANTING SHRUB DISTRIBUTION BASED ON WETLAND STATUS

OBL	BOTTOM OF SLOPE. CLOSEST TO WATER
FACW	BOTTOM OF SLOPE. CLOSEST TO WATER
FAC	MIDDLE OF SLOPE. OKAY AT BOTTOM & TOP OF SLOPE
FACU	TOP OF SLOPE FURTHEST FROM WATER'S EDGE

NOTES

- 1. CONTRACTOR TO FIELD VERIFY AND STAKE THE LOCATION OF ALL PLANTING AREAS PRIOR TO COMMENCEMENT OF PLANTING.
- 2. INFILL PLANTING TO OCCUR IN AREAS THAT HAVE INVASIVE REMOVAL OR TREE REMOVAL. INVASIVE SPECIES SHALL BE CLEARED AND GRUBBED IN INFILL PLANTING AREAS PRIOR TO INSTALLATION OF NATIVE SPECIES.
- 3. INVASIVE SPECIES SHALL BE CLEARED AND GRUBBED FROM ALL NEW PLANTING AREAS WITHIN THE PARK.
- 4. NO TREES OTHER THAN THOSE SPECIFICALLY CALLED OUT FOR REMOVAL MAY BE REMOVED WITHOUT PRIOR WRITTEN AUTHORIZATION OF THE OWNERS REPRESENTATIVE.
- 5. SHORELINE PLANTINGS SHALL RECEIVE 4" DEPTH OF ARBORIST WOOD CHIP MULCH. ALL OTHER PLANTINGS SHALL RECEIVE 3" DEPTH OF ARBORIST WOOD CHIP MULCH.
- 6. ALL TOPSOIL AND VEGETATION INDICATED FOR REMOVAL OR EXCAVATION SHALL BE FLAGGED OR MARKED FOR APPROVAL BY THE CITY OF LAKEWOOD PRIOR TO REMOVAL.
- 7. CLEARING AND GRUBBING OF INVASIVE SPECIES SHALL BE DONE BY HAND WHERE EXISTING NATIVE VEGETATION IS TO BE RETAINED AND WITHIN THE ROOT ZONE OF TREES TO BE RETAINED.
- 8. VEGETATION AREAS TO BE PRESERVED SHALL BE FENCED FOR PROTECTION DURING CONSTRUCTION USING MINIMUM 4 FOOT HIGH ORANGE MESH BARRICADE FENCING. PROTECTIVE FENCING MUST REMAIN IN PLACE THROUGHOUT THE CONSTRUCTION
- 9. ALL NOXIOUS WEEDS (PER WASHINGTON STATE NOXIOUS WEEDS LIST 2023) SHALL BE REMOVED DURING PLANTING AREA PREPARATION.
- 10. REFER TO DETAIL SHEETS FOR SOIL PREPARATION AND PLANTING.
- 11. HYDROSEEDING SHALL BE COMPLETED PRIOR TO INSTALLATION OF EROSION CONTROL FABRICS. FOLLOW MANUFACTURERS INSTRUCTION FOR INSTALLATION OF
- 12. SITE FURNITURE LOCATIONS TO BE APPROVED IN THE FIELD BY OWNER'S REPRESENTATIVE PRIOR TO INSTALLATION.
- 13. EXISTING PICNIC TABLES SHALL BE REVIEWED WITH OWNER'S REPRESENTATIVE PRIOR TO ANY DEMOLITION WORK. THE BEST THREE TABLES SHALL BE SET SIDE, PROTECTED, AND INSTALLED IN LOCATIONS INDICATED ON LANDSCAPE PLANS.
- 14. ALL WORK WITHIN CRITICAL ROOT ZONES OF EXISTING TREES SHALL BE IN ACCORDANCE WITH TREE PROTECTION PLAN, NOTES, AND DETAIL.


CITY OF LAKEWOOD PUBLIC WORKS ENGINEERING DEPARTMENT


APPROVED THIS DAY OF 20 BY THE CITY OF LAKEWOOD PUBLIC WORKS ENGINEERING DEPARTMENT

CITY ENGINEER OR DESIGNEE





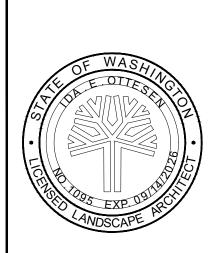

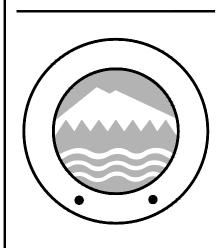

PARK LAKE PROJECT
PHASE 1 & 2
WARD\$
2716 84TH ST
LAKEWOOD, 1

REVIS	REVISIONS				
\triangle	ADDENDUM	1,	11.14.2024		

DATE	
11-14-24	
BCRA NO.	
21167	
DRAWN BY: PS	DESIGNED BY: PS PG

REVIEWED BY: IO
SHEET TITLE
SCH A - NOTES &
MASTER SCHEDULES

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BID SET

BOTANICAL / COMMON NAME

RUBUS CALYCINOIDES 'EMERALD CARPET'

EMERALD CARPET CREEPING BRAMBLE

FRAGARIA CHILOENSIS

BEACH STRAWBERRY
GAULTHERIA SHALLON

SIZE/SPACING

4"POT

1 GAL

4" POT

SPACING

18" o.c.

18" o.c.

18" o.c.

SYMBOL

GROUND COVERS

SCH-B: MASTER PLANT MIX & SEED MIX SCHEDULE

LAWN SEED MIX
IRRIGATED AREA

EROSION CONTROL SEED MIX

9,067 SF

12,588 SF

9,598 SF

MEADOW - SEED MIX:
SUNMARK "NATIVE MEADOW MIX"
APPLICATION RATE: 1LB/1000 SF

SCH-B: MASTER SITE FURNISHINGS SCHEDULE

(1) WABASH VALLEY, SIGNATURE COLLECTION 6' TABLE, 3/8" LEGS, DIAMOND, COLOR: GREEN

(4) WABASH VALLEY, SIGNATURE COLLECTION 8' ADA TABLE, 2 3/8" LEGS, DIAMOND, COLOR: GREEN

(4) WABASH VALLEY, SIGNATURE COLLECTION
6' BENCH W/ BACK, SURFACE MOUNT,
DIAMOND, COLOR: GREEN

(2) WABASH VALLEY, SIGNATURE COLLECTION
6' BENCH W/OUT BACK, SURFACE MOUNT,
DIAMOND, COLOR: GREEN

(2) TABLE WITH FOUR SEATS, 4' X 4'

(2) ADA TABLE WITH THREE SEATS, 4' X 4'

(3) WABASH 32 GALLON RECEPTACLE, DIAMOND, COLOR: GREEN

(2) DUMOR 125-30 BIKE RACK (SURFACE MOUNT)

NOTES

- 1. CONTRACTOR TO FIELD VERIFY AND STAKE THE LOCATION OF ALL PLANTING AREAS PRIOR TO COMMENCEMENT OF PLANTING.
- 2. INFILL PLANTING TO OCCUR IN AREAS THAT HAVE INVASIVE REMOVAL OR TREE REMOVAL. INVASIVE SPECIES SHALL BE CLEARED AND GRUBBED IN INFILL PLANTING AREAS PRIOR TO INSTALLATION OF NATIVE SPECIES.
- 3. INVASIVE SPECIES SHALL BE CLEARED AND GRUBBED FROM ALL NEW PLANTING AREAS WITHIN THE PARK.
- 4. NO TREES OTHER THAN THOSE SPECIFICALLY CALLED OUT FOR REMOVAL MAY BE REMOVED WITHOUT PRIOR WRITTEN AUTHORIZATION OF THE OWNERS REPRESENTATIVE.
- 5. SHORELINE PLANTINGS SHALL RECEIVE 4" DEPTH OF ARBORIST WOOD CHIP MULCH. ALL OTHER PLANTINGS SHALL RECEIVE 3" DEPTH OF ARBORIST WOOD CHIP MULCH.
- 6. ALL TOPSOIL AND VEGETATION INDICATED FOR REMOVAL OR EXCAVATION SHALL BE FLAGGED OR MARKED FOR APPROVAL BY THE CITY OF LAKEWOOD PRIOR TO REMOVAL.
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- 9. ALL NOXIOUS WEEDS (PER WASHINGTON STATE NOXIOUS WEEDS LIST 2023) SHALL BE REMOVED DURING PLANTING AREA PREPARATION.
- 10. REFER TO DETAIL SHEETS FOR SOIL PREPARATION AND PLANTING.
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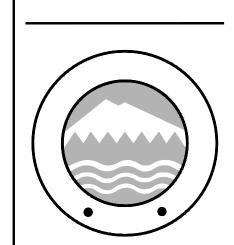
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27.4367 F 253.627.4395 WWW.BCRADESIGN.COM CIFIC AVENUE, SUITE 300, TACOMA, WA 98402 | NAKANO ASSOCIATES IE STREET, SUITE 400 Tel: 2 0 6.2 2 3.0 3 2







DS LAKE PARK

<u> </u>	ADDENDUM	1,	11.14.202
	l		
DATE			
-	14-24		

21167
DRAWN BY: PS DESIGNED BY: PS, PG
REVIEWED BY: IO
SHEET TITLE

BCRA NO.

SCH B - NOTES &
MASTER SCHEDULES

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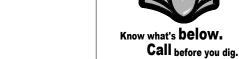
L-111

BID SET

CITY OF LAKEWOOD PUBLIC WORKS ENGINEERING DEPARTMENT

APPROVED THIS _____ DAY OF _____,
20___ BY THE CITY OF LAKEWOOD PUBLIC WORKS ENGINEERING
DEPARTMENT

CITY ENGINEER OR DESIGNEE



BID ADDITIVE #03: MASTER SCHEDULE

	SYMBOL	QTY	BOTANICAL / COMMON NAME	S	<u>IZE</u>		
	TREES +	8	ALNUS RUBRA RED ALDER	1	GAL,	12"	НТ
		3	PICEA SITCHENSIS SITKA SPRUCE	1	GAL		
(+	6	PINUS CONTORTA CONTORTA SHORE PINE	1	GAL		
	+	6	SALIX HOOKERIANA DUNE WILLOW	1	GAL,	12"	HT
($\langle \cdot \rangle$	8	SALIX SITCHENSIS SITKA WILLOW	1	GAL,	12"	НТ

BID ADDITIVE #03: MASTER PLANT MIX & SEED MIX SCHEDULE

SHORELINE - NATIVE SHRUB MIX CORNUS SERICEA / RED TWIG DOGWOOD	7,898 SF 58	1 GAL, FACW	18% @ 60" oc
HOLODISCUS DISCOLOR / OCEANSPRAY	58	1 GAL, FACU	18% @ 60" oc
LONICERA INVOLUCRATA / TWINBERRY	39	1 GAL, FAC	12% @ 60" oc
MYRICA GALE / SWEETGALE	19	1 GAL, OBL	4% @ 48" oc
ROSA NUTKANA / NOOTKA ROSE	40	1 GAL, FAC	8% @ 48" oc
RUBUS PARVIFLORUS / THIMBLEBERRY	58	1 GAL, FACU	12% @ 48" oc
SPIRAEA DOUGLASII / WESTERN SPIREA	39	1 GAL, FACW	12% @ 60" oc
SYMPHORICARPOS ALBUS / COMMON WHITE SNOWBERRY	80	1 GAL, FACU	16% @ 48" oc
SHORELINE - NATIVE RUSH MIX CLUSTER SAME SPECIES IN GROUPS OF 5 TO 12	175 SF		
JUNCUS EFFUSUS SPP. PACIFICUS / PACIFIC RUSH	60	10 CU IN PLUG	33% @ 12" oc
SCHOENOPLECTUS ACUTUS / HARDSTEM BULRUSH	60	10 CU IN PLUG	
SCHOENOPLECTUS TABERNAEMONTANI / SOFTSTEM BULRUSH		10 CU IN PLUG	
EROSION CONTROL SEED MIX	33 SF		
* * * * * * * * * * * * * * * * * * *			
TO ALL DUESED MATINE OFFE MIN	4 400 05		
TRAIL BUFFER - NATIVE SEED MIX SUNMARK "STREAMBANK PLUS MIX"	1,138 SF		
APPLICATION RATE: 1.5 LBS/1000 SF			
7111 E10/111011 11/11E. 1.0 EB3/ 1000 31			
SHORELINE - LOW GROW NATIVE MIX	298 SF		
1. APPLY FIRST:: SUNMARK "NATIVE WATER QUALITY MIX" AT	200 01		
APPLICATION RATE OF 21.69 LBS / ACRE.			
2. ALLOW ABOVE MIX TO GROW FOR 1 WEEK.			
3. THE APPLY SUNMARK "WETLAND PRAIRIE MIX" AT RATE OF 43.66 LBS / ACRE.			
V// OI TO.00 LDS / ACINL.			


SAMP	LE LAYO	DUT: SHORELINE - NA	<u>.T1</u>	VE S	HRUB MIX
	SHORE	LINE SHRUB MIX	_	NOTE:	ONTRACT IS TO
		IPHILL SIDE	F	PROVID	E THE PLANT
			Т	HE PI	TIES SHOWN IN LANT SCHEDULE
12,	X -	\(\frac{1}{2}\frac{1}{			QUANTITIES FOI HATCHED W/
		LAKE SIDE	,	SHORE	LINE NATIVE
		70'	SHRUB MIX' ARE BA ON THIS SAMPLE		
-	•	-	F	PLANTI	NG LAYOUT.
<u>S</u>	AMPLE 840	O S.F. PLANTING ZONE			
PLANT	QUANTITIE	S FOR 840 S.F.AREA			
SYMBOL	QTY	BOTANICAL NAME	<u>SI</u>	<u>IZE</u>	REMARKS
SHRUBS					
+	6	CORNUS SERICEA	1	GAL	FACW
	6	HOLODISCUS DISCOLOR	1	GAL	FACU
\odot	4	LONICERA INVOLUCRATA	1	GAL	FAC
\bowtie	2	MYRICA GALE	1	GAL	OBL
Ŏ	4	ROSA NUTKANA	1	GAL	FAC
\oplus	6	RUBUS PARVIFLORUS	1	GAL	FACU
	4	SPIRAEA DOUGLASII	1	GAL	FACW
\bigcirc	8	SYMPHORICARPOS ALBUS	1	GAL	FACU
	AL CUIDEU	NES: SHORELINE PLANTING			
CENED		ION BASED ON WETLAND STA	ΑΤΙ	JS	
	DISTRIBUT	TOTAL DI TOLLO OTT WETEN THE OTT			
		F SLOPE. CLOSEST TO WATE	ER		
SHRUB	воттом с				
SHRUB OBL	воттом с	F SLOPE. CLOSEST TO WATE	ER	TOP	OF SLOPE


CITY OF LAKEWOOD PUBLIC WORKS ENGINEERING DEPARTMENT

APPROVED THIS _____ DAY OF _____,
20___ BY THE CITY OF LAKEWOOD PUBLIC WORKS ENGINEERING
DEPARTMENT

CITY ENGINEER OR DESIGNEE



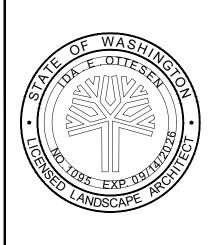

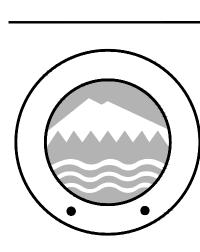

	DDENDUM	1 1,	11.14.2024
DATE			
11-14-	24		
BCRA NO.			
21167			
DRAWN BY	r:PS	DESIG	NED BY: PS, PG

REVIEWED BY: IO
SHEET TITLE
BID ADDITIVE MASTER PLANT LIST

b bcra

